

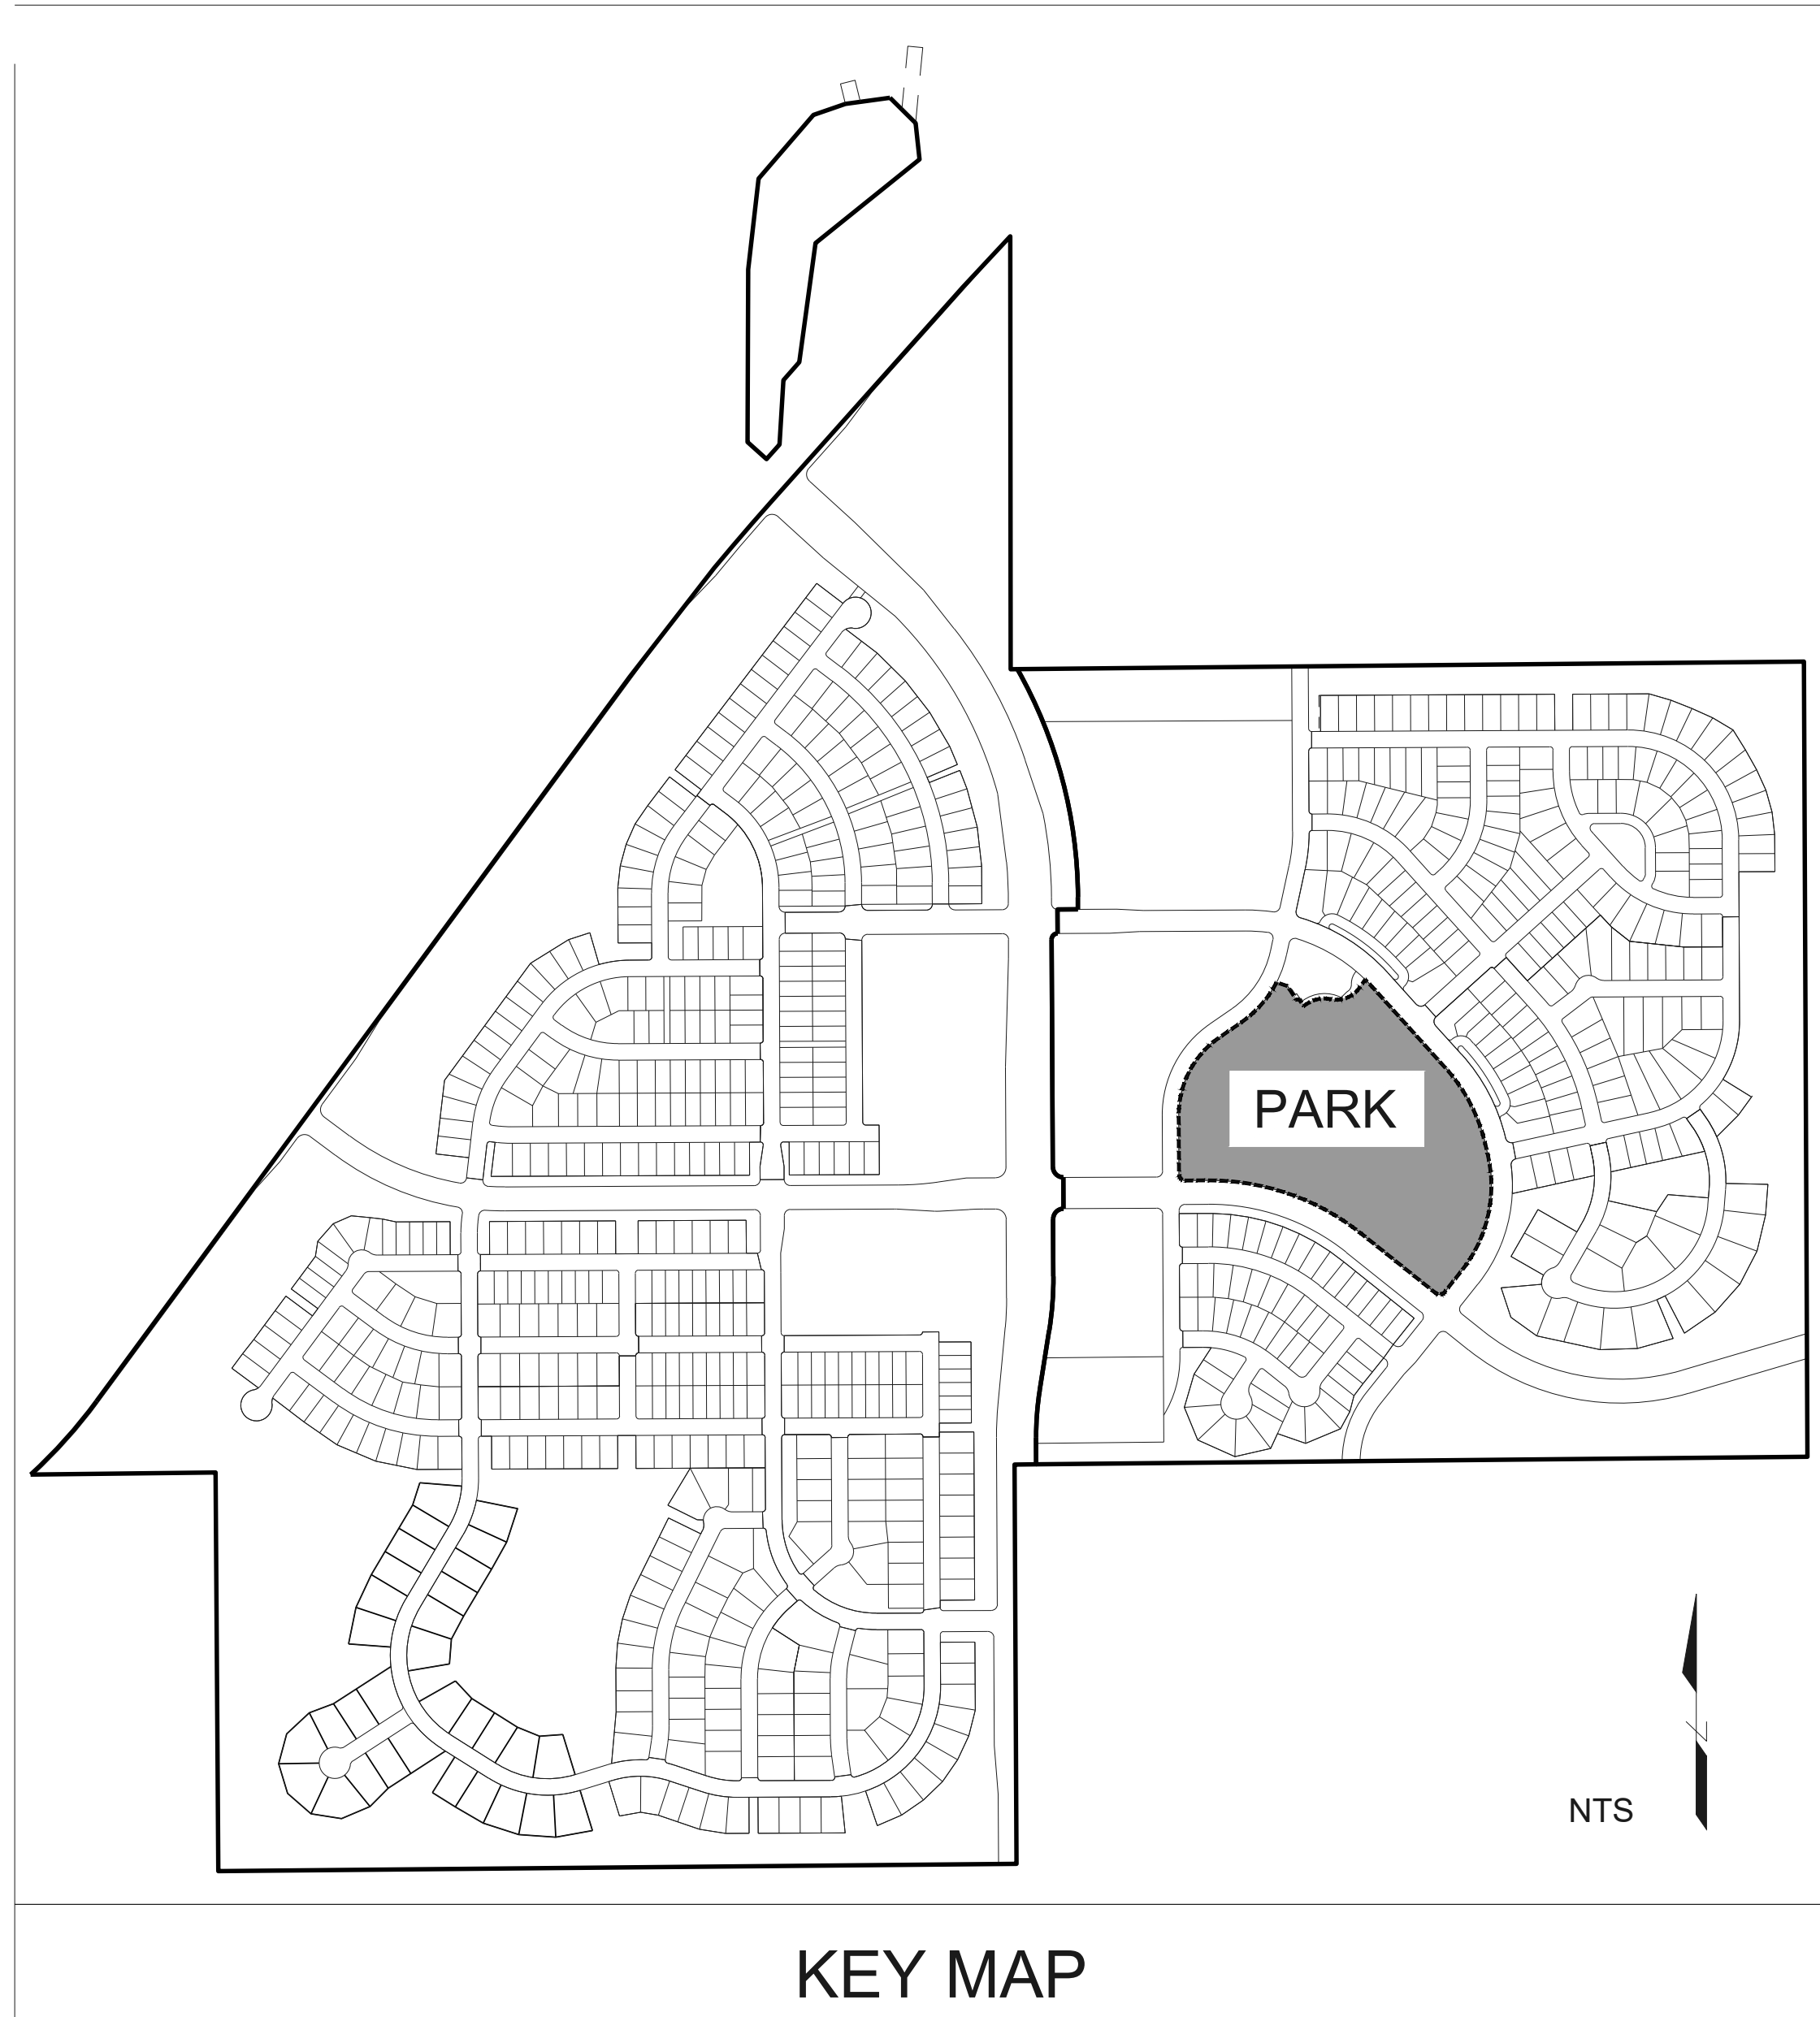


TRAILS AT CROWFOOT

FILING NO. 1 FINAL PARK PLANS

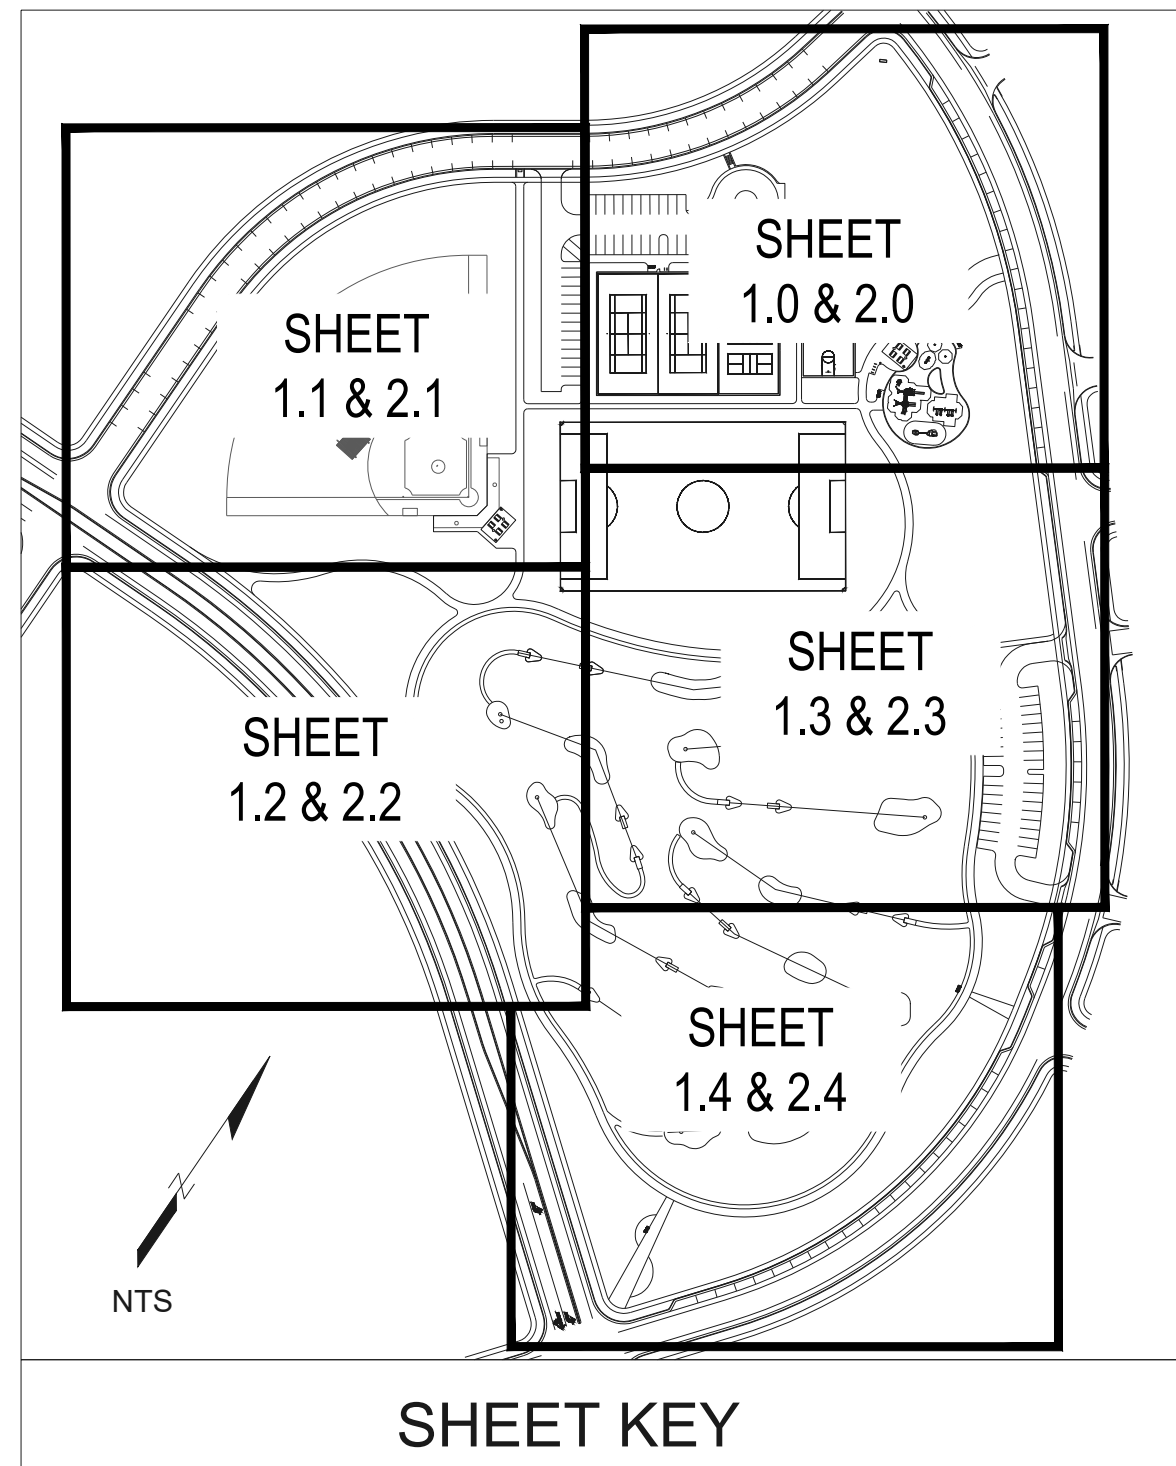

VICINITY MAP

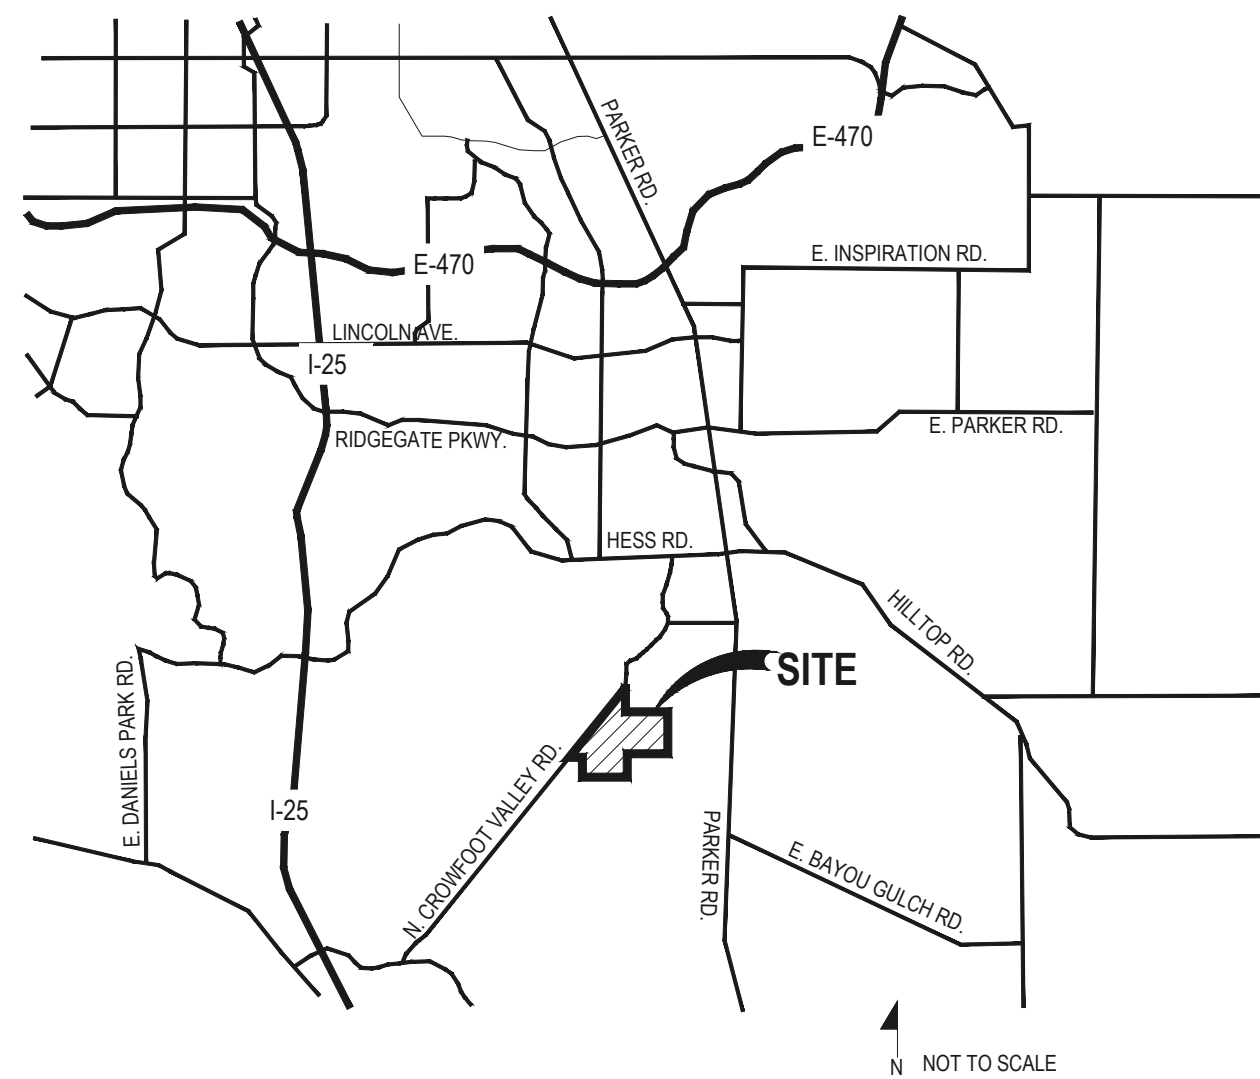

Sheet Number	Sheet Title
L0.0	LANDSCAPE COVER SHEET
L0.1	LANDSCAPE NOTES & PLANT SCHEDULE
L0.2	OVERALL SITE & LANDSCAPE PLAN
L0.3	HORIZONTAL CONTROL PLAN
L0.4	OVERALL GRADING PLAN
L0.5	STORM PLAN
L1.0	AMENITIES PLAN
L1.1	AMENITIES PLAN
L1.2	AMENITIES PLAN
L1.3	AMENITIES PLAN
L1.4	AMENITIES PLAN
L2.0	LANDSCAPE PLAN
L2.1	LANDSCAPE PLAN
L2.2	LANDSCAPE PLAN
L2.3	LANDSCAPE PLAN
L2.4	LANDSCAPE PLAN
L3.0	LANDSCAPE DETAILS
L3.1	LANDSCAPE DETAILS
L3.2	LANDSCAPE DETAILS
L3.3	LANDSCAPE DETAILS
L3.4	LANDSCAPE DETAILS
L3.5	LANDSCAPE DETAILS
L3.6	LANDSCAPE DETAILS
L3.7	LANDSCAPE DETAILS
L3.8	LANDSCAPE DETAILS
IR1.0	IRRIGATION LEGEND AND NOTES
IR1.1	IRRIGATION TAP WORKSHEETS
IR1.2	IRRIGATION PLAN
IR1.3	IRRIGATION PLAN
IR1.4	IRRIGATION PLAN
IR1.5	IRRIGATION PLAN
IR1.6	IRRIGATION PLAN
IR2.1	IRRIGATION DETAILS
IR2.2	IRRIGATION DETAILS
IR2.3	IRRIGATION DETAILS
IR2.4	IRRIGATION DETAILS

KEY MAP

SYMBOLS & ABBREVIATIONS

AC. = ACRE	EXP. = EXPANSION	O.C. = ON CENTER	NOTE IDENTIFICATION
APPROXIMATE = APPROX.	E.W. = EACH WAY	O.D. = OUTSIDE DIAMETER	DEMOLITION NOTE
BBB = BALL AND BURLAP	F.F. = FINISH FLOOR	P.O.B. = POINT OF BEGINNING	CONSTRUCTION NOTE
BOC = BACK OF CURB	F.G. = FINISH GRADE	P.O.C. = POINT OF CONNECTION	ELEVATION IDENTIFICATION
B.M. = BENCH MARK	FIN. = FINISH	P.V.C. = POLYVINYL CHLORIDE	SPOT ELEVATION
BLDG. = BUILDING	F.H. = FIRE HYDRANT	PIPE	ELEVATION
B.S. = BOTTOM OF STAIR	FL = FLOW LINE	PL = PROPERTY LINE	DETAIL IDENTIFICATION
B.W. = BOTTOM OF WALL	FTG. = FOOTING	R = RADIUS	DETAIL NUMBER
CAL. = CALIPER	FT. = FEET	R.C.P. = REINFORCED CONCRETE PIPE	SHEET NUMBER
C.B. = CATCH BASIN	GA. = GAUGE	R.O.W. = RIGHT OF WAY	
CL CATCH BASIN CENTER LINE	GALV. = GALVANIZED	REQD. = REQUIRED	
C.O. = CLEANOUT	H.W. = HEAD WALL	REINF. = REINFORCED	
COL. = COLUMN	H.P. = HIGH POINT	SHIT. = SHEET	
CONC. = CONCRETE	HT. = HEIGHT	SPEC. = SPECIFICATIONS	
CONT. = CONTINUOUS	HORIZ. = HORIZON	SQ. = SQUARE	
CONTR. = CONTRACTOR	I.D. = INNER DIAMETER	S.F. = SQUARE FEET	
C.F. = CUBIC FEET	IN. = INCH	S.V. = SQUARE YARD	
C.Y. = CUBIC YARD	INV. = INVERT	S.S. = STAINLESS STEEL	
DET. = DETAIL	L.P. = LOW POINT	T.C. = TOP OF CURB	
DIM. = DIMENSION	L.F. = LINEAR FEET	T.S. = TOP OF STAIR	
DIA. = DIAMETER	MAX. = MAXIMUM	T.W. = TOP OF WALL	
DWG. = DRAWING	M.H. = MAN HOLE	TYP. = TYPICAL	
EA. = EACH	MIN. = MINIMUM	VERT. = VERTICAL	
ELEV. = ELEVATION	MISC. = MISCELLANEOUS	W/O. = WITH OUT	
EXIST. = EXISTING	N.L.C. = NOT IN CONTRACT	W.W.M. = WOVEN WIRE MESH	
E.P. = EDGE OF PAVING	N.T.S. = NOT TO SCALE		

GENERAL NOTES

- DRAWINGS ARE INTENDED TO BE PRINTED ON 24 X 36 PAPER. PRINTING THESE DRAWINGS AT A DIFFERENT SIZE WILL IMPACT THE SCALE. VERIFY THE GRAPHIC SCALE BEFORE REFERENCING ANY MEASUREMENTS ON THESE SHEETS. THE RECIPIENT OF THESE DRAWINGS SHALL BE RESPONSIBLE FOR ANY ERRORS RESULTING FROM INCORRECT PRINTING, COPYING, OR ANY OTHER CHANGES THAT ALTER THE SCALE OF THE DRAWINGS.
- VERIFY ALL PLAN DIMENSIONS PRIOR TO START OF CONSTRUCTION. NOTIFY THE OWNER'S REPRESENTATIVE TO ADDRESS ANY QUESTIONS OR CLARIFY ANY DISCREPANCIES.
- WRITTEN DIMENSIONS TAKE PRECEDENCE OVER SCALED DIMENSIONS.
- SUBMIT A CHANGE ORDER FOR APPROVAL FOR ANY CHANGES TO WORK SCOPE RESULTING FROM FIELD CONDITIONS OR DIRECTION BY OWNER'S REPRESENTATIVE WHICH REQUIRE ADDITIONAL COST TO THE OWNER PRIOR TO PERFORMANCE OF WORK.
- THE CONTRACTOR SHALL PROVIDE A STAKED LAYOUT OF ALL SITE IMPROVEMENTS FOR INSPECTION BY THE OWNER'S REPRESENTATIVE AND MAKE MODIFICATIONS AS REQUIRED. ALL LAYOUT INFORMATION IS AVAILABLE IN DIGITAL FORMAT FOR USE BY THE CONTRACTOR.
- IF A GEOTECHNICAL SOILS REPORT IS NOT AVAILABLE AT THE TIME OF CONSTRUCTION, PCS GROUP, INC. RECOMMENDS A REPORT BE AUTHORIZED BY THE OWNER AND THAT ALL RECOMMENDATIONS OF THE REPORT ARE FOLLOWED DURING CONSTRUCTION.
- THE CONTRACTOR SHALL USE THESE CONTRACT DOCUMENTS AS A BASIS FOR THE BID. IF THE OWNER ELECTS TO PROVIDE A GEOTECHNICAL REPORT, THE CONTRACTOR SHALL REVIEW THE REPORT AND SUBMIT AN APPROPRIATE CHANGE ORDER TO THE OWNER'S REPRESENTATIVE IF ADDITIONAL COSTS ARE REQUESTED.
- CONTRACTOR SHALL CONFIRM THAT SITE CONDITIONS ARE SIMILAR TO THE PLANS WITHIN TOLERANCES STATED IN THE CONTRACT DOCUMENTS, AND SATISFACTORY TO THE CONTRACTOR PRIOR TO START OF WORK. SHOULD SITE CONDITIONS BE DIFFERENT THAN REPRESENTED ON THE PLANS OR UNSATISFACTORY TO THE CONTRACTOR, THE CONTRACTOR SHALL CONTACT THE OWNER'S REPRESENTATIVE FOR CLARIFICATION AND FURTHER DIRECTION.
- CONTRACTOR IS RESPONSIBLE TO PAY FOR, AND OBTAIN, ANY REQUIRED APPLICATIONS, PERMITTING, LICENSES, INSPECTIONS AND METERS ASSOCIATED WITH WORK.
- THE CONTRACTOR SHALL BE RESPONSIBLE FOR ANY FINES OR PENALTIES ASSESSED TO THE OWNER RELATING TO ANY VIOLATIONS OR NON-CONFORMANCE WITH THE PLANS, SPECIFICATIONS, CONTRACT DOCUMENTS, JURISDICTIONAL CODES AND REGULATORY AGENCIES.
- THE CONTRACTOR SHALL BE RESPONSIBLE FOR COORDINATION OF ALL UTILITY LOCATES PRIOR TO ANY EXCAVATION. NOTIFY OWNER'S REPRESENTATIVE IF EXISTING OR PROPOSED UTILITIES INTERFERE WITH THE ABILITY TO PERFORM WORK.
- UNLESS IDENTIFIED ON THE PLANS FOR DEMOLITION OR REMOVAL, THE CONTRACTOR IS RESPONSIBLE FOR THE COST TO REPAIR UTILITIES, ADJACENT OR EXISTING LANDSCAPE, ADJACENT OR EXISTING PAVING, OR ANY PUBLIC AND PRIVATE PROPERTY THAT IS DAMAGED BY THE CONTRACTOR OR THEIR SUBCONTRACTOR'S OPERATIONS DURING INSTALLATION, ESTABLISHMENT OR DURING THE SPECIFIED MAINTENANCE PERIOD. ALL DAMAGES SHALL BE REPAIRED TO PRE-CONSTRUCTION CONDITIONS AS DETERMINED BY THE OWNER'S REPRESENTATIVE. CONTRACTOR SHALL BE RESPONSIBLE FOR LOGGING ANY DAMAGES PRIOR TO START OF CONSTRUCTION AND DURING THE CONTRACT PERIOD. ANY AREAS OR IMPROVEMENTS DISTURBED OUTSIDE WORK AREA LIMITS SHALL BE RETURNED TO THEIR ORIGINAL CONDITION AT THE CONTRACTOR'S EXPENSE. IN THE EVENT THE CONTRACTOR REQUIRES A MODIFICATION TO THE CONSTRUCTION LIMITS, WRITTEN PERMISSION MUST BE OBTAINED FROM THE OWNER'S REPRESENTATIVE PRIOR TO ANY DISTURBANCE OUTSIDE OF THE LIMITS OF WORK.
- THE CONTRACTOR SHALL BE RESPONSIBLE FOR THE REPAIR OF ANY OF THEIR TRENCHES OR EXCAVATIONS THAT SETTLE.
- THE CONTRACTOR SHALL BE RESPONSIBLE TO PREPARE AND SUBMIT A TRAFFIC CONTROL PLAN TO THE APPROPRIATE JURISDICTIONAL AGENCIES AND THE OWNER'S REPRESENTATIVE IF THEIR WORK AND OPERATIONS AFFECT OR IMPACT THE PUBLIC RIGHTS-OF-WAY. OBTAIN APPROVAL PRIOR TO ANY WORK WHICH AFFECTS OR IMPACTS THE PUBLIC RIGHTS-OF-WAY. THE CONTRACTOR SHALL BE RESPONSIBLE FOR ANY FINES OR PENALTIES ASSESSED TO THE OWNER RELATING TO THIS REQUIREMENT DURING THE CONTRACT PERIOD.
- SIGHT TRIANGLES AND SIGHT LINES SHALL REMAIN UNOBSTRUCTED BY EQUIPMENT, CONSTRUCTION MATERIALS, PLANT MATERIAL OR ANY OTHER VISUAL OBSTACLE DURING THE CONTRACT PERIOD AND AT MATURITY OF PLANTS PER LOCAL JURISDICTIONAL REQUIREMENTS. NO PLANT MATERIAL OTHER THAN GROUND COVER IS ALLOWED TO BE PLANTED ADJACENT TO FIRE HYDRANTS AS STIPULATED BY JURISDICTIONAL REQUIREMENTS.
- COORDINATE SITE ACCESS, STAGING, STORAGE AND CLEAN OUT AREAS WITH OWNER'S REPRESENTATIVE.
- CONTRACTOR IS RESPONSIBLE FOR PROVIDING TEMPORARY SAFETY FENCING AND BARRIERS AROUND ALL IMPROVEMENTS SUCH AS WALLS, PLAY STRUCTURES, EXCAVATIONS, ETC. ASSOCIATED WITH THEIR WORK UNTIL SUCH FACILITIES ARE COMPLETELY INSTALLED PER THE PLANS, SPECIFICATIONS AND MANUFACTURER'S RECOMMENDATIONS.
- CONTRACTOR SHALL BE RESPONSIBLE FOR PROTECTION OF THEIR MATERIAL STOCKPILES CONCRETE IN THE STORM SEWER IS PROHIBITED.
- THE CONTRACTOR SHALL KNOW, UNDERSTAND AND ABIDE BY ANY STORM WATER POLLUTION PREVENTION PLAN (SWPPP) ASSOCIATED WITH THE SITE. IF A STORM WATER POLLUTION PREVENTION PLAN IS NOT PROVIDED BY THE OWNER'S REPRESENTATIVE, REQUEST A COPY BEFORE PERFORMANCE OF ANY SITE WORK.
- CONTRACTOR SHALL MAINTAIN ANY STORM WATER MANAGEMENT FACILITIES THAT EXIST ON SITE FOR FULL FUNCTIONALITY. THE CONTRACTOR SHALL INSTALL AND MAINTAIN ANY NEW STORM WATER MANAGEMENT FACILITIES THAT ARE IDENTIFIED IN THE SCOPE OF WORK TO FULL FUNCTIONALITY. THE CONTRACTOR SHALL BE RESPONSIBLE FOR ANY FINES OR PENALTIES ASSESSED TO THE OWNER FOR FAILURE TO MAINTAIN STORM WATER MANAGEMENT FACILITIES DURING THE CONTRACT PERIOD.
- THE CONTRACTOR SHALL PREVENT SEDIMENT, DEBRIS AND ALL OTHER POLLUTANTS FROM EXITING THE SITE OR ENTERING THE STORM SEWER SYSTEM DURING ALL DEMOLITION OR CONSTRUCTION OPERATIONS THAT ARE PART OF THIS PROJECT. THE CONTRACTOR SHALL BE RESPONSIBLE FOR ANY FINES OR PENALTIES ASSESSED TO THE OWNER RELATING TO THESE REQUIREMENTS DURING THEIR CONTRACTED COURSE OF WORK.
- THE CONTRACTOR SHALL BE RESPONSIBLE TO PREVENT ANY IMPACTS TO ADJACENT WATERWAYS, WETLANDS, OR OTHER ENVIRONMENTALLY SENSITIVE AREAS RESULTING FROM WORK DONE AS PART OF THIS PROJECT. THE CONTRACTOR SHALL BE RESPONSIBLE FOR ANY FINES OR PENALTIES ASSESSED TO THE OWNER RELATING TO THESE STANDARDS DURING THEIR CONTRACTED COURSE OF WORK.
- THE CONTRACTOR AND OR THEIR AUTHORIZED AGENTS SHALL INSURE THAT ALL LOADS OF CONSTRUCTION MATERIAL IMPORTED TO OR EXPORTED FROM THE PROJECT SITE SHALL BE PROPERLY COVERED TO PREVENT LOSS OF MATERIAL DURING TRANSPORT. TRANSPORTATION METHODS ON PUBLIC RIGHT-OF-WAYS SHALL CONFORM TO JURISDICTIONAL REQUIREMENTS. THE CONTRACTOR SHALL BE RESPONSIBLE FOR ANY FINES OR PENALTIES ASSESSED TO THE OWNER RELATING TO THESE REQUIREMENTS.
- THE CLEANING OF EQUIPMENT IS PROHIBITED AT THE JOB SITE UNLESS AUTHORIZED BY THE OWNER'S REPRESENTATIVE IN A DESIGNATED AREA. THE DISCHARGE OF WATER, WASTE CONCRETE, POLLUTANTS, OR OTHER MATERIALS SHALL ONLY OCCUR IN AREAS DESIGNED FOR SUCH USE AND APPROVED BY THE OWNER'S REPRESENTATIVE.

OWNER / DEVELOPER

PLANNER / LANDSCAPE ARCHITECT

CIVIL ENGINEER

ESX MANAGEMENT
7353 SOUTH ALTON WAY
CENTENNIAL, CO 80112



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TRAILS AT CROWFOOT
PARK PLANS
PARKER, COLORADO
LANDSCAPE PLANS

Drawn by:	BEM, GG
Checked by:	PCS STAFF
Submittal Date:	08.01.2017
Call before you dig:	02.27.2018
811	08.20.2020
	10.19.2020
	11.23.2020
	03.16.2022

Sheet Name

LANDSCAPE COVER SHEET

Sheet Number

L0.0

LANDSCAPE NOTES

SITE PREP

- LANDSCAPE CONTRACTOR TO REFERENCE CIVIL ENGINEERING DRAWINGS REGARDING DRAINAGE AND EROSION CONTROL NOTES, DETAILS AND PROCEDURES.
- ALL WORK SHALL CONFORM TO LOCAL MUNICIPAL CODES. ALL WORK SHALL BE IN ACCORDANCE WITH OSHA CODES AND STANDARDS. NOTHING INDICATED ON THE LANDSCAPE DRAWINGS SHALL RELIEVE THE CONTRACTOR FROM COMPLYING WITH ANY APPROPRIATE SAFETY REGULATIONS.
- ALL UTILITY EASEMENTS SHALL REMAIN UNOBSTRUCTED AND FULLY ACCESSIBLE ALONG THEIR ENTIRE LENGTH FOR USE OF MAINTENANCE EQUIPMENT ENTRY.
- SEE CIVIL ENGINEER'S DRAWINGS FOR GRADING AND DRAINAGE, EROSION CONTROL, PAVING AND SLEEVES, UTILITIES, AND OTHER ENGINEERED DETAILS.
- CONTRACTOR SHALL ENSURE POSITIVE DRAINAGE AWAY FROM ALL STRUCTURES.
- A PRE-CONSTRUCTION MEETING MAY BE REQUIRED BETWEEN THE LANDSCAPE CONTRACTOR, PROPERTY OWNER AND LANDSCAPE ARCHITECT BEFORE START OF CONSTRUCTION.
- CONTRACTOR SHALL MINIMIZE ALL DISTURBANCE TO NON-IMPACTED AREAS.
- SITE MUST BE CLEAN AND FREE OF ALL CONSTRUCTION DEBRIS BEFORE FINAL ACCEPTANCE.
- CONTRACTOR IS RESPONSIBLE FOR SETUP OF BARRICADES, WARNING SIGNAGE, OR OTHER PROTECTIVE DEVICES IF ANY EXCAVATIONS ARE LEFT EXPOSED AFTER ON-SITE WORK HOURS.
- IT IS THE CONTRACTOR'S RESPONSIBILITY TO ACQUIRE ALL NECESSARY PERMITS FOR CONSTRUCTION WORK WITHIN THE LOCAL JURISDICTION. A SEPARATE LANDSCAPE CONSTRUCTION PERMIT IS REQUIRED AND USE AND SALES TAX WILL BE COLLECTED. WATER CONNECTION FEES ARE TO BE PAID PRIOR TO THE METER SETTING. A BACK FLOW PERMIT AND INSPECTION IS REQUIRED PRIOR TO THE METER BEING INSTALLED IN THE VAULT.
- TOPSOIL IS TO BE STRIPPED & STOCKPILED ON-SITE FOR LATER USE.
- CONTRACTOR IS RESPONSIBLE FOR REPLACEMENT OF ANY EXISTING OR NEW SITE IMPROVEMENTS DISTURBED OR DAMAGED DUE TO THEIR OPERATIONS. DAMAGED MATERIALS SHALL BE REPLACED/REPAIRED TO ITS PRIOR CONDITION.
- LOCATE ALL UTILITIES PRIOR TO ANY DIGGING OR LANDSCAPE PLANTING. CONTRACTOR SHALL HAND DIG ALL PLANTING PITS ADJACENT TO UTILITIES. IF UTILITIES ARE DAMAGED, REPAIRS SHALL BE MADE AT THE CONTRACTOR'S EXPENSE.
- PRIOR TO INSTALLATION OF PLANT MATERIALS, AREAS THAT HAVE BEEN COMPACTED OR DISTURBED BY CONSTRUCTION ACTIVITY SHALL BE THOROUGHLY LOOSENEED & AMENDED.
- SOIL PREPARATION SHALL BE PROVIDED ON ALL AREAS TO BE SEEDED, SOODED, OR OTHERWISE PLANTED. ROUGH MULCH FOR SOIL PREPARATION SHALL BE A MIXTURE OF TWENTY-FIVE PERCENT (25%) GROUND AGED MANURE AND SEVENTY-FIVE PERCENT (75%) ORGANIC COMPOST, AND SHALL CONTAIN A MINIMUM OF TWENTY-FIVE PERCENT (25%) ORGANIC MATTER. THE MIXTURE SHALL BE FREE FROM CLAY SUBSOIL, MOUNTAIN PEAT, SAND, GYPSSUM, STONES, LUMPS, PLANTS OR THEIR ROOTS, STICKS, WEED STOLONS, AND SEEDS, HIGH SALT CONTENT AND OTHER MATERIALS HARMFUL TO PLANT LIFE. THE MANURE AND ORGANIC COMPOST SHALL BE COARSELY GROUND AND THOROUGHLY MIXED TOGETHER TO ENSURE AN EVEN COMPOSITION. THE MIX SHALL HAVE AN ACIDITY IN THE RANGE OF PH 5.5 TO PH 8.0, A CARBON TO NITROGEN RATIO RANGING FROM 15:1 TO 30:1, SALT LEVELS OF LESS THAN 6 MMHOS/CM, AND SHALL MEET THE FOLLOWING MECHANICAL ANALYSIS:

	%PASSING	% RETAINED
2" SCREEN	100	0
1" SCREEN	90-100	0-10
1/2" SCREEN	50-80	20-50

UPON THE REQUEST OF THE TOWN, THE FOLLOWING INFORMATION SHALL BE PROVIDED:

- SPECIFIC LOCATIONS FROM WHICH THE MANURE AND ORGANIC COMPOST WERE OBTAINED
- AGRICULTURAL TEST RESULTS SHOWING MIXTURE COMPOSITION AND ANALYSIS

TESTING SHALL BE BY A QUALIFIED SOIL LABORATORY, IN ACCORDANCE WITH ACCEPTED SOIL AMENDMENT TESTING PROCEDURES, AND TESTING SHALL BE AT THE CONTRACTOR'S EXPENSE. THE SOIL AMENDMENTS SHALL BE INCORPORATED IN THE FOLLOWING MANNER: UPON ESTABLISHMENT OF PROPER GRADES, THE SOIL SURFACE SHALL BE LOOSENEED BY ROTOTILLING TO A MINIMUM DEPTH OF SIX INCHES (6"), AND ALL MATERIALS OVER SIX INCHES (2") IN DIAMETER SHALL BE REMOVED. THE MANURE AND ORGANIC COMPOST MIXTURE SHALL BE EVENLY SPREAD OVER THE AREA AT THE RATE OF SIX (6) CUBIC YARDS PER THOUSAND SQUARE FEET, AND SHALL BE MIXED THOROUGHLY INTO THE SOIL SURFACE TO A DEPTH OF SIX INCHES (6") BY MEANS OF A ROTOTILLER, SOIL MIXER OR SIMILAR APPARATUS. THE SURFACE SHALL THEN BE FINISH GRADED TO THE APPROPRIATE ELEVATIONS AND COMPACTION. PRIOR TO SEEDING OR SODDING, FERTILIZER WITH A 10-10-10 OR COMPARABLE RATIO SHALL BE SPREAD EVENLY OVER THE SURFACE AT THE RATE OF FIVE (5) POUNDS PER THOUSAND SQUARE FEET (12 POUND OF ACTUAL NITROGEN PER 1000 SQUARE FEET)

TOPSOILS

ADDITION OF TOPSOIL IS NOT CONSIDERED A PORTION OF THE ORDINARY SOIL PREPARATION OPERATIONS AS DESCRIBED IN THESE SPECIFICATIONS. HOWEVER, THE USE OF GOOD TOPSOIL IS HIGHLY DESIRABLE, AND MAY EQUAL THE VALUE OF SOIL AMENDMENTS IN REDUCING WATER CONSUMPTION AND ENCOURAGING PLANT GROWTH. WHEN TOPSOIL EXISTS ON THE PROJECT SITE, THE CONTRACTOR WILL BE REQUIRED TO STRIP AND STOCKPILE THE TOPSOIL, AND TO REDISTRIBUTE THE TOPSOIL OVER THE OPEN SPACE AREAS AFTER OVERLIFT GRADING. IN ACCORDANCE WITH THESE SPECIFICATIONS, THE TOPSOIL IS THE PRIVILEGE OF DELETING ALL OR A PORTION OF THE TOPSOIL PREPARATION REQUIREMENTS WHEN TOPSOIL IS PROVIDED, DEPENDING ON TOPSOIL QUALITY AND QUANTITY. TOPSOIL SHALL BE A FERTILE SANDY LOAM TOPSOIL, TAKEN FROM A WELL-DRAINED SITE, AND FREE FROM CLAY SUBSOIL, STONES, LUMPS, PLANTS OR THEIR ROOTS, STICKS, WEED STOLONS AND SEEDS, HIGH SALT CONTENT AND OTHER MATERIALS HARMFUL TO PLANT LIFE. THE TOPSOIL SHALL HAVE AN ACIDITY IN THE RANGE OF PH 5.5 TO PH 8.0, SALT LEVELS OF LESS THAN 6 MMHOS/CM, AND SHALL BE SCREENED AND MEET THE FOLLOWING MECHANICAL ANALYSIS:

	%PASSING	%RETAINED
1" SCREEN	100	0
1/2" SCREEN	97-100	0-3
#100 MESH SIEVE	60-40	40-60

UPON THE REQUEST OF THE TOWN, THE FOLLOWING INFORMATION SHALL BE PROVIDED:

- SPECIFIC LOCATION FROM WHICH TOPSOIL WILL BE (OR WAS) STRIPPED
- AGRICULTURAL TEST RESULTS SHOWING TOPSOIL COMPOSITION AND ANALYSIS

TESTING SHALL BE BY A QUALIFIED SOILS LABORATORY, IN ACCORDANCE WITH METHODS OF SOILS ANALYSIS

- AGRONOMY #9# AS PUBLISHED BY THE AMERICAN SOCIETY OF AGRONOMY, AND TESTING WILL BE DONE AT THE CONTRACTOR'S EXPENSE.

WHEN THE ADDITION OF TOPSOIL IS REQUIRED BY THE OFFICIAL DEVELOPMENT PLAN AND/OR APPROPRIATE CONSTRUCTION DRAWINGS, OR WHEN THE CONTRACTOR OPTS TO PROVIDE TOPSOIL, IT SHALL BE INCORPORATED IN THE FOLLOWING MANNER:
UPON ESTABLISHMENT OF THE PROPER GRADE, THE SUBSOIL SURFACE SHALL BE LOOSENEED TO A MINIMUM DEPTH OF SIX INCHES (6") BY TILLING, AND ALL OBJECTS OVER TWO INCHES (2") IN DIAMETER SHALL BE REMOVED. THE TOPSOIL SHALL BE SPREAD OVER THE AREA TO A MINIMUM FOUR INCH (4") COMPACTED DEPTH, AND MIXED LIGHTLY INTO THE SUBSOIL BY MEANS OF A ROTOTILLER, SOIL MIXER OR SIMILAR. THE SURFACE LAYER SHALL THEN BE FINISH GRADED TO THE APPROPRIATE ELEVATIONS AND COMPACTION.

- #100 MESH SIEVE 0-15 85-100CONTRACTOR SHALL SUBMIT SOIL AMENDMENT SPECIFICATIONS FOR APPROVAL PRIOR TO INSTALLATION.
- THE LANDSCAPE CONTRACTOR SHALL BE RESPONSIBLE FOR ENSURING POSITIVE DRAINAGE EXISTS IN ALL LANDSCAPE AREAS. SURFACE DRAINAGE ON LANDSCAPE AREAS SHALL NOT FLOW TOWARD STRUCTURES AND FOUNDATIONS. MAINTAIN SLOPE AWAY FROM FOUNDATIONS PER THE GEOTECH REPORT RECOMMENDATIONS.

FINE GRADING NOTES

- SLOPES NOT TO EXCEED 4:1 MAX. 1% MIN.
- SATISFACTORY SOILS: ASTM D 2487 SOIL CLASSIFICATION GROUPS GW, GP, GM, SW, SP, AND SM, OR A COMBINATION OF THESE GROUP SYMBOLS, FREE OF ROCK OR GRAVEL LARGER THAN 3 INCHES (75 MM) IN ANY DIMENSION, DEBRIS, WASTE, FROZEN MATERIALS, VEGETATION, AND OTHER DELETERIOUS MATTER.
- STRIP TOPSOIL TO WHATEVER DEPTHS ARE ENCOUNTERED IN A MANNER TO PREVENT INTERMINGLING WITH UNDERLYING SUBSOIL OR OTHER WASTE MATERIALS.
- STRIP EXISTING SURFACES OF UNSUITABLE TOPSOIL, INCLUDING TRASH, DEBRIS, WEEDS, ROOTS, AND OTHER WASTE MATERIALS.
- STOCKPILE TOPSOIL MATERIALS ON-SITE WITHOUT INTERMINGLING WITH SUBSOIL.
- REMOVE EXISTING VEGETATION, DEBRIS, UNSATISFACTORY SOIL MATERIALS, OBSTRUCTIONS, AND DELETERIOUS MATERIALS FROM GROUND SURFACE BEFORE PLACING FILLS.
- PLOW, SCARIFY, BENCH, OR BREAK UP SLOPED SURFACES STEEPER THAN 1 VERTICAL TO 4 HORIZONTAL SO FILL MATERIAL WILL BOND WITH EXISTING MATERIAL.
- PLACE AND COMPACT FILL MATERIAL IN LAYERS TO REQUIRED CROSS-SECTIONS, ELEVATIONS AND GRADES WITH SATISFACTORY SOIL MATERIAL.
- UNIFORMLY GRADE AREAS TO A SMOOTH SURFACE, FREE FROM IRREGULAR SURFACE CHANGES. COMPLY WITH COMPACTION REQUIREMENTS AND GRADE TO CROSS-SECTIONS, LINES, AND ELEVATIONS INDICATED.
- PROVIDE A SMOOTH TRANSITION BETWEEN ADJACENT EXISTING GRADES AND NEW GRADES.
- CUT OUT SOFT SPOTS, FILL LOW SPOTS AND TRIM HIGH SPOTS TO COMPLY WITH REQUIRED SURFACE TOLERANCES.

SEEDING ESTABLISHMENT NOTES:

- SEED SHALL BE LABELED IN ACCORDANCE WITH THE U.S. DEPARTMENT OF AGRICULTURE, RULES AND REGULATIONS AND FEDERAL SEED ACT. SEED SHALL BE EQUAL IN QUALITY TO THE STANDARDS FOR "CERTIFIED SEED" AND SHALL BE FURNISHED IN SEALED, UNOPENED, STANDARD CONTAINERS. SEED SHALL BE FRESH, CLEAN, PURE LIVE SEED WITH THE VARIETIES MIXED IN PROPORTIONS BY WEIGHT SHOWN AND MEETING THE MINIMUM PERCENTAGES OF PURITY AND GERMINATION SPECIFIED.
- SEED SHALL BE APPLIED AT A RATE SHOWN BY MIX. SEED SHALL PASS GOVERNMENT TEST OF GERMINATION OF EIGHTY PERCENT (80%) AND FOR PURITY OF NINETY PERCENT (90%). THE PURE LIVE SEED SHALL BE NOT LESS THAN SIXTY SEVEN (67%) FOR ANY ONE VARIETY, WITH THE AVERAGE OF THE MIXTURE, NO LESS THAN SEVENTY TWO PERCENT (72%). ALL SEED SHALL BE FREE OF POA ANNIA AND ALL NOXIOUS OBJECTIONABLE WEEDS WITH A MAXIMUM CROP OF ONE-TENTH PERCENT (0.1%) AND MAXIMUM WEED OF ONE TENTH PERCENT (0.1%). IF SEED AVAILABLE ON THE MARKET DOES NOT MEET THE MINIMUM PURITY AND GERMINATION PERCENTAGES SPECIFIED, THE CONTRACTOR MUST COMPENSATE BY FURNISHING SUFFICIENT ADDITIONAL SEED TO EQUAL THE SPECIFIED PRODUCT.
- SPREAD ORGANIC SOIL AMENDMENT MATERIALS, AT A RATE OF 4 CY. PER 1000 SQUARE FEET, EVENLY OVER ENTIRE DISTURBED AREA AND THOROUGHLY INCORPORATE, BY MIXING, ROTOTILLING OR FINELY DISKING (MAX. 1" SIZE), TO A DEPTH OF SIX INCHES. ALL STONES, STICKS AND DEBRIS BROUGHT TO THE SURFACE SHALL BE REMOVED FROM THE SITE PROPERLY DISPOSED OF BY THE CONTRACTOR, AT NO ADDITIONAL COST TO THE OWNER. ALL SEED AREAS WILL THEN BE RAKED AND ROLLED TO THE DESIRED FINISHED GRADES WITH GENTLY SLOPING SURFACES TO ADEQUATELY DRAIN ALL SURFACE WATER RUNOFF. THE FINISHED SURFACE SHALL BE EVEN AND UNIFORM AND NO DIRT CLODS LARGER THAN ONE INCH (1") IN DIAMETER SHALL APPEAR ON THE SURFACE. THE SOIL SURFACE SHALL BE SMOOTH, LOOSE AND OF FINE TEXTURE, AND BE FLUSH WITH ALL PAVING EDGES.
- CONTRACTOR SHALL USE APPROPRIATE MECHANICAL POWER (BRILLION SEEDER OR EQUAL) TO DRILL THE SEED INTO THE SEEDBED WHEREVER POSSIBLE. SEED SHALL BE SOWN TO A DEPTH OF ONE-HALF INCH (1/2"). DRILLING SHALL BE DONE IN 2 SEPARATE APPLICATIONS CROSSING THE AREA AT RIGHT ANGLES TO ONE ANOTHER TO GUARANTEE PROPER COVERAGE. ON SLOPING LAND, SEEDING OPERATIONS SHALL FOLLOW THE GENERAL CONTOUR. AREAS TOO SMALL TO DRILL SEED MAY BE BROADCAST BY HAND AND APPLICATION RATES SHALL BE DOUBLED. SEEDINGS OF ANY KIND WILL NOT BE PERMITTED WHEN WIND VELOCITY IS SUCH AS TO PREVENT UNIFORM SEED DISTRIBUTION. NO APPLICATION SHALL TAKE PLACE WITH THE PRESENCE OF FREE SURFACE WATER WHEN GROUND IS FROZEN OR CANNOT BE TILLED. ADDITIONAL TOPICAL OVER SEEDING MAY BE APPLIED TO PREVIOUSLY SEEDED AREAS IN ORDER TO ACHIEVE ADEQUATE GROUND COVER AND EROSION RESISTANCE.
- SEEDED AREAS MAY REQUIRE TEMPORARY ABOVE GROUND SPRAY IRRIGATION UNTIL ESTABLISHMENT. IRRIGATION SHALL BE REMOVED UPON ACCEPTANCE BY THE CITY. WHERE STEEP SLOPES OCCUR, LANDSCAPE CONTRACTOR MAY REQUIRE VARIOUS METHODS OF TEMPORARY IRRIGATION TO ACHIEVE SEED ESTABLISHMENT. SUCH METHODS SHALL BE IN COMPLIANCE WITH THE PROJECT'S EROSION CONTROL METHODS, BMPs AND ALL CITY CODES AND REQUIREMENTS.

ALL LANDSCAPE AREAS BETWEEN WALKS AND CURBS SHALL DRAIN FREELY TO THE CURB UNLESS OTHERWISE IDENTIFIED ON THE GRADING PLAN. IN NO CASE SHALL THE GRADE, TURF THATCH, OR OTHER LANDSCAPE MATERIALS DAM WATER AGAINST WALKS. MINIMUM SLOPES ON LANDSCAPE AREAS SHALL BE 2%, MAXIMUM SLOPE SHALL BE 25% UNLESS SPECIFICALLY IDENTIFIED ON THE PLANS OR APPROVED BY LANDSCAPE ARCHITECT.

TURF PLANT & GROUND COVER MATERIAL

- ANY SUBSTITUTION OR ALTERATION OF PLANT OR LANDSCAPE MATERIALS IN LOCATION, SPECIES, TYPE, ETC. SHALL BE ALLOWED ONLY WITH APPROVAL OF THE LANDSCAPE ARCHITECT. OVERALL PLANT QUANTITY AND QUALITY TO BE CONSISTENT WITH APPROVED PLANS.
- ALL PLANT MATERIALS SHALL BE IN ACCORDANCE WITH AAN SPECIFICATIONS FOR NUMBER ONE GRADE.
- PROPOSED TREE LOCATIONS SHALL HAVE A MINIMUM SEPARATION OF 4' BETWEEN WATER OR SEWER SERVICE LINES AND A MINIMUM SEPARATION OF 10' BETWEEN WATER OR SEWER MAIN LINES. PROPOSED TREE LOCATIONS SHALL HAVE A MINIMUM SEPARATION OF 4' BETWEEN GAS LINES.
- ALL PROPOSED IRRIGATED TURF AREAS SHALL BE SOODED WITH THE BLEND SPECIFIED IN THESE PLANS. SOD SHALL BE LAID ON A FIRM BED WITH TIGHT JOINTS AND WITHOUT VOIDS.
- TREE WRAP TO BE APPLIED IN LATE FALL AFTER INSTALLATION, AND REMOVED THE FOLLOWING SPRING. REMOVE ANY STRING OR WIRE AROUND TREE TRUNKS AT TIME OF INSTALLATION.
- CONTRACTOR SHALL REPORT ANY DISCREPANCY FOUND IN THE FIELD VERSUS THE LANDSCAPE DRAWINGS IMMEDIATELY TO THE LANDSCAPE ARCHITECT, OWNERS REPRESENTATIVE, AND/OR THE CITY/COUNTY PRIOR TO ANY CONSTRUCTION OR DEMOLITION ACTIVITY. FAILURE TO MAKE SUCH CONFLICTS KNOWN WILL RESULT IN THE CONTRACTOR'S LIABILITY TO RELOCATE AND REPAIR.
- MAINTAIN A MINIMUM THREE FOOT CLEARANCE AROUND FIRE HYDRANTS, FIRE DEPARTMENT CONNECTIONS OR OTHER FIRE SERVICE EQUIPMENT. NO TREES OR SHRUBS WILL BE ALLOWED WITHIN THIS AREA.
- TREES SHALL NOT BE LOCATED IN DRAINAGE SWALES, AREAS OR UTILITY EASEMENTS. CONTACT LANDSCAPE ARCHITECT FOR RELOCATION OF PLANTS IN QUESTIONABLE AREAS PRIOR TO INSTALLATION.
- THE CENTER OF EVERGREEN TRESS SHALL NOT BE PLACED CLOSER THAN 8' AND THE CENTER OF ORNAMENTAL TRESS CLOSER THAN 6' FROM A SIDEWALK, STREET OR DRIVE LANE. EVERGREEN TREES SHALL NOT BE LOCATED ANY CLOSER THAN 15' FROM IRRIGATION ROTOR HEADS. NOTIFY LANDSCAPE ARCHITECT IF TREE LOCATIONS CONFLICT WITH THESE STANDARDS FOR FURTHER DIRECTION.
- ALL EVERGREEN TREES SHALL BE FULLY BRANCHED TO THE GROUND AND SHALL NOT EXHIBIT SIGNS OF ACCELERATED GROWTH AS DETERMINED BY LANDSCAPE ARCHITECT.
- NO PLANT MATERIAL SHALL BE PLANTED WITHIN 10' OF ANY EXISTING OR PROPOSED ELECTRICAL SWITCHGEARS, TRANSFORMERS OR OTHER ELECTRICAL UTILITY EQUIPMENT. PLANT MATERIAL MAY BE FIELD ADJUSTED TO PROVIDE THE 10' CLEAR SPACE AND ACCESSIBILITY REQUIRED BY THE UTILITY'S OWNER/OPERATOR.
- ANY TREES INSTALLED ABOVE RETAINING WALLS UTILIZING GEO-GRID MUST BE DUG TO PROTECT GEO-GRID. IF GEO-GRID MUST BE CUT TO INSTALL TREES, APPROVAL MUST BE GIVEN BY LANDSCAPE ARCHITECT PRIOR TO DOING WORK.
- PROPOSED PLANT SPECIES MAY BE SUBJECT TO CHANGE PENDING COMMERCIAL AVAILABILITY AT TIME OF CONSTRUCTION. ALL SPECIES SUBSTITUTIONS SHALL BE APPROVED BY THE LANDSCAPE ARCHITECT. TREE SIZES SHALL REMAIN AS INDICATED ON THE PLANT SCHEDULE. CONTRACTOR SHALL VERIFY THAT ANY SUBSTITUTED PLANT SPECIES ARE ACCEPTABLE TO THE LOCAL MUNICIPALITY OR GOVERNING JURISDICTIONS.
- IF SPECIFIED PLANTS ARE NOT COMMERCIALY AVAILABLE AT TIME OF CONSTRUCTION/INSTALLATION, CONTRACTOR SHALL COORDINATE WITH LANDSCAPE ARCHITECT FOR A SUBSTITUTION.

PLANTING BEDS

- ALL PROPOSED PLANTING BEDS SHALL CONTAIN THE SPECIFIED MULCH. ROCK MULCH BEDS SHALL INCLUDE MIRAFI WEED BARRIER FABRIC OR EQUAL SECURED WITH PINS. OVERLAP FABRIC MIN. 24" AT EDGES. NO FABRIC IS REQUIRED IN WOOD MULCH AREAS. ROCK MULCH AROUND VEGETATION SHALL CONTAIN 1 1/2" DIA. ROUND RIVER COBBLE, TAN COLOR, 4" DEPTH.
- WOOD MULCH SHALL BE "GORILLA HAIR" OR EQUAL SHREDED CEDAR MULCH, 4" DEPTH.
- EDGING BETWEEN TURF AND PLANTING BEDS SHALL BE 12-GAUGE, GREEN COLOR, ROLLED-TOP, STEEL EDGING OR EQUIVALENT. ANY NO EDGING IS REQUIRED AGAINST HARDSCAPE/WALK AREAS OR AT TREE RING EDGES. EDGING SHALL BE INSTALLED TO AVOID IMPEDING DRAINAGE. RE: DETAILS FOR INSTALLATION IN LOW DRAINAGE AREAS.
- FOR TREES NOT IN PLANTING BEDS, ALLOW A 6'-0" DIAMETER BED (TREE RING) WITHOUT SOD AROUND ROOT COLLAR. APPLY SPECIFIED WOOD MULCH & DEPTH WITHIN 30" OF TREE TRUNKS. THE SURFACE SHALL THEN BE FINISH GRADED TO THE APPROPRIATE ELEVATIONS AND COMPACTION. PRIOR TO SEEDING OR SODDING, FERTILIZER WITH A 10-10-10 OR COMPARABLE RATIO SHALL BE SPREAD EVENLY OVER THE SURFACE AT THE RATE OF FIVE (5) POUNDS PER THOUSAND SQUARE FEET (12 POUND OF ACTUAL NITROGEN PER 1000 SQUARE FEET)
- ALL PLANTING BEDS SHALL BE CROWNED WITH AMENDED TOPSOIL FOR DRAINAGE.

HARDSCAPE

- REFER TO SITE PLANS & DETAILS FOR SPECIALTY CONCRETE LOCATIONS WHERE APPLICABLE.

IRRIGATION

- PERMANENT UNDERGROUND IRRIGATION IS REQUIRED IN ALL LANDSCAPE AREAS. 2) TURF AREAS ARE ZONED SEPARATELY FROM BED AREAS. 3) CONTROLLER TO INCLUDE RAIN SHUT-OFF. 4) HYDROZONES WILL BE ON SEPARATE IRRIGATION ZONES ACCORDING TO WATER DEMAND.
- REFER TO IRRIGATION PLANS FOR LIMITS AND TYPES OF IRRIGATION DESIGNED FOR THE LANDSCAPE. IN NO CASE SHALL IRRIGATION BE EMITTED WITHIN THE MINIMUM STANDARDS FROM BUILDING OR WALL FOUNDATIONS AS STIPULATED IN THE GEOTECHNICAL REPORT. ALL IRRIGATIONS DISTRIBUTION LINES, HEADS AND EMITTERS SHALL BE KEPT OUTSIDE THE MINIMUM DISTANCE AWAY FROM ALL BUILDING AND WALL FOUNDATIONS AS STIPULATED IN THE GEOTECH REPORT.
- TURF & IRRIGATED NATIVE AREAS (WHERE APPLICABLE) SHALL BE IRRIGATED BY AUTOMATIC POP-UP SPRAY SYSTEM. SHRUBS & PLANTING BEDS SHALL BE IRRIGATED WITH DRIP/BUBBLER SYSTEM.
- ALL TREES & SHRUBS OUTSIDE OF BEDS WITHIN NATIVE AREAS SHALL BE DRIP IRRIGATED. ALL IRRIGATION SHALL BE AN AUTOMATIC UNDERGROUND SYSTEM.

MAINTENANCE


- REFER TO IRRIGATION PLANS FOR DETAILED INFORMATION.
- CONTRACTOR IS TO MAINTAIN ALL PLANTINGS AND ASSOCIATED IRRIGATION SYSTEM INSTALLED UNDER THIS CONTRACT UNTIL FINAL ACCEPTANCE BY THE CITY AND TURNOVER TO OWNER. THIS MAINTENANCE SHALL INCLUDE PROPER WATERING OF ALL PLANTS, AND MOWING OF TURF/SEED AREAS IF NECESSARY.
- SITE MUST BE CLEAN AND FREE OF ALL CONSTRUCTION DEBRIS BEFORE FINAL ACCEPTANCE.
- ALL PLANT MATERIAL WILL BE COVERED BY A WARRANTY PERIOD. THE CONTRACTOR SHALL REPLACE DEAD, UNHEALTHY, OR OTHERWISE UNSATISFACTORY MATERIAL THROUGHOUT THIS PERIOD. THE WARRANTY SHALL BEGIN UPON FINAL ACCEPTANCE OF THE JOB.
- LANDSCAPING SHALL BE PLANTED AND MAINTAINED IN A LIVING CONDITION BY THE OWNER OR ASSIGNS OR OWNERS ASSOCIATION. TREES AND SHRUBS MUST HAVE A 100% ONGOING SURVIVAL RATE. ANY DEAD OR DAMAGED PLANT MATERIAL (AS DETERMINED BY THE LOCAL MUNICIPALITY) SHALL BE REPLACED. NON-LIVING GROUND COVERS, SUCH AS ROCK OR MULCH, MUST BE 100% INTACT AFTER ONE YEAR AND 100% INTACT THEREAFTER.
- LANDSCAPE AREAS WITHIN THE PROPERTY AND WITHIN THE ADJACENT RIGHT OF WAY SHALL BE MAINTAINED BY THE PROPERTY OWNER.

PLANT SCHEDULE PARK

DECIDUOUS TREES	QTY	BOTANICAL NAME	COMMON NAME	ROOT	CALIPER/HT.
AS	12	Acer platanoides 'Schwedleri'	Schwedler Maple	B & B	2.5'Cal
BR	10	Betula nigra	River Birch	B & B	2.5'Cal
GI	1	Gleditsia triacanthos 'Imperial'	Imperial Honeylocust	B & B	2.5'Cal
GS	9	Gleditsia triacanthos inermis 'Shademaster' TM	Shademaster Locust	B & B	2.5'Cal
GK	5	Gymnocladia dioica	Kentucky Coffee Tree	B & B	2.5'Cal
OV	3	Ostrya virginiana	American Hornbeam	B & B	2.5'Cal
PC	3	Platanus occidentalis	American Sycamore	B & B	2.5'Cal
QM	5	Quercus macrocarpa	Burr Oak	B & B	2.5'Cal
QM2	6	Quercus muehlenbergii	Chinkapin Oak	B & B	2.5'Cal
QR	13	Quercus rubra	Red Oak	B & B	2.5'Cal
TG2	16	Tilia cordata 'Glenleven'	Glenleven Littleleaf Linden	B & B	2.5'Cal
TG	3	Tilia cordata 'Greenspire'	Greenspire Littleleaf Linden	B & B	2.5'Cal
UP	9	Ulmus americana 'Princeton'	American Elm	B & B	2.5'Cal
EVERGREEN TREES	QTY	BOTANICAL NAME	COMMON NAME	ROOT	CALIPER/HT.
PC	22	Picea pungens	Colorado Spruce	B & B	6'-8" HT
VAN	15	Pinus flexilis 'Vanderwolf's Pyramid'	Vanderwolf's Pyramid Pine	B & B	6'-8" HT
PN	23	Pinus flexilis	Pinus flexilis	B & B	6'-8" HT
PN	25	Pinus nigra	Austrian Black Pine	B & B	6'-8" HT
PPI	14	Pinus ponderosa	Ponderosa Pine	B & B	6'-8" HT
ORNAMENTAL TREES	QTY	BOTANICAL NAME	COMMON NAME	ROOT	CALIPER/HT.
AK2	28	Acer glabrum	Rocky Mountain Maple	B & B	2'Cal
WKH	28	Crataegus viridis 'Winter King'	'Winter King' Hawthorn	B & B	2'Cal
ORNAMENTAL GRASSES	QTY	BOTANICAL NAME	COMMON NAME	SIZE	HEIGHT/WIDTH
CK	160	Calamagrostis x acutiflora 'Karl Foerster'	Feather Reed Grass	1 gal	4.5'x2'
MY	325	Miscanthus sinensis 'Yaku Jima'	Yaku Jima Dwarf Maiden Grass	1 gal	3' X 3'
PH	155	Panicum virgatum 'Heavy Metal'	Blue Switch Grass	1 gal	5' X 3'
PB2	9	Pennisetum alopecuroides 'Little Bunny'	Little Bunny Fountain Grass	1 gal	1' x 2'
ANNUALS/PERENNIALS	QTY	BOTANICAL NAME	COMMON NAME	SIZE	HEIGHT/WIDTH
CV	28	Coreopsis verticillata 'Moonbeam'	Threadleaf Coreopsis	1 gal	1.5' X 1.5'
EP	53	Echinacea purpurea	Purple Coneflower	1 gal	2' X 2'
BES	67	Rudbeckia fulgida sultivantii 'Goldsturm'	Black-eyed Susan	1 gal	1.5' X 1.5'
DECIDUOUS SHRUBS	QTY	BOTANICAL NAME	COMMON NAME	SIZE	HEIGHT/WIDTH
SSB	19	Ameilanchier alnifolia 'Regent'	Saskatoon Serviceberry	5 gal	12' X 8'
AG	55	Ameilanchier x grandiflora 'Autumn Brilliance'	'Autumn Brilliance' Serviceberry	5 gal	15' X 10'
CD	107	Caryopteris x diandensis 'Dark Knight'	Blue Mist Shrub	5 gal	3' X 4'
RB	72	Chrysothamnus nauseosus	Rabbitbrush	5 gal	4' X 4'
CB	30	Cornus sericea 'Bailey'	Red Twig Dogwood	5 gal	8' X 8'
CH	45	Cotoneaster horizontalis	Rock Cotoneaster	5 gal	3' X 5'
PS2	40	Penstemon strictus	Rocky Mountain Penstemon	5 gal	2' X 3'
PA	86	Potentilla fruticosa 'Jackmanii'	Russian Sage	5 gal	5' X 4'
PJ	37	Potentilla fruticosa 'Jackmanii'	Jackman's Potentilla	5 gal	3' X 4'
RHU	43	Rhus aromatica 'Gro-Low'	Lo-Low Fragrant Sumac	5 gal	3' X 6'
RG	27	Ribes aureum	Golden Currant	5 gal	4' X 6'
FMR	73	Rosa Meidiland series 'Fire'	Fire Meidiland Rose	5 gal	2' X 4'
RW	24	Rosa Meidiland series 'White'	White Meidiland Rose	5 gal	2' X 4'
EVERGREEN SHRUBS	QTY	BOTANICAL NAME	COMMON NAME	SIZE	HEIGHT/WIDTH
AC	32	Arctostaphylos x coloradoensis 'Chieftain'	Manzanita	5 gal	2' X 5'
AP	46	Arctostaphylos x coloradoensis 'Panchito'	Panchito Manzanita	5 gal	1.5' x 5'
JB	24	Juniperus horizontalis 'Blue Chip'	Blue Chip Juniper	5 gal	8' X 10'
JH	50	Juniperus horizontalis 'Hughes'	Hughes Juniper	5 gal	1.5' x 6'
BUJ	71	Juniperus sabinia 'Buffalo'	Buffalo Juniper	5 gal	2' X 6'
PS	80	Pinus mugo 'Stromound'	Mugo Pine	5 gal	2.5' X 5'
GROUND COVERS	QTY	BOTANICAL NAME	COMMON NAME	CONT	
	132,408 sf	BLUEGRASS SOD	BLUEGRASS SOD	sod	
	0 sf	BUFFALO GRASS	BUFFALO GRASS	sod	
	14,382 sf	CRUSHER FINES CRUSHER FINES	CRUSHER FINES	mulch	
	1,571 sf	ENVIROTURF	ENVIROTURF	sod	
	6,243 sf	FIBAR PLAYGROUND MULCH	FIBAR PLAYGROUND MULCH	mulch	
	10,673 sf	INFIELD MIX	G&S SOLUTIONS-CLASSIC INFIELD MIX, GOLD	COLOR.GOLD	
	28,939 sf	ROCK MULCH -GREY, 1-1/2" MOUNTAIN GRANITE	ROCK MULCH GREY, 1-1/2" MOUNTAIN GRANITE	mulch	
	5,343 sf	ROCK MULCH GRAY-1-1/2" MTN GRANITE	ROCK MULCH GRAY-1-1/2" MTN GRANITE	mulch	
	120,557 sf	SEED MIX 1	SEED MIX 1	seed	
	24,437 sf	SEED MIX 2	SEED MIX 2	seed	
	4,956 sf	WARNING TRACK MIX	G&S SOLUTIONS CLASSIC WARNING TRACK MIX	COLOR.GOLD	

GROUND COVERS

BLUEGRASS SOD

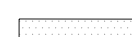

BUFFALO GRASS



CRUSHER FINES CRUSHER FINES



ENVIROTURF



FIBAR PLAYGROUND MULCH




INFIELD MIX



ROCK MULCH -GREY, 1-1/2" MOUNTAIN GRANITE





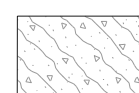
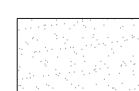
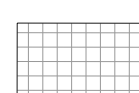


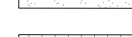



ROCK MULCH GRAY-1-1/2" MTN GRANITE

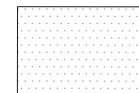


SEED MIX 1





-  BLUEGRASS SOD
RE: LANDSCAPE NOTES
-  BUFFALO GRASS
RE: LANDSCAPE NOTES
-  CRUSHER FINES
-  ENVIROTURF
RE: LANDSCAPE NOTES
-  FIBAR PLAYGROUND MULCH
-  G&S SOLUTIONS-CLASSIC INFIELD MIX, GOLD
COLOR: GOLD, WITHOUT STABILIZER
-  ROCK MULCH GREY, 1-1/2" MOUNTAIN GRANITE
3" DEPTH, RE: LDSCP NOTES
-  ROCK MULCH GRAY-1-1/2" MTN GRANITE
3" DEPTH, RE: LDSCP NOTES
-  SEED MIX 1
TOWN OF PARKER - SEED MIX 1,
RE: LANDSCAPE NOTES
-  SEED MIX 2
TOWN OF PARKER - SEED MIX 2,
RE: LANDSCAPE NOTES
-  G&S SOLUTIONS CLASSIC WARNING TRACK MIX
COLOR:GOLD, WITHOUT STABILIZER

- NOTES:
1. NO FENCES OR STRUCTURES WILL BE ALLOWED WITHIN SIGHT TRIANGLES.
 2. SHRUBS AND WILL BE LOWER THAN 3' WITHIN SIGHT TRIANGLES.
 3. TREE CANOPIES WITHIN SIGHT TRIANGLES WILL BE NO LOWER THAN 8'

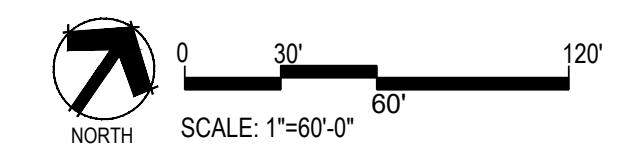

Prepared For
ESX MANAGEMENT
 7353 SOUTH ALTON WAY
 CENTENNIAL, CO 80112

Land Planning

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 1.303.531.4905 . f.303.531.4908

Engineering

 10333 E. DRY CREEK RD. #240
 ENGLEWOOD, CO 80112
 720-482-9526

TRAILS AT CROWFOOT
 PARK PLANS
 PARKER, COLORADO
 LANDSCAPE PLANS


Drawn by: BEM, GG
 Checked by: PCS STAFF
 Submittal Date: 08.01.2017
 Date: 02.27.2018
 Know what's below. Call before you dig. 811 logo
 10.19.2020
 11.23.2020
 03.16.2022

Sheet Name
OVERALL SITE & LANDSCAPE PLAN


Sheet Number
L0.2

LINE NO.	LENGTH	DIRECTION
L1	212.26'	N34°36'25"W
L2	20.00'	N55°23'35"E
L3	2.44'	N34°36'25"W
L4	16.00'	N55°23'35"E
L5	123.37'	S34°36'25"E
L6	16.00'	N55°23'35"E
L7	3.00'	S34°36'25"E
L8	1.77'	S55°23'35"W
L9	16.00'	N34°36'25"W
L10	159.00'	S55°23'35"W
L11	15.34'	N34°36'25"W
L12	14.49'	N34°36'25"W
L13	99.00'	S55°23'35"W
L14	17.00'	S34°36'25"E
L15	7.74'	S55°23'35"W
L16	20.45'	N34°36'25"W
L17	18.00'	S47°54'30"W
L18	15.00'	S47°54'30"W
L19	8.52'	N42°05'30"W
L20	15.96'	N55°23'30"E
L21	2.94'	S33°59'03"E
L22	15.96'	S56°38'24"W
L23	14.98'	S65°07'42"W
L24	17.92'	S68°38'41"W
L25	17.92'	N68°38'41"E
L26	15.02'	N65°08'59"E
L27	14.01'	N56°19'36"E
L28	0.86'	S33°40'24"E
L29	14.01'	S55°48'11"W
L30	8.52'	S42°05'30"E
L31	15.00'	N47°54'30"E
L32	17.99'	N47°54'30"E

CURVE NO.	LENGTH	RADIUS	DELTA
C1	15.71'	10.00'	90°00'00"
C2	6.28'	4.00'	90°00'00"
C3	6.28'	4.00'	90°00'00"
C4	31.42'	20.00'	90°00'00"
C5	6.28'	4.00'	90°00'00"
C6	7.18'	5.00'	82°17'23"
C7	139.56'	32.50'	246°01'46"
C8	32.57'	30.00'	62°12'10"
C9	8.86'	5.00'	101°32'13"
C10	4.71'	3.00'	90°00'00"
C11	23.56'	15.00'	90°00'00"
C12	15.71'	10.00'	90°00'03"
C13	31.42'	20.00'	90°00'00"
C14	59.69'	38.00'	90°00'00"
C15	7.85'	5.00'	90°00'00"
C16	63.48'	486.00'	7°29'00"
C17	6.33'	4.00'	90°37'27"
C18	6.33'	4.00'	90°37'27"
C19	72.00'	486.00'	8°29'18"
C20	7.90'	5.00'	90°30'01"
C21	57.69'	38.00'	86°59'01"
C22	32.48'	20.00'	93°03'36"
C23	32.48'	20.00'	93°03'36"
C24	27.35'	18.00'	87°02'59"
C25	7.81'	5.00'	89°27'38"
C26	84.08'	546.00'	8°49'24"
C27	3.14'	2.00'	90°00'00"
C28	3.12'	2.00'	89°28'36"
C29	75.23'	546.00'	7°53'41"
C30	7.85'	5.00'	90°00'00"
C31	28.27'	18.00'	90°00'00"
C32	31.38'	20.00'	89°54'10"

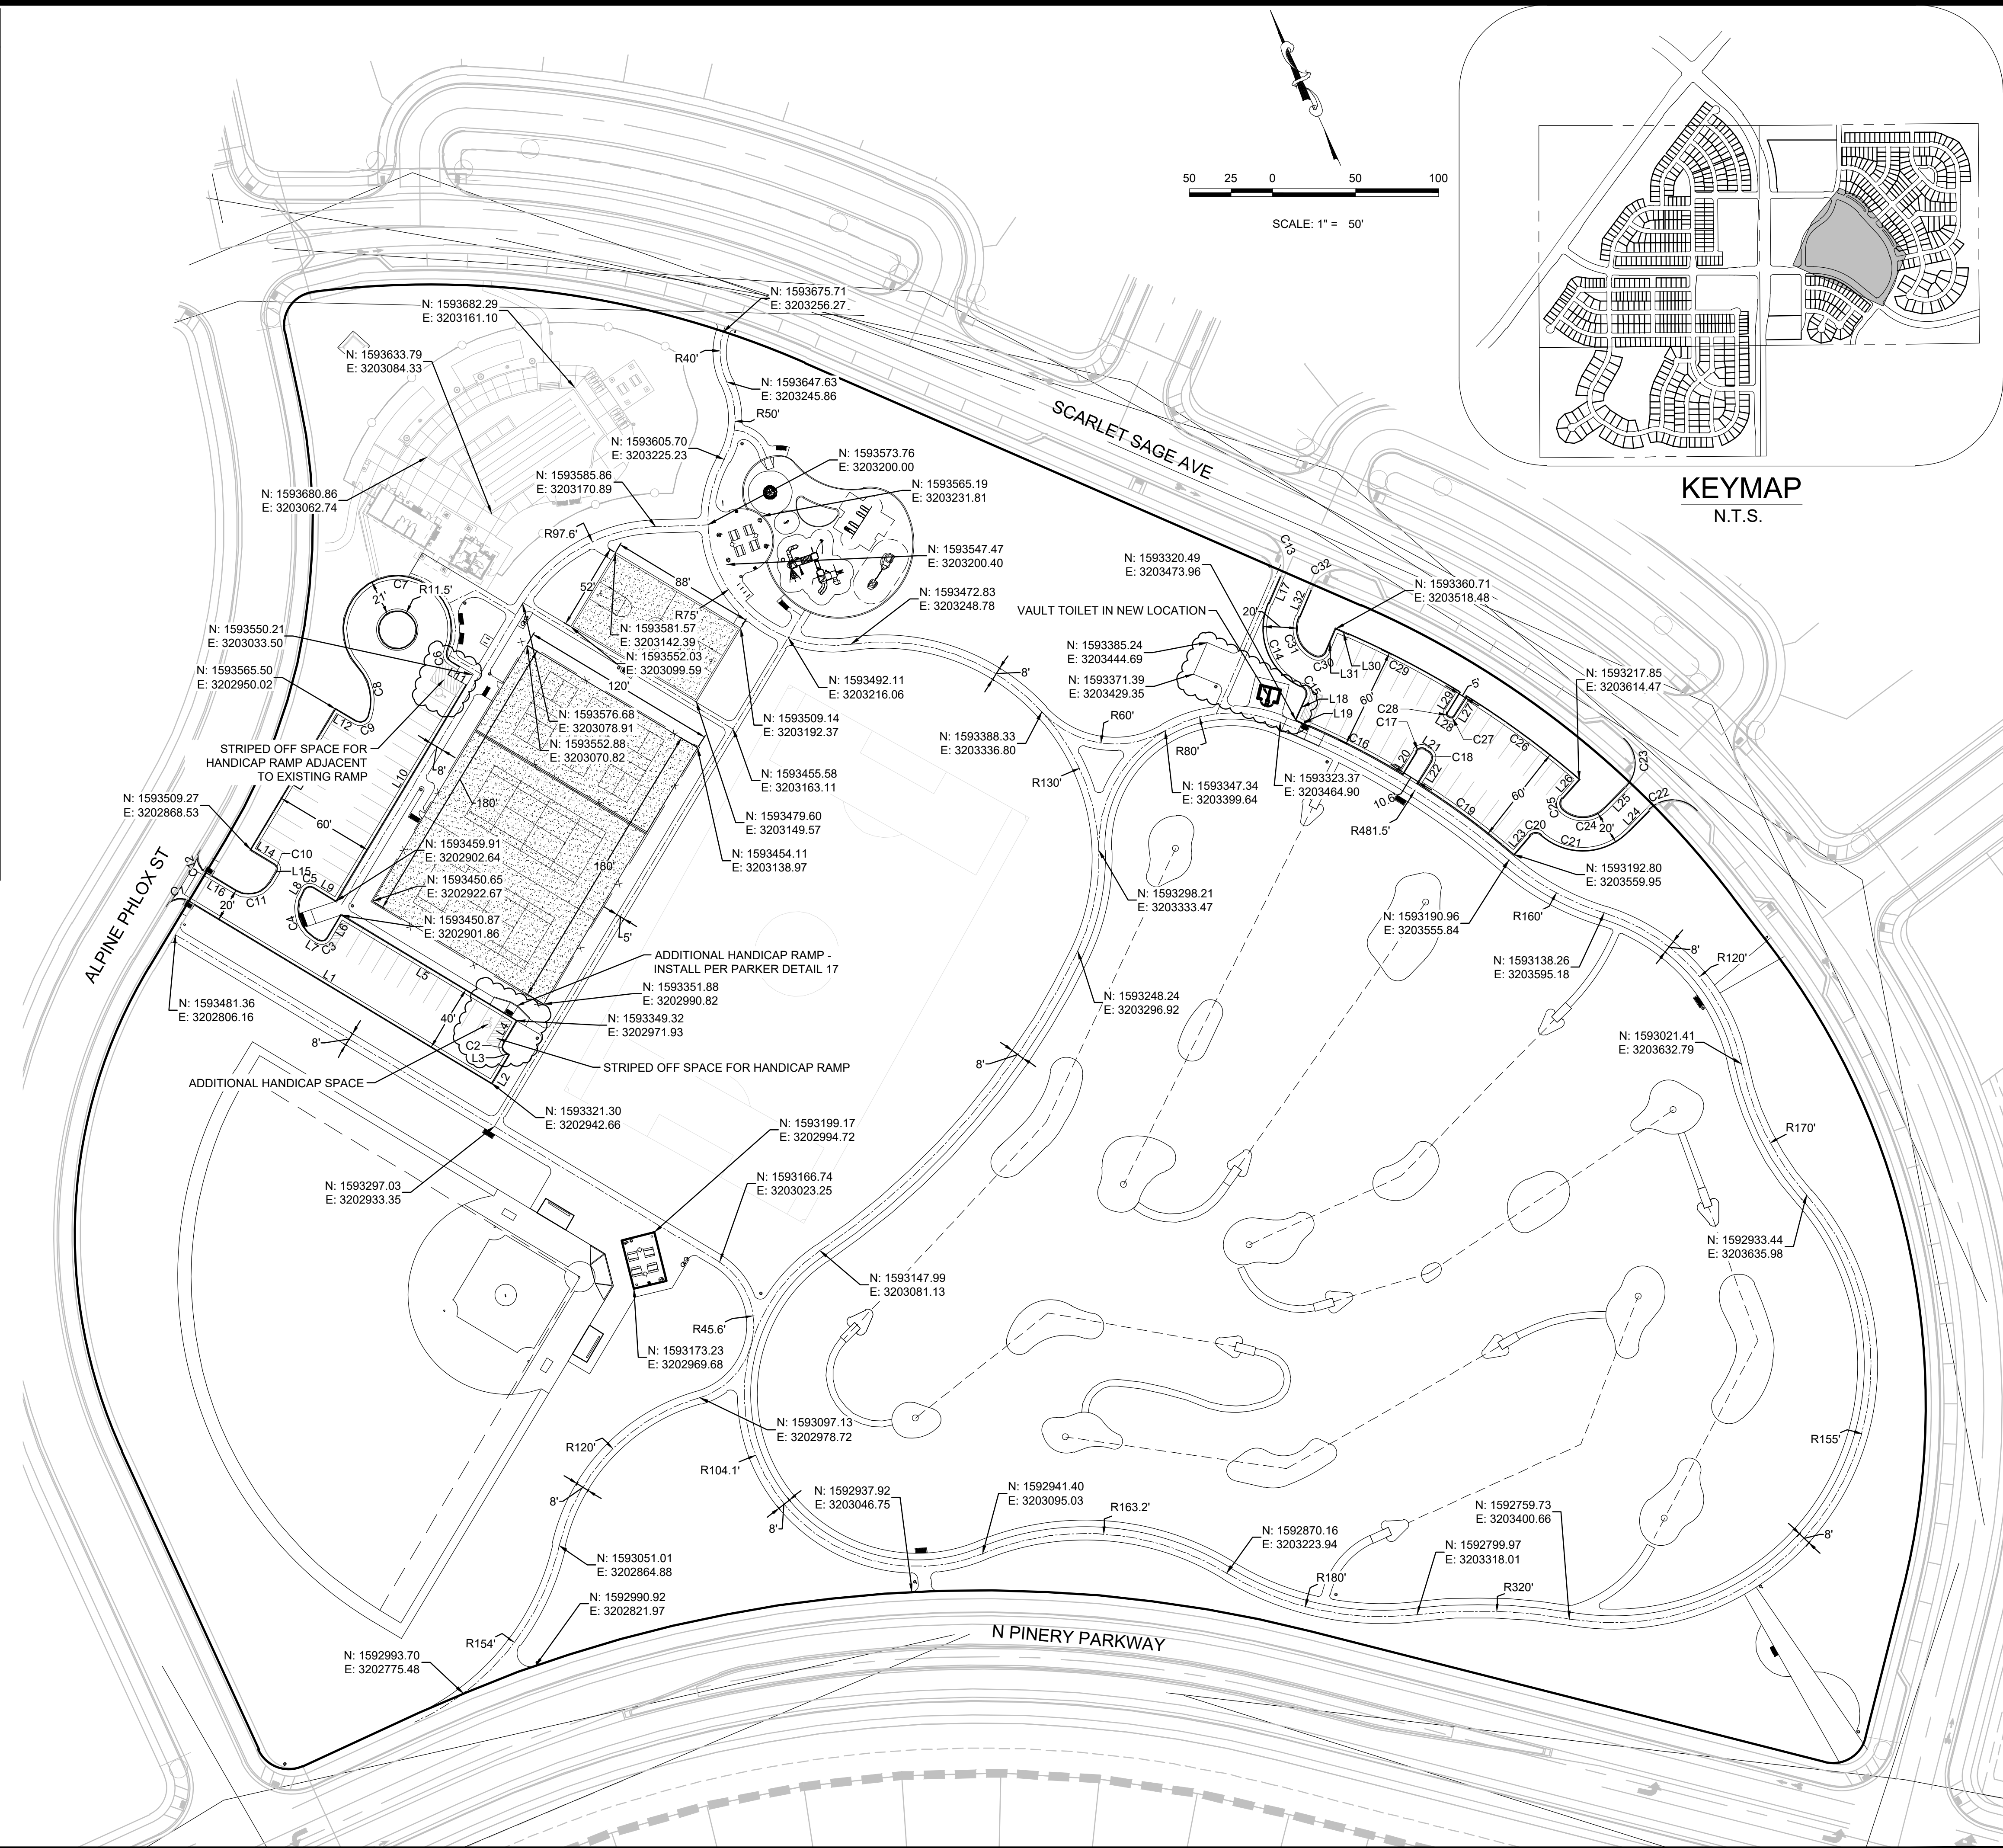

KEYMAP
N.T.S.

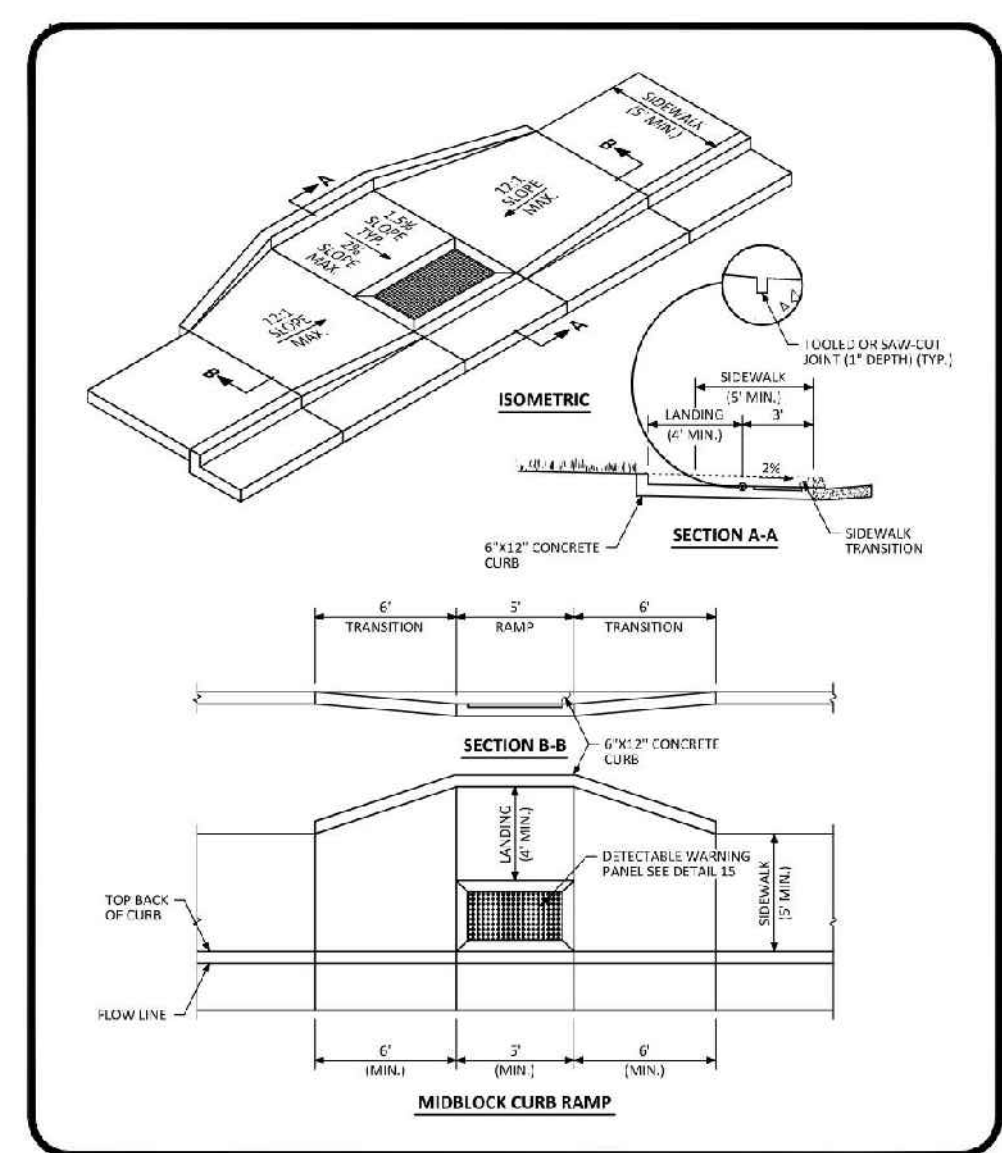

MIDBLOCK CURB RAMP LAYOUT STANDARD DETAIL
DATE: 09/11/2017
SCALE: AS SHOWN
17
2 OF 2

THE TOWN OF PARKER REVIEW CONSTITUTES GENERAL COMPLIANCE WITH THE TOWN'S STANDARDS AND APPROVED VARIANCES, SUBJECT TO THESE PLANS BEING STAMPED, SIGNED, AND DATED BY THE PROFESSIONAL ENGINEER OF RECORD. REVIEW BY THE TOWN DOES NOT CONSTITUTE APPROVAL OF THE PLAN DESIGN OR ACCURACY AND CORRECTNESS OF ENGINEERING CALCULATIONS. ERRORS IN THE DESIGN OR CALCULATIONS REMAIN THE RESPONSIBILITY OF THE REGISTERED PROFESSIONAL ENGINEER WHOSE STAMP AND SIGNATURE ARE AFFIXED TO THIS DOCUMENT.

THIS REVIEW DOES NOT CONSTITUTE APPROVAL OF ANY PRIVATE ON-SITE IMPROVEMENTS WHICH MAY BE SHOWN. CONSTRUCTION CANNOT COMMENCE UNTIL ALL REQUIRED DRAINAGE/TRAFFIC REPORT(S), FINAL DEVELOPMENT PLAN(S), SPECIAL REVIEW(S), GRADING PERMIT, AND/OR OTHER PERMITS ARE COMPLETE, APPROVED AND ON FILE WITH THE TOWN OF PARKER.

TOWN OF PARKER, DIRECTOR OF ENGINEERING _____ DATE _____

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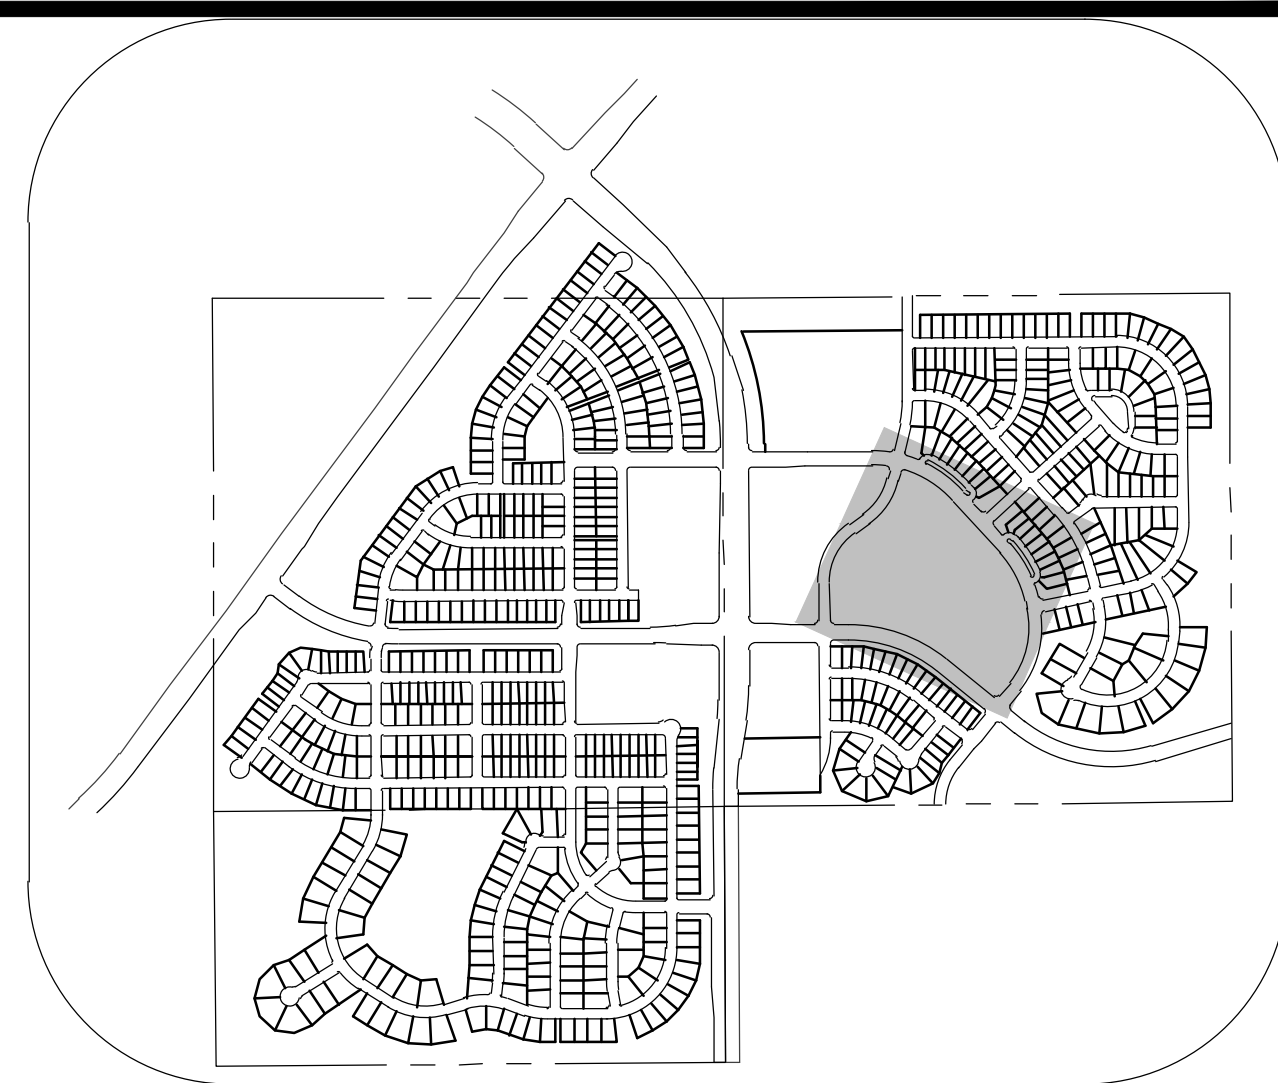
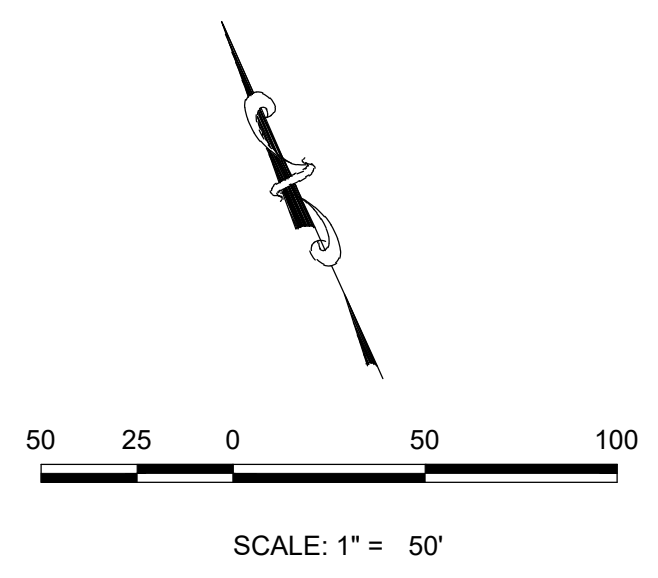
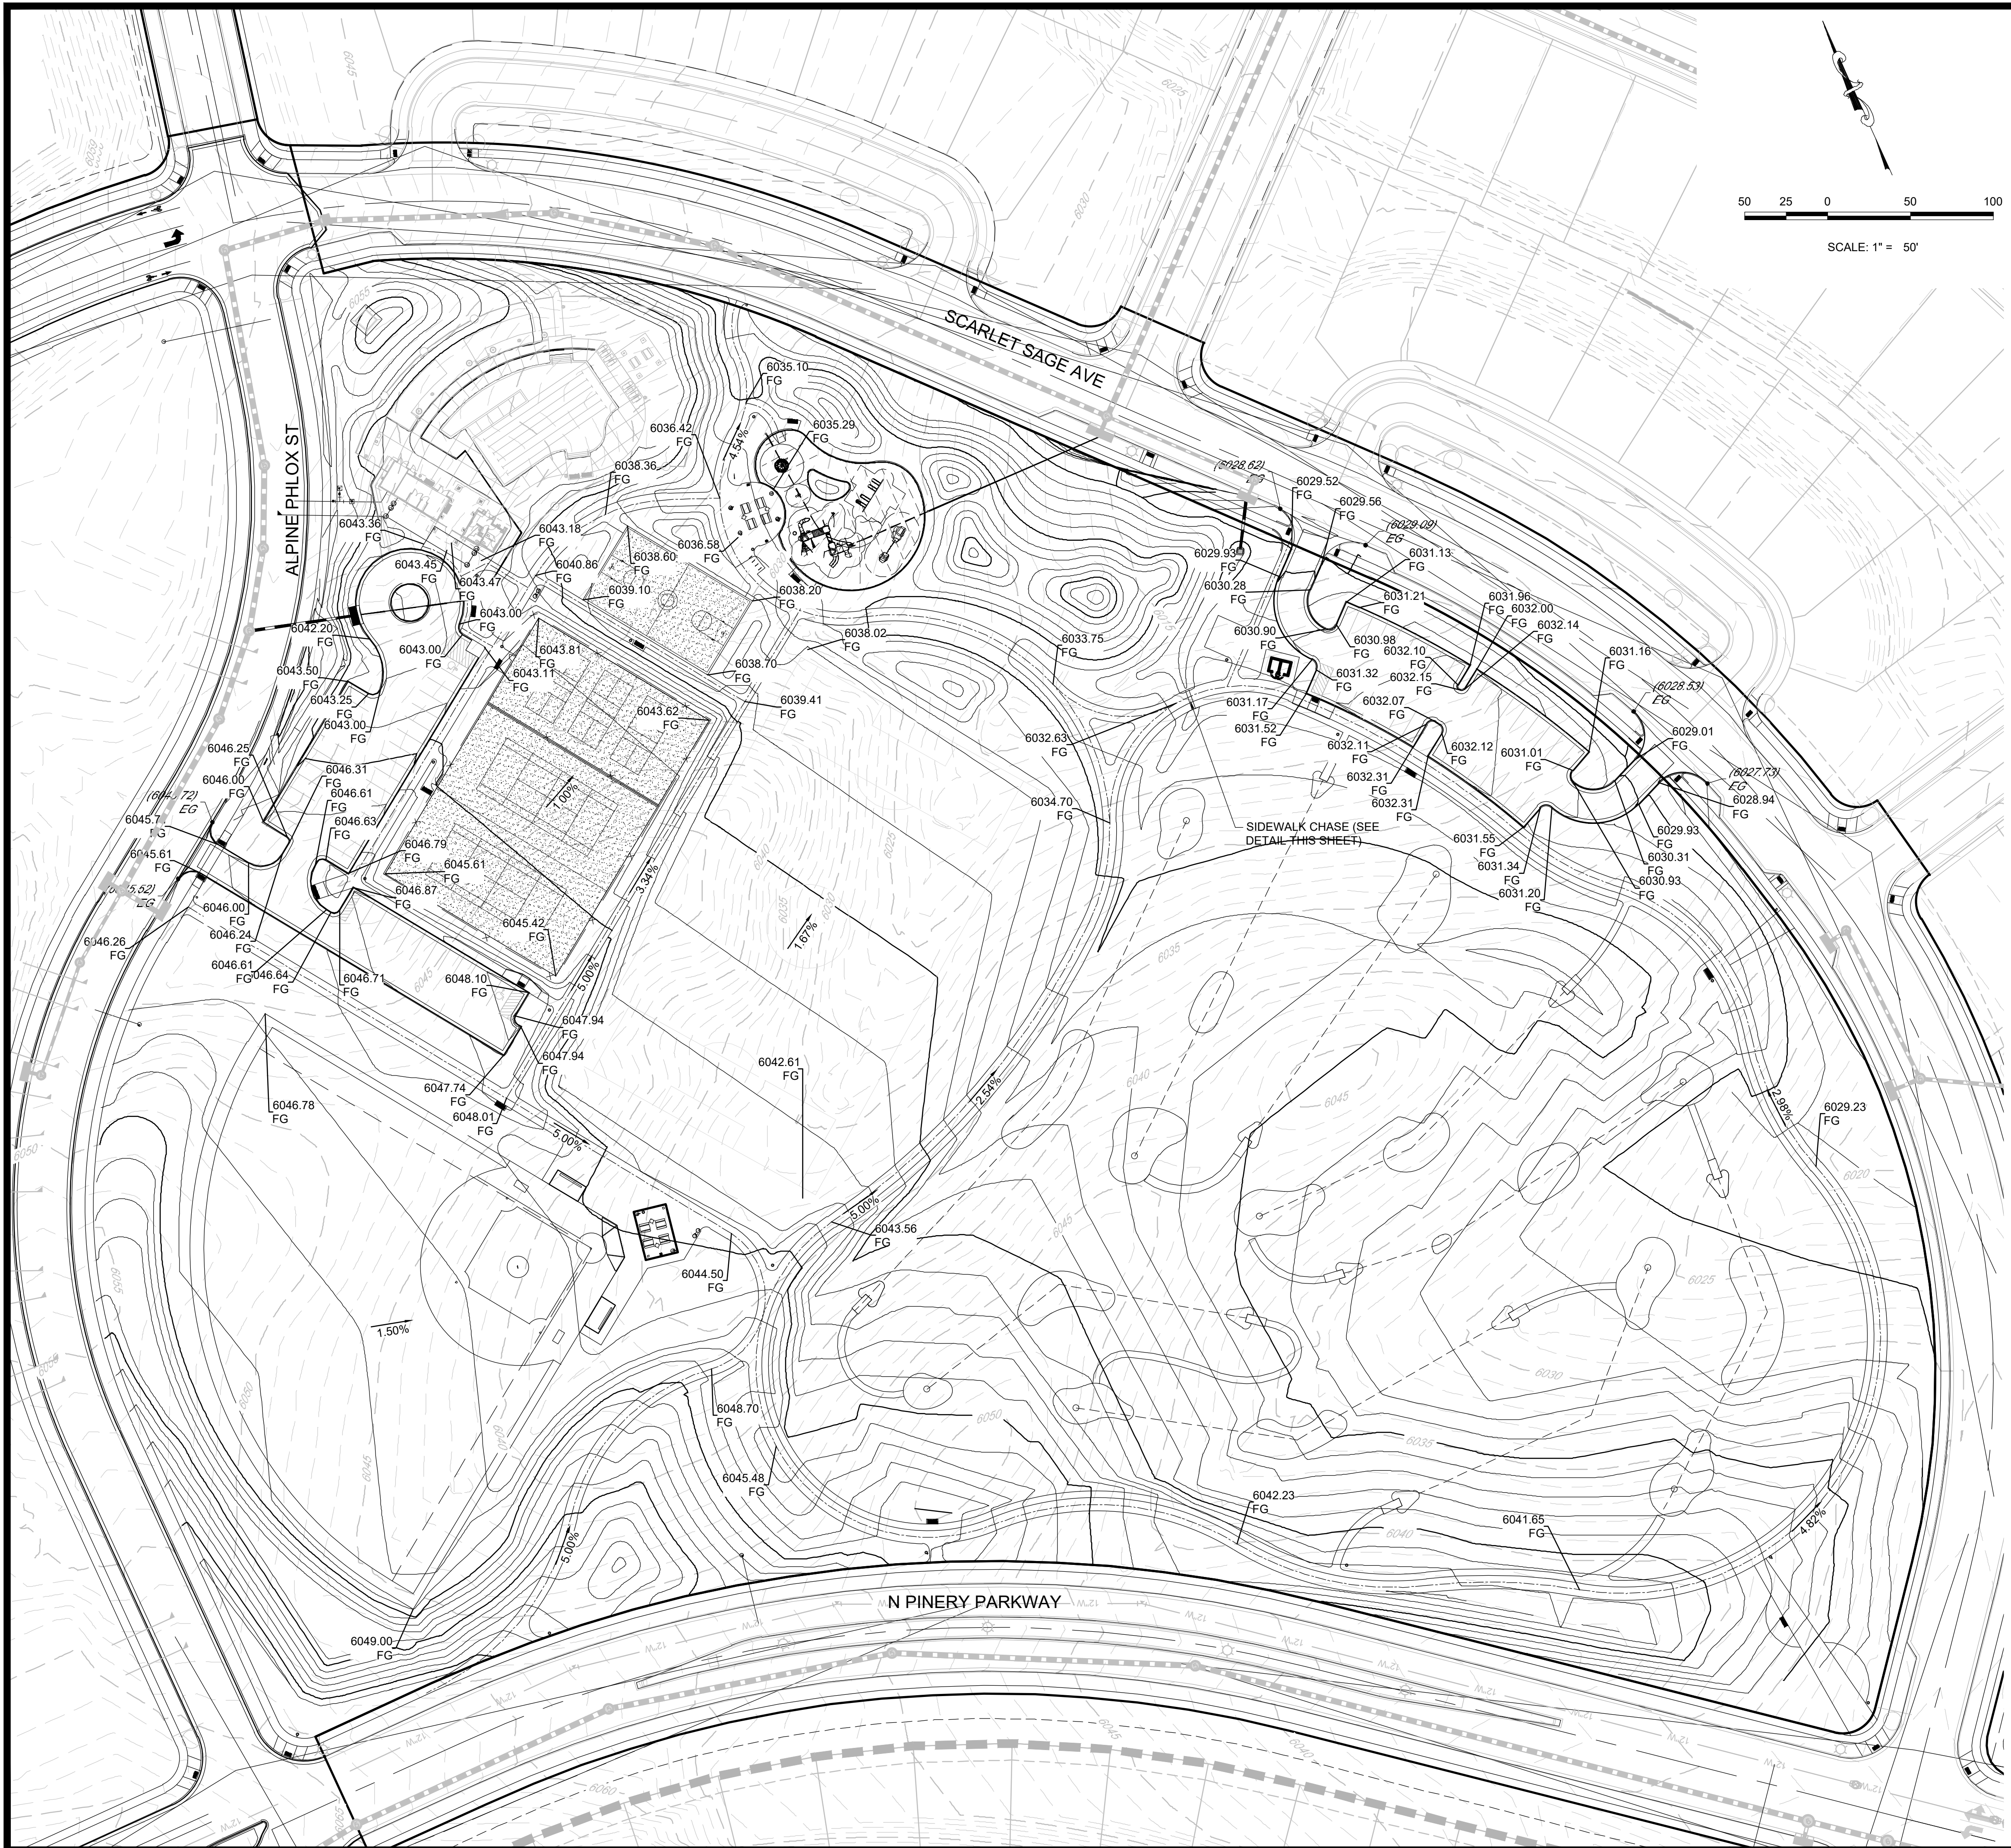
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TRAILS AT CROWFOOT
PARK PLANS
PARKER, COLORADO
LANDSCAPE PLANS

Drawn by: CA
Checked by: BPW
Submittal Date: 09.11.2017
Date: _____
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Sheet Name
HORIZONTAL CONTROL PLAN

Sheet Number
L.03




KEYMAP
N.T.S.
LEGEND

②	BLOCK NUMBER	←	PROPOSED OVERLAND FLOW
(A)	LOT TYPE	---	CENTERLINE
6	LOT NUMBER	---	RIGHT-OF-WAY
⊥	EXISTING FLARED END SECTION	---	PROPERTY LINE
⊥	EXISTING STORM DRAIN INLET	---	EDGE OF PAVEMENT
●	EXISTING STORM DRAIN MANHOLE	---	EXISTING 5' CONTOUR
⊙	PROPOSED LIGHT POLE	---	EXISTING 1' CONTOUR
---	PROPOSED SIDEWALK	---	PROPOSED 5' CONTOUR
---	PROPOSED SIDEWALK RAMP	---	PROPOSED 1' CONTOUR
10.00	EXISTING ELEVATION	---	EXISTING STORM DRAIN
10.00	PROPOSED DESIGN ELEVATION	---	SECTION LINE
00.0 FG	PROPOSED FINISHED GRADE	---	FILING BOUNDARY
		1.0%	PROPOSED SLOPE & DIRECTION

ABBREVIATIONS

AD	ANGLE DIFFERENCE	PL	PROPERTY LINE
EL	ELEVATION	PVC	POLYVINYL CHLORIDE
FG	FINISHED GRADE	RCBC	REINFORCED CONCRETE BOX CULVERT
FL	FLOW LINE	RCP	REINFORCED CONCRETE PIPE
FV	FIELD VERIFY	ROW	RIGHT OF WAY
GE	GAS EASEMENT	SD	STORM DRAIN
HP	HIGH POINT	SL	SECTION LINE
INV	INVERT	STA	STATION
LF	LINEAR FEET	T.O.P.	TOP OF PIPE
LP	LOW POINT	UE	UTILITY EASEMENT
MH	MANHOLE	WSE	WATER SURFACE ELEVATION
N.T.S.	NOT TO SCALE		

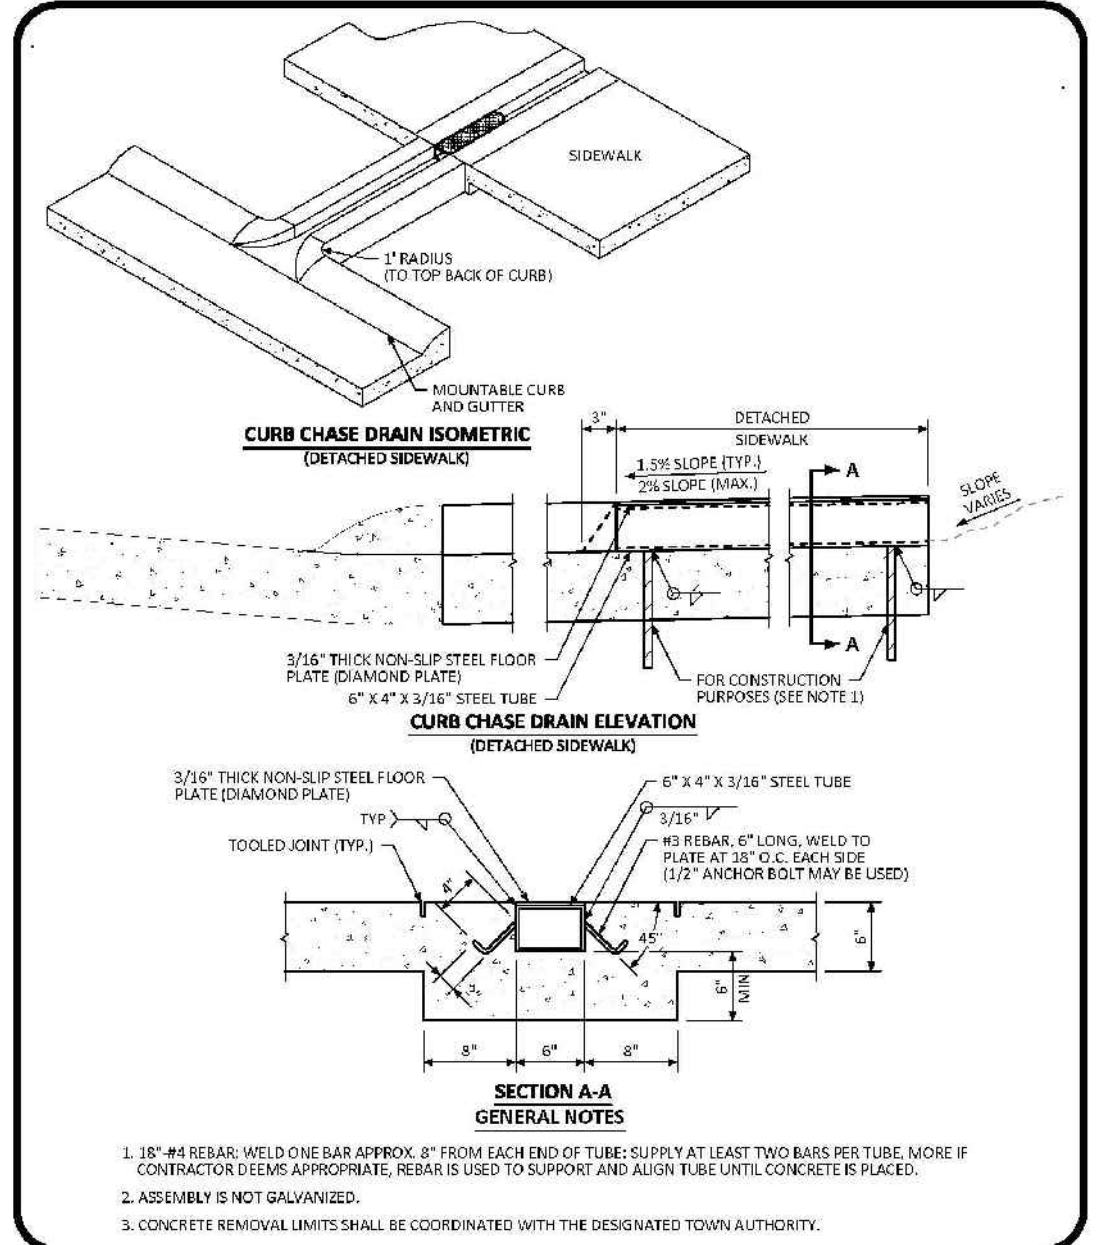

SECTION A-A
GENERAL NOTES

1. 3/16" REBAR, WELD ONE BAR APPROX. 4" FROM EACH END OF TUBE SUPPLY AT LEAST TWO BARS PER TUBE. MORE IF CONTRACTOR DEEMS APPROPRIATE. REBAR IS USED TO SUPPORT AND ALIGN TUBE UNTIL CONCRETE IS PLACED.
2. ASSEMBLY IS NOT GALVANIZED.
3. CONCRETE REMOVAL LIMITS SHALL BE COORDINATED WITH THE DESIGNATED TOWN AUTHORITY.

DATE: AUGUST 2014
DETAIL: 29
1 OF 2

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TRAILS AT CROWFOOT
PARK PLANS
PARKER, COLORADO
LANDSCAPE PLANS

Drawn by: CA
Checked by: BFW
Submittal Date: 09.11.2017


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Sheet Name
PARK
GRADING
PLAN

Sheet Number
L.04



KEYMAP
N.T.S.

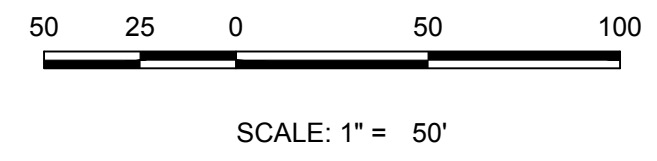


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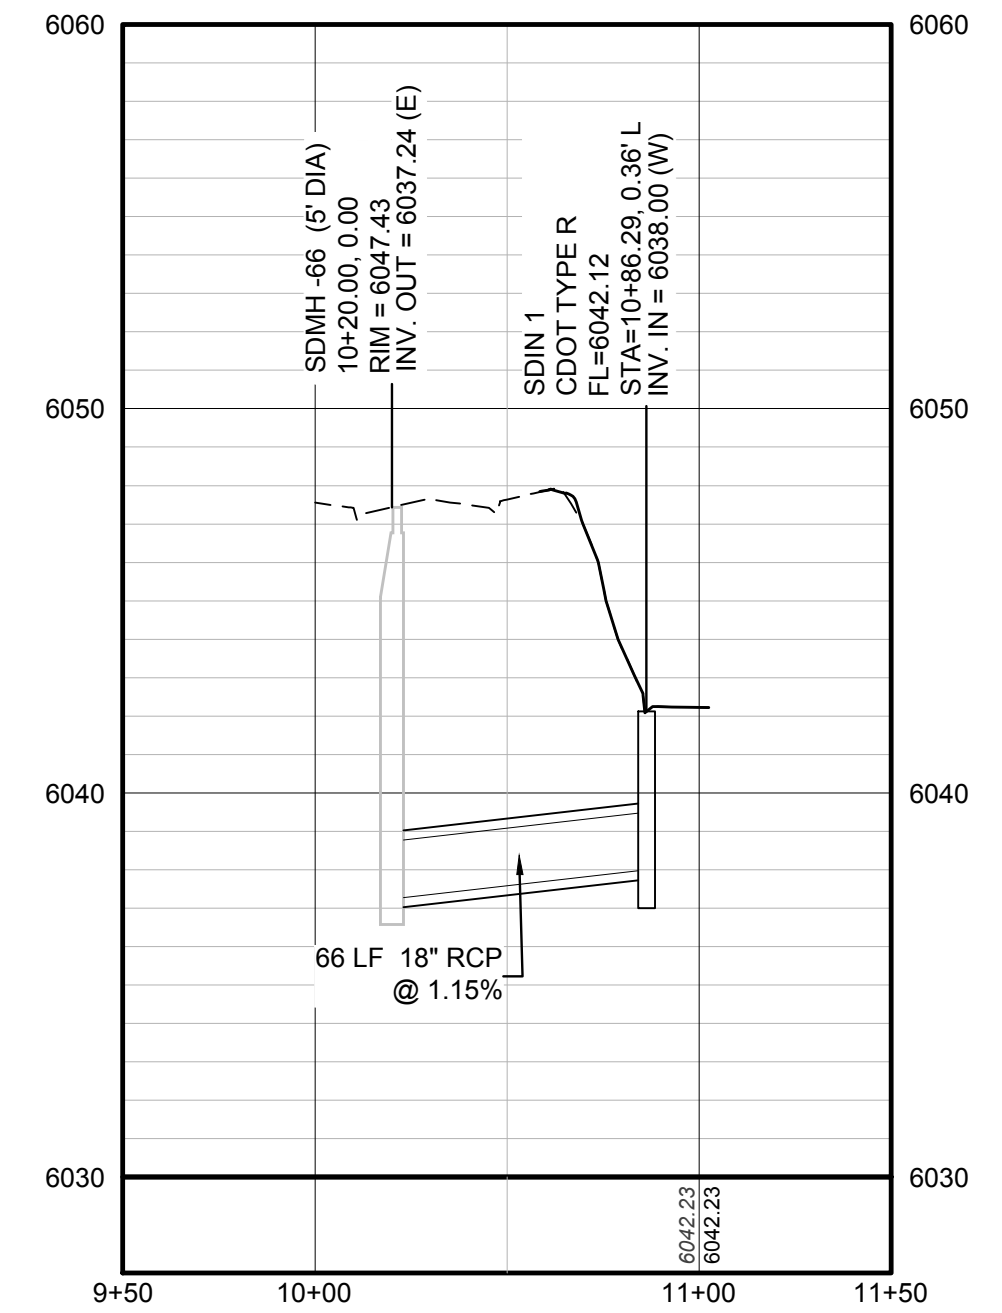
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Ⓐ	LOT TYPE	- - - - -	CENTERLINE
6	LOT NUMBER	—	RIGHT-OF-WAY
⌋	EXISTING FLARED END SECTION	—	PROPERTY LINE
⌋	EXISTING STORM DRAIN INLET	—	EDGE OF PAVEMENT
●	EXISTING STORM DRAIN MANHOLE	— 5615	EXISTING 5' CONTOUR
☀	PROPOSED LIGHT POLE	— 5616	EXISTING 1' CONTOUR
—	PROPOSED SIDEWALK	— 5620	PROPOSED 5' CONTOUR
▬	PROPOSED SIDEWALK RAMP	— 5607	PROPOSED 1' CONTOUR
10.00	EXISTING ELEVATION	—	EXISTING STORM DRAIN
10.00	PROPOSED DESIGN ELEVATION	- - - - -	SECTION LINE
00.0	PROPOSED FINISHED GRADE	—	FILING BOUNDARY
FG		1.0%	PROPOSED SLOPE & DIRECTION

ABBREVIATIONS


AD	ANGLE DIFFERENCE	PL	PROPERTY LINE
EL	ELEVATION	PVC	POLYVINYL CHLORIDE
FG	FINISHED GRADE	RCBC	REINFORCED CONCRETE BOX CULVERT
FL	FLOW LINE	RCP	REINFORCED CONCRETE PIPE
FV	FIELD VERIFY	ROW	RIGHT OF WAY
GE	GAS EASEMENT	SD	STORM DRAIN
HP	HIGH POINT	SL	SECTION LINE
INV	INVERT	STA	STATION
LF	LINEAR FEET	T.O.P.	TOP OF PIPE
LP	LOW POINT	UE	UTILITY EASEMENT
MH	MANHOLE	WSE	WATER SURFACE ELEVATION
N.T.S.	NOT TO SCALE		

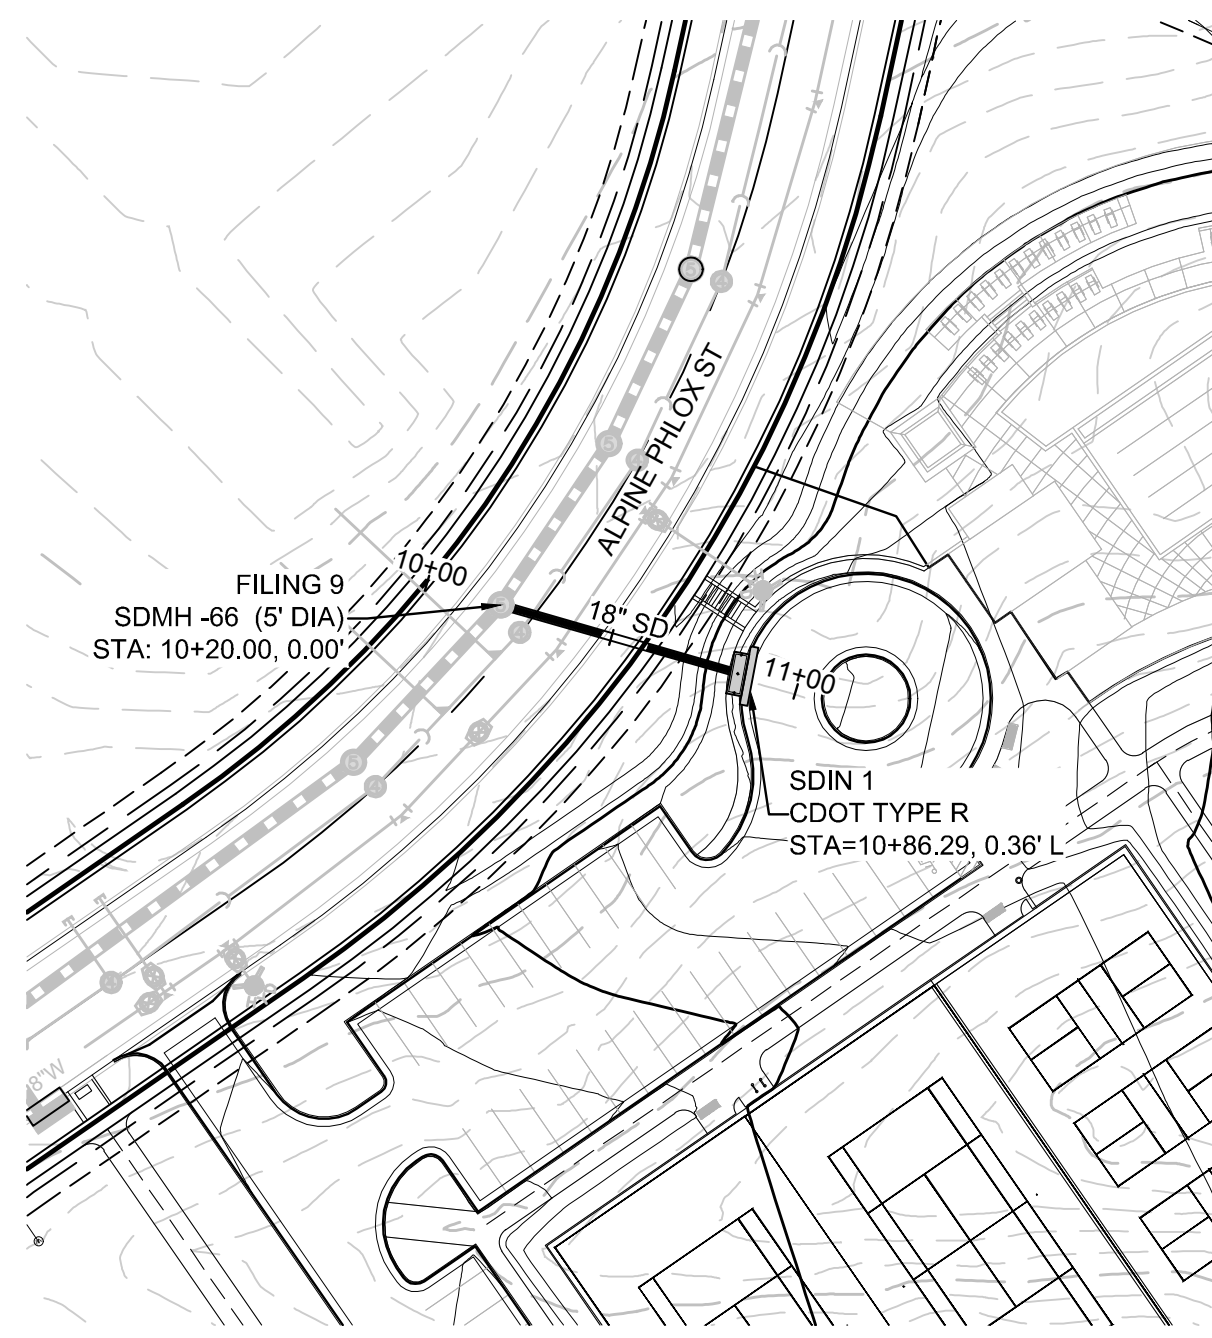


PLAN: PARK STORM LATERAL 1
HORIZONTAL SCALE: 1" = 50'




PROFILE: PARK STORM LATERAL 1
HORIZONTAL: 1" = 50'
VERTICAL: 1" = 5'

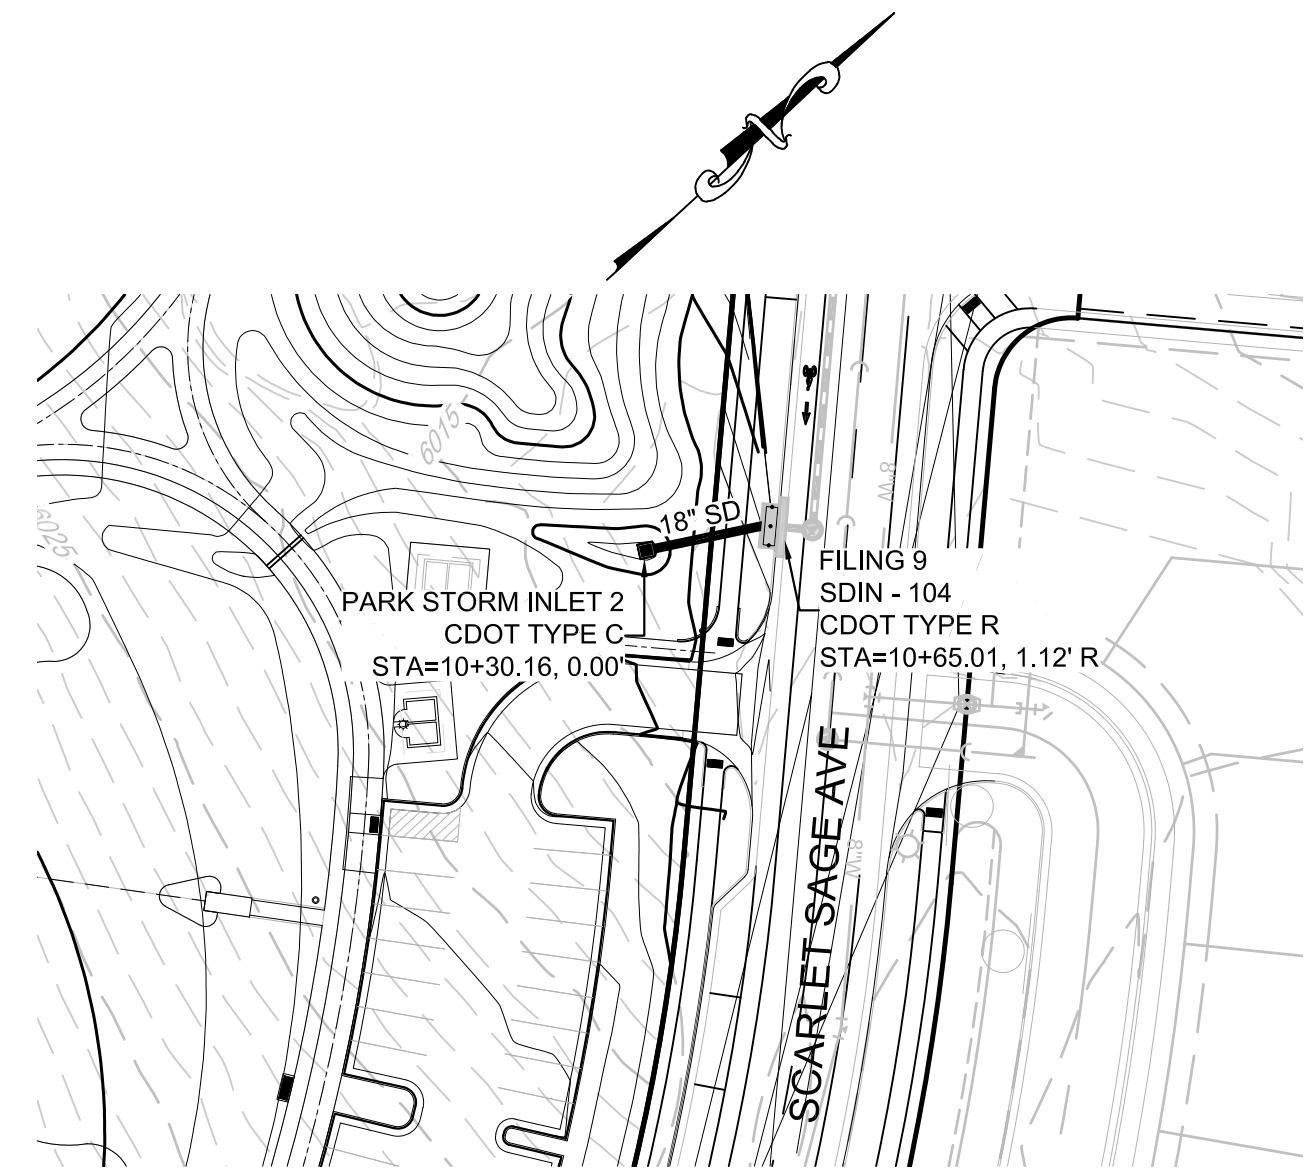

PLAN: PARK STORM LATERAL 2
HORIZONTAL SCALE: 1" = 50'

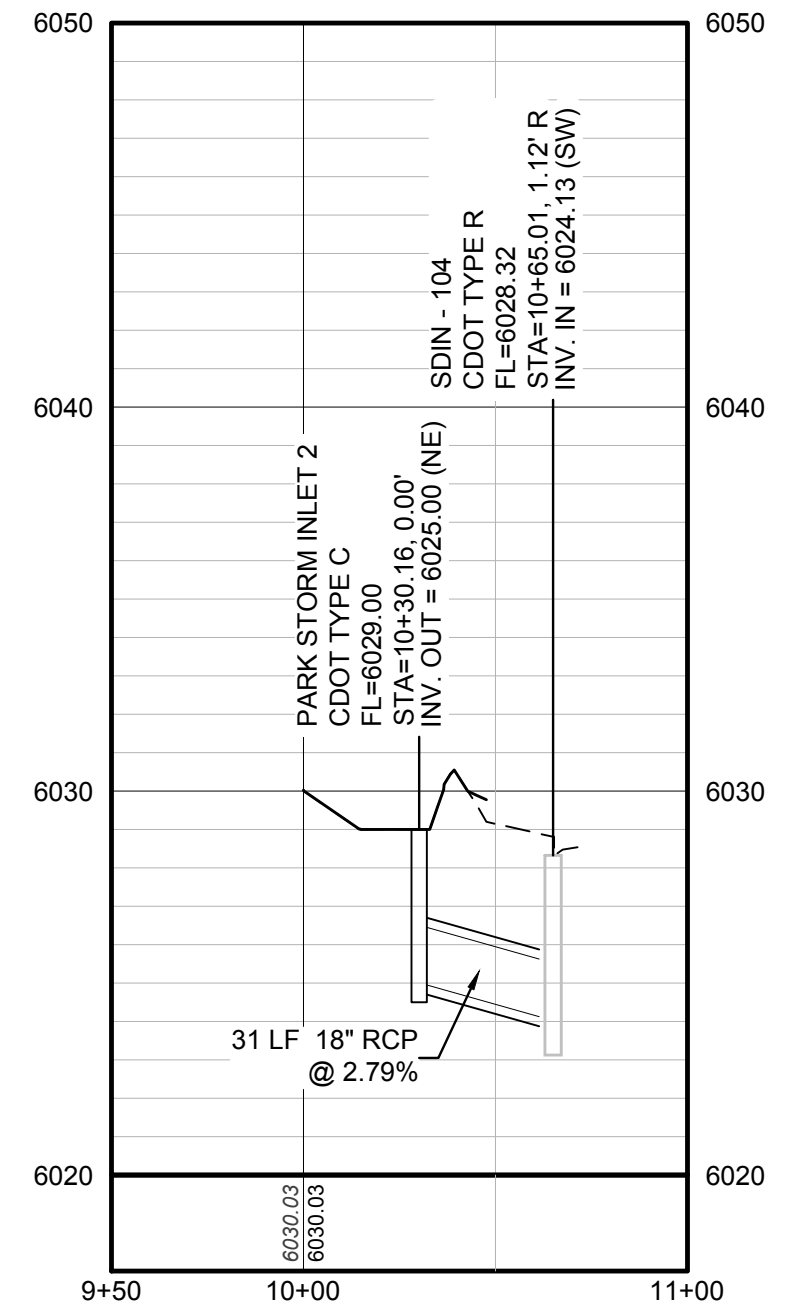

PROFILE: PARK STORM LATERAL 2
HORIZONTAL: 1" = 50'
VERTICAL: 1" = 5'

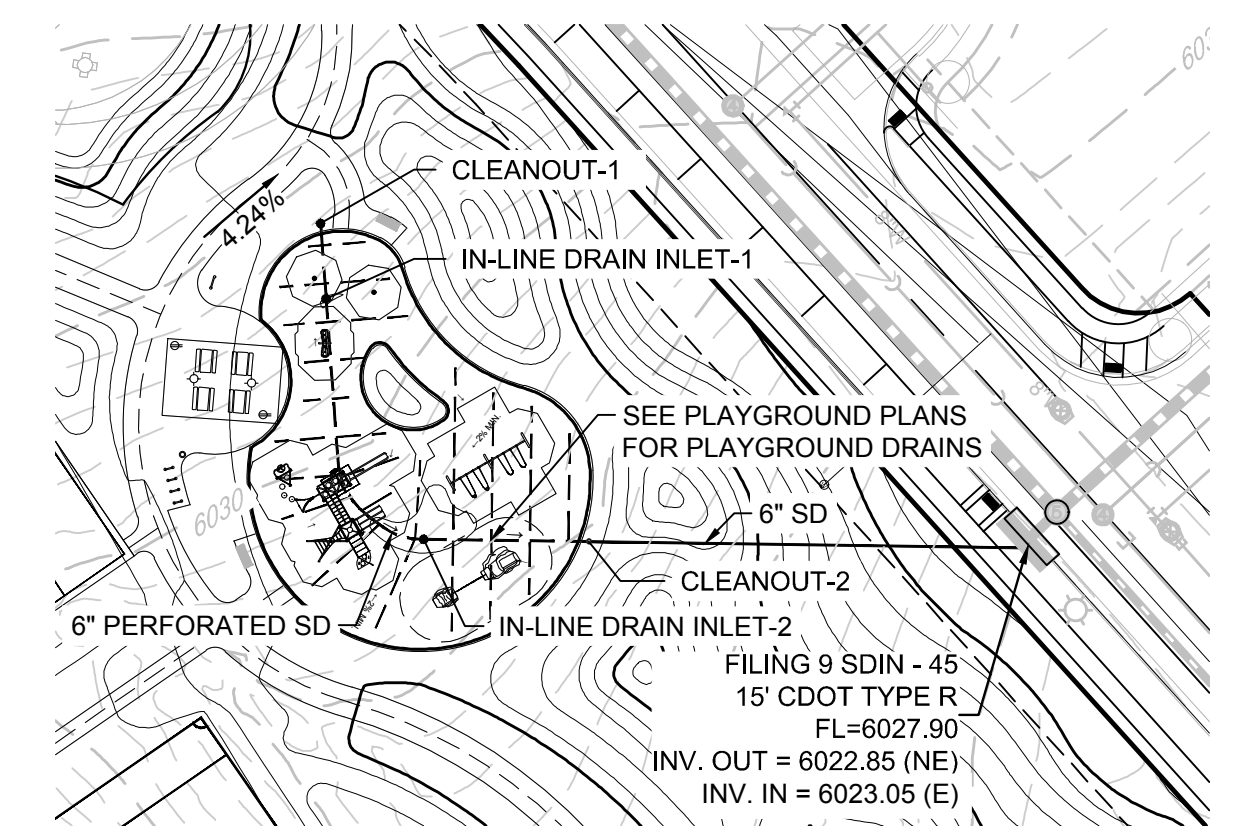

PLAN: PARK STORM LATERAL 3
HORIZONTAL SCALE: 1" = 50'

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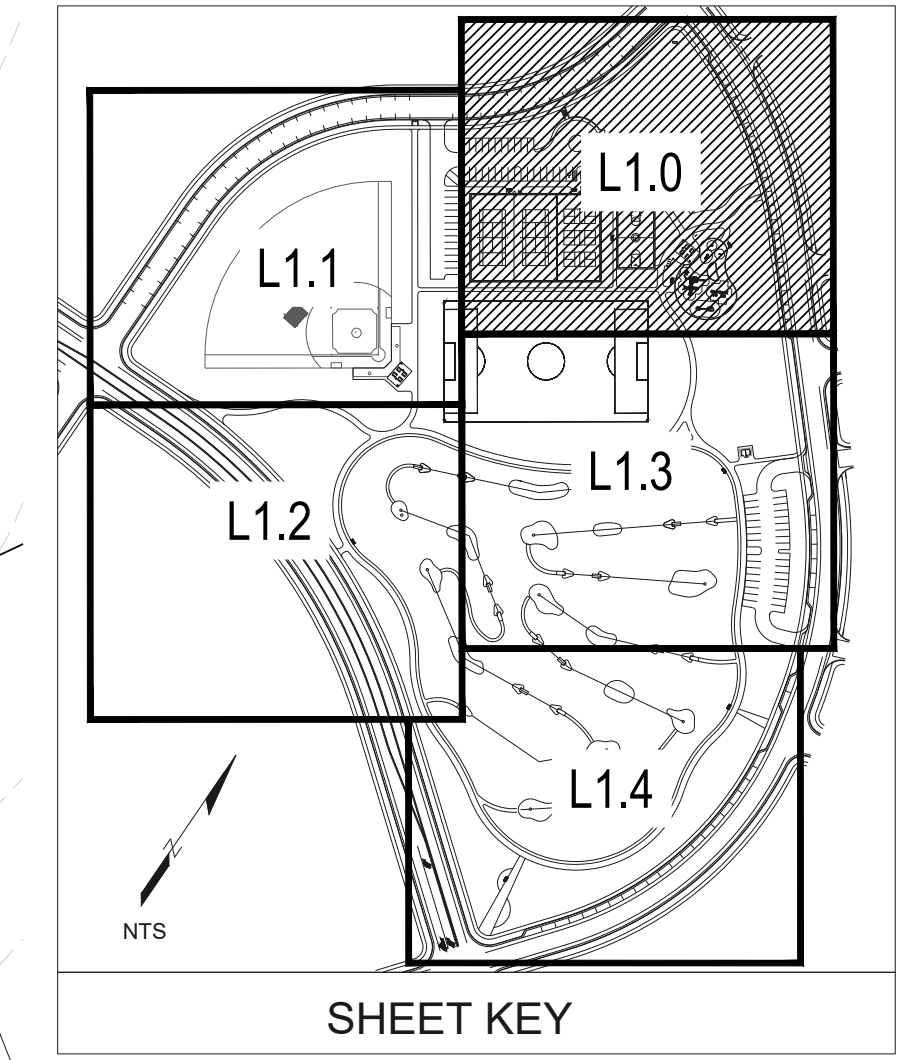
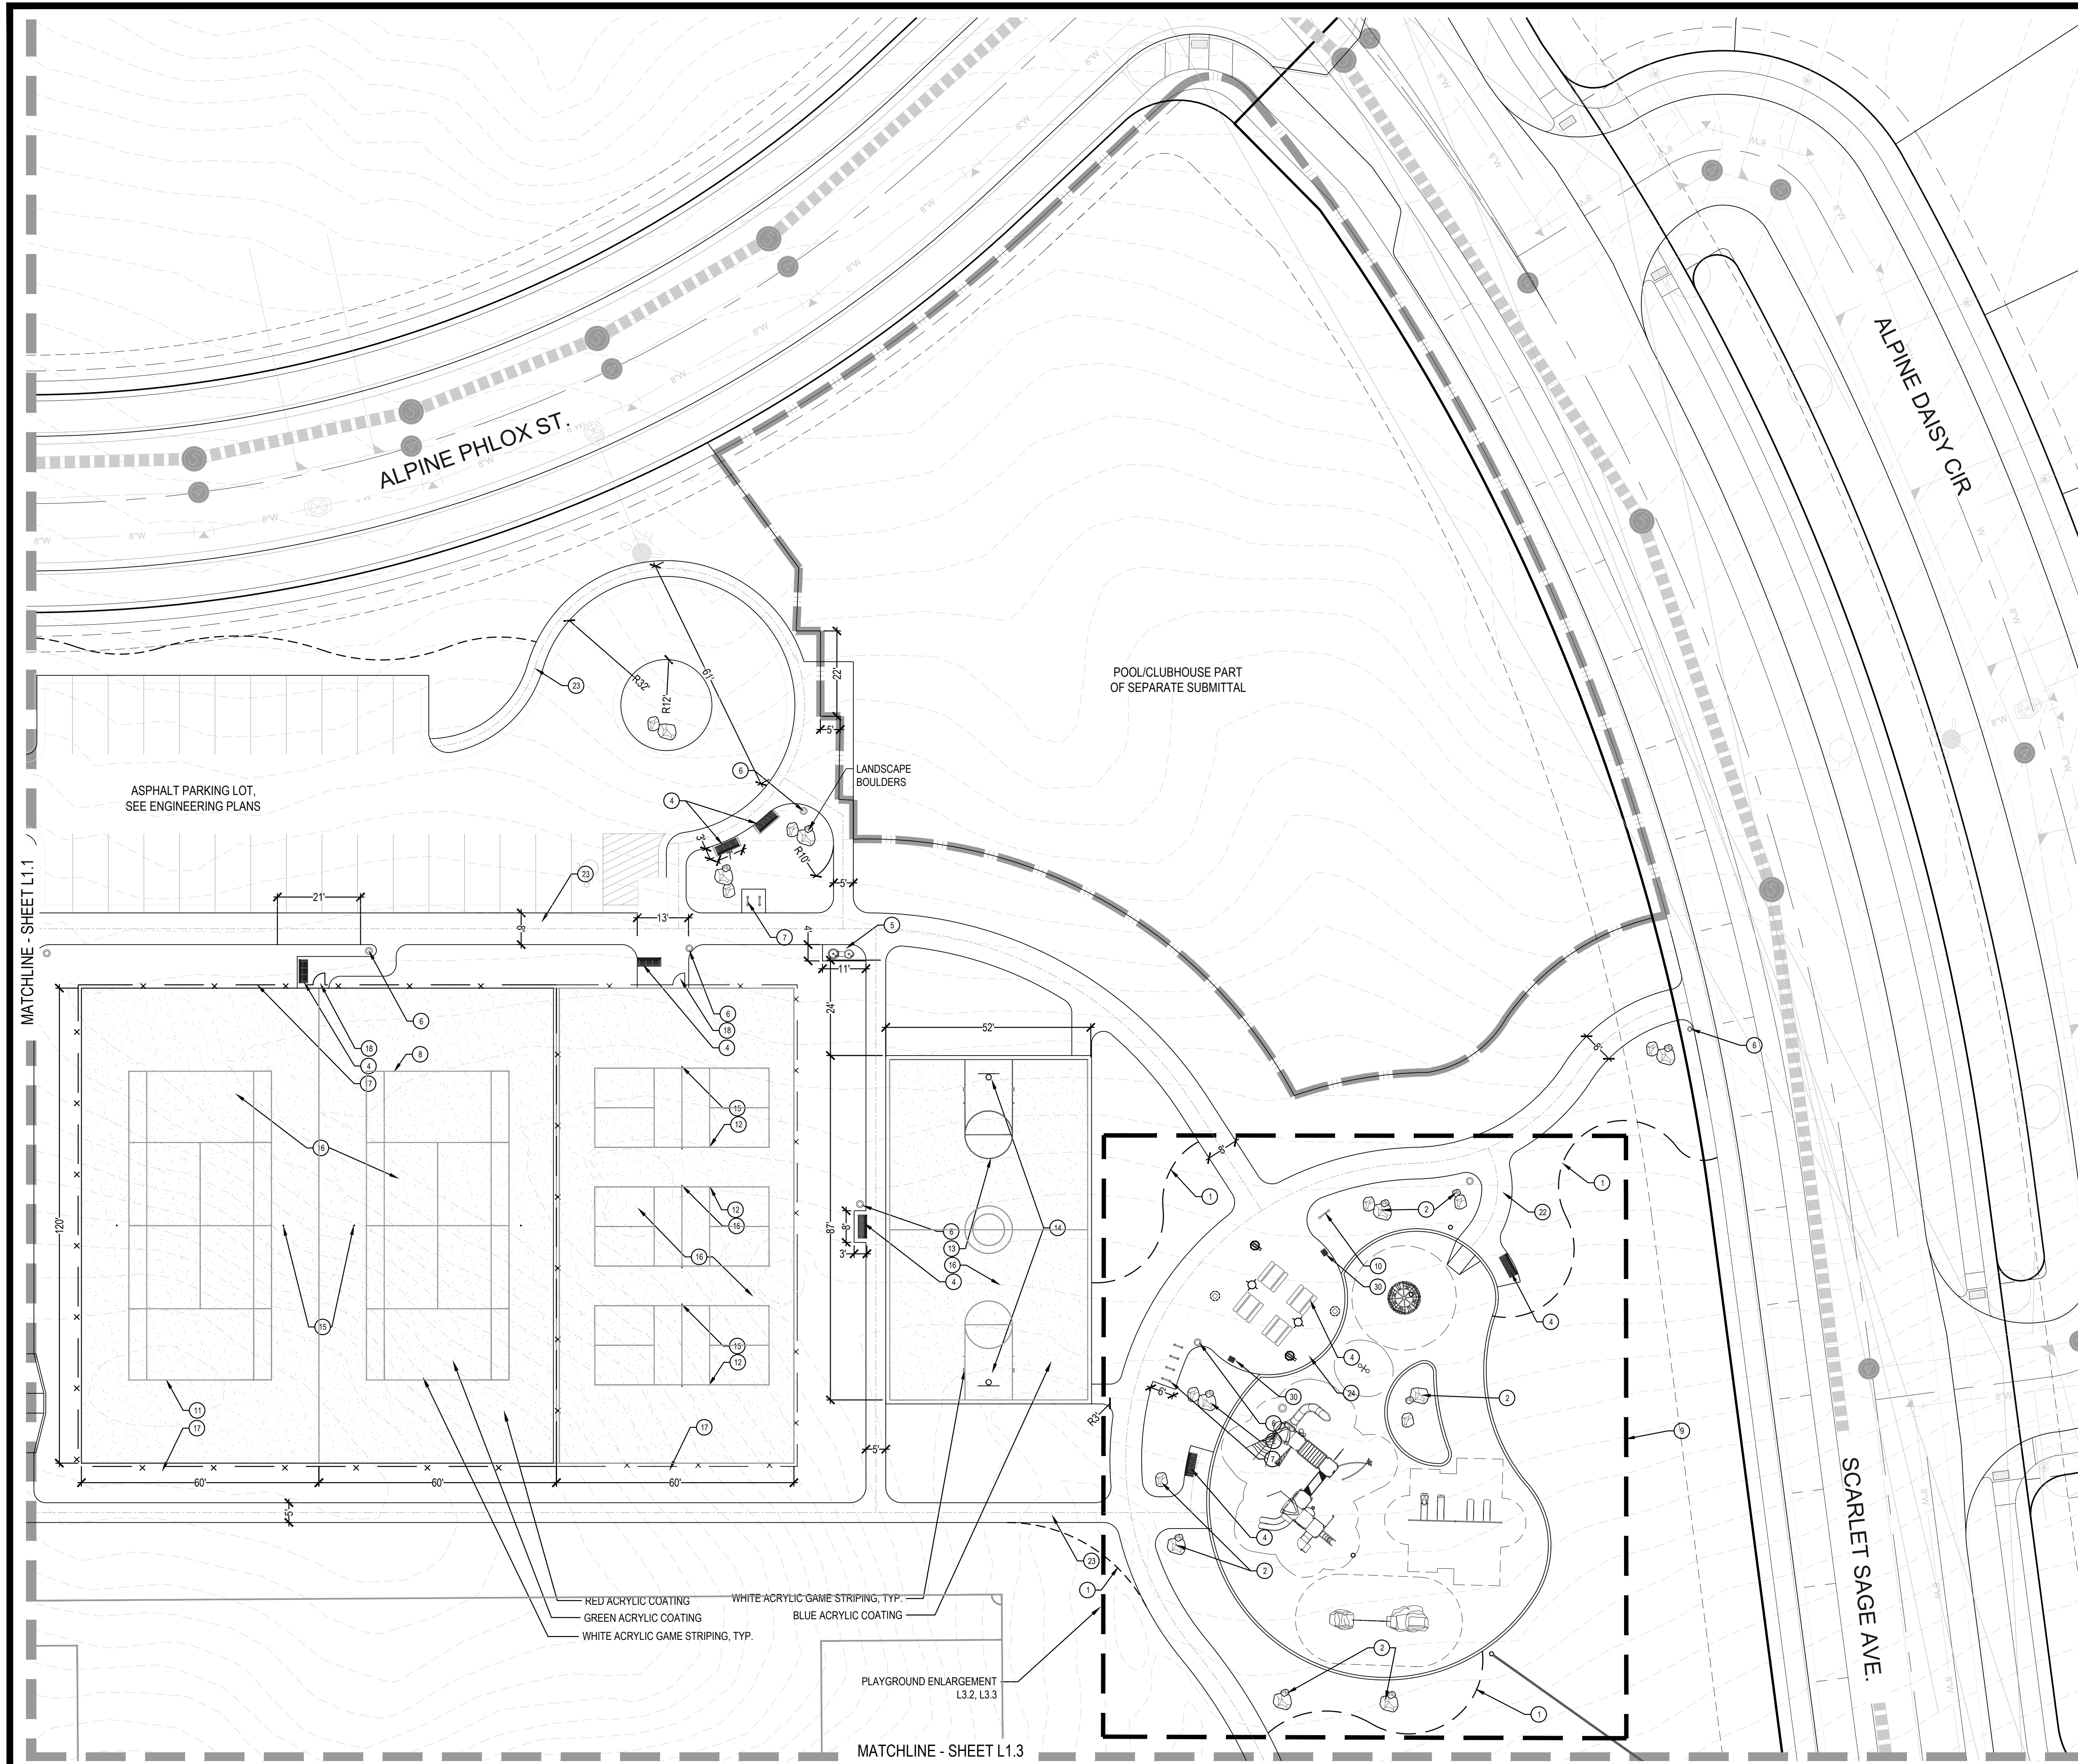
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TRAILS AT CROWFOOT
PARK PLANS
PARKER, COLORADO
LANDSCAPE PLANS


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CONSTRUCTION NOTES

- 1 STEEL EDGER (4, L3.0)
- 2 LANDSCAPE BOULDERS (5, L3.0)
- 3 PICNIC TABLE (1, L3.1)
- 4 BENCH (2, L3.1)
- 5 DRINKING FOUNTAIN (3, L3.1)
- 6 TRASH RECEPTACLE (4, L3.1)
- 7 BIKE RACK (5, L3.1)
- 8 PET WASTE STATION (6, L3.1)
- 9 PLAYGROUND EQUIPMENT & LAYOUT (1, L3.2, L3.3)
- 10 PARK SIGN (7, L3.4)
- 11 TENNIS LAYOUT/STRIPING (1, L3.5)
- 12 PICKLEBALL LAYOUT/STRIPING (2, L3.5)
- 13 BASKETBALL LAYOUT/STRIPING (3, L3.5)
- 14 BASKETBALL GOAL (4, L3.5)
- 15 TENNIS/PICKLEBALL NET & POST (5, L3.5)
- 16 COURT SURFACING (6, L3.5)
- 17 TENNIS/PICKLEBALL FENCE (7, L3.5)
- 18 TENNIS/PICKLEBALL GATE (8, L3.5)
- 19 DISK GOLF TARGET (1, L3.6)
- 20 DISK GOLF TEE (2, L3.6)
- 21 CRUSHER FINES PATH/PAD (3, L3.6)
- 22 LOOP TRAIL (5, L3.6)
- 23 CONCRETE WALKS (6, L3.6)
- 24 SHADE STRUCTURE (7, L3.6)
- 25 BASEBALL CHAIN LINK FENCE (1, L3.7)
- 26 BASEBALL PED. GATE (2, L3.7)
- 27 12' SERVICE GATE (3, L3.7)
- 28 BASEBALL BACKSTOP (4, L3.7)
- 29 DOUBLE VAULT TOILET (1, L3.8)
- 30 OUTDOOR GRILL (7, L3.1)
- 31 DUGOUTS & BENCHES (2, L3.8)



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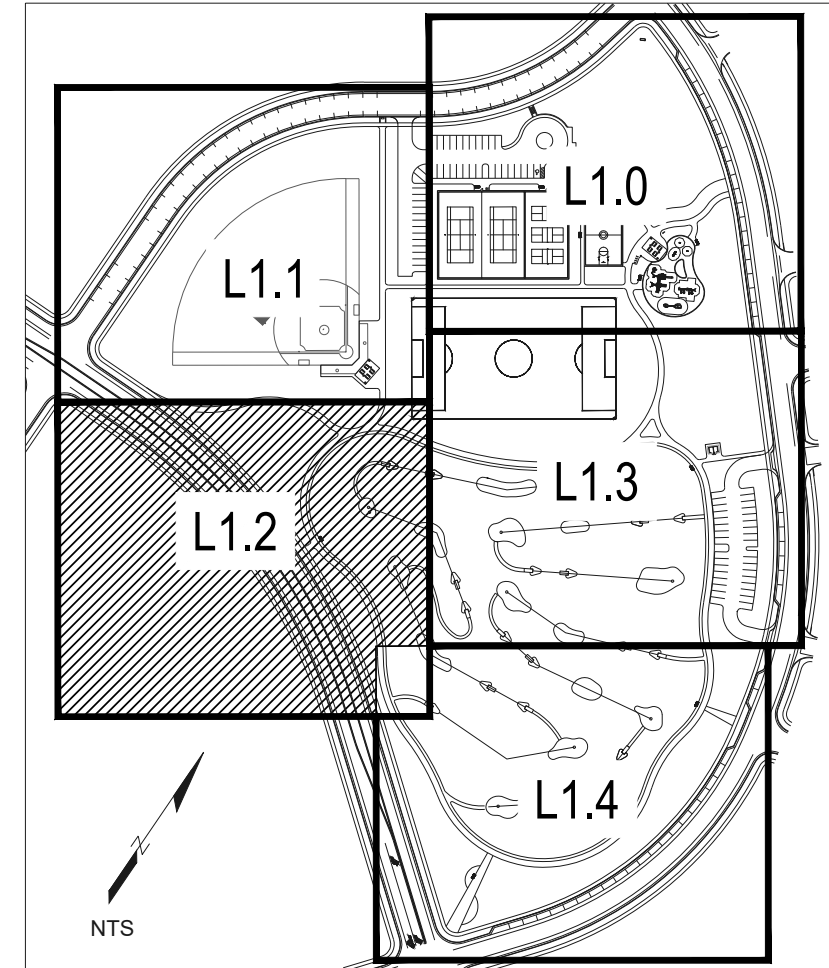
TRAILS AT CROWFOOT
 PARK PLANS
 PARKER, COLORADO
 LANDSCAPE PLANS

Drawn by: BEM, GG
 Checked by: PCS STAFF
 Submittal Date: 08.01.2017
 Date: 02.27.2018
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 10.19.2020
 11.23.2020
 03.16.2022

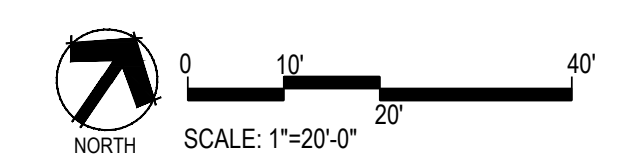Sheet Name
AMENITY PLAN

Sheet Number
L1.0

MATCHLINE - SHEET L1.1



SHEET KEY

CONSTRUCTION NOTES

- 1 STEEL EDGER (4, L3.0)
- 2 LANDSCAPE BOULDERS (5, L3.0)
- 3 PICNIC TABLE. (1, L3.1)
- 4 BENCH. (2, L3.1)
- 5 DRINKING FOUNTAIN (3, L3.1)
- 6 TRASH RECEPTACLE. (4, L3.1)
- 7 BIKE RACK. (5, L3.1)
- 8 PET WASTE STATION. (6, L3.1)
- 9 PLAYGROUND EQUIPMENT & LAYOUT (1, L3.2, L3.3)
- 10 PARK SIGN (7, L3.4)
- 11 TENNIS LAYOUT/STRIPING (1, L3.5)
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- 14 BASKETBALL GOAL. (4, L3.5)
- 15 TENNIS/PICKLEBALL NET & POST (5, L3.5)
- 16 COURT SURFACING. (6, L3.5)
- 17 TENNIS/PICKLEBALL FENCE. (7, L3.5)
- 18 TENNIS/PICKLEBALL GATE. (8, L3.5)
- 19 DISK GOLF TARGET (1, L3.6)
- 20 DISK GOLF TEE (2, L3.6)
- 21 CRUSHER FINES PATH/PAD (3, L3.6)
- 22 LOOP TRAIL (5, L3.6)
- 23 CONCRETE WALKS (6, L3.6)
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- 29 DOUBLE VAULT TOILET (1, L3.8)
- 30 OUTDOOR GRILL (7, L3.1)
- 31 DUGOUTS & BENCHES (2, L3.8)

CRUSHER FINES PATHS TO DISK GOLF TEES TO BE LAID OUT IN THE FIELD


UNDISTURBED AREA

MATCHLINE - SHEET L1.4

MATCHLINE - SHEET L1.4

MATCHLINE - SHEET L1.3

N. PINERY PARKWAY

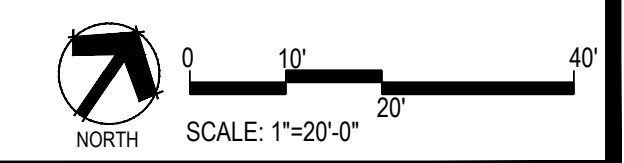

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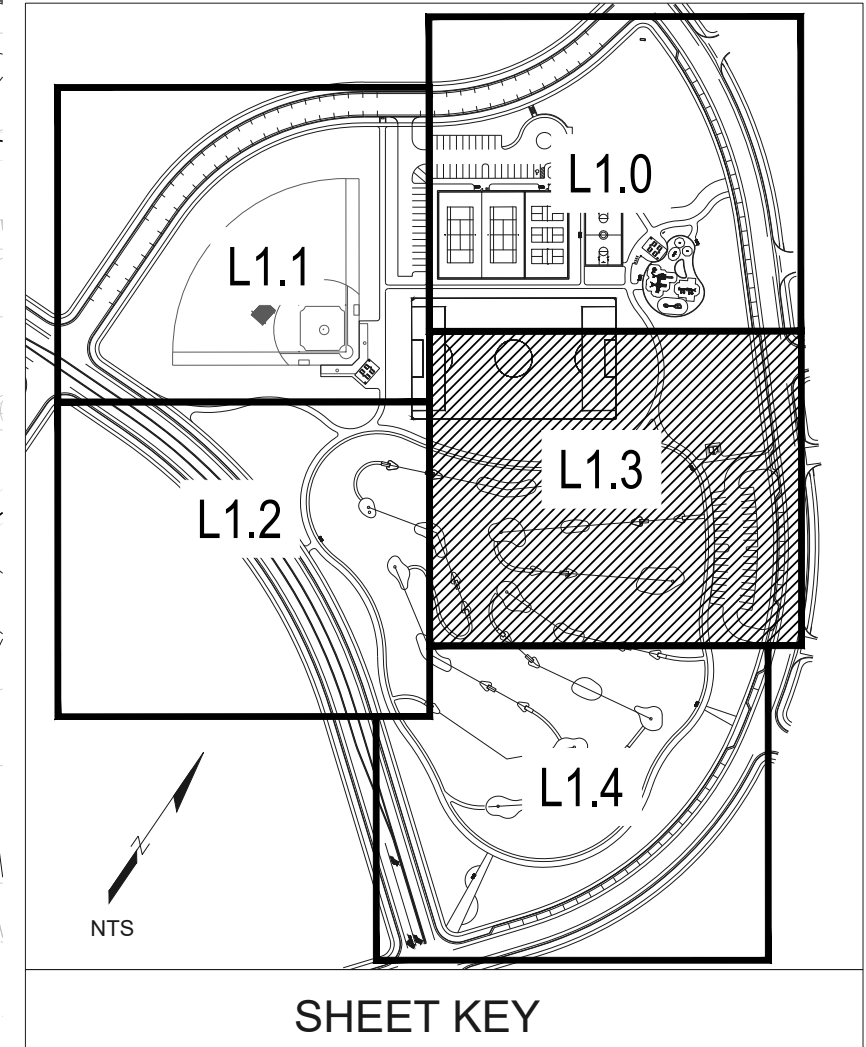
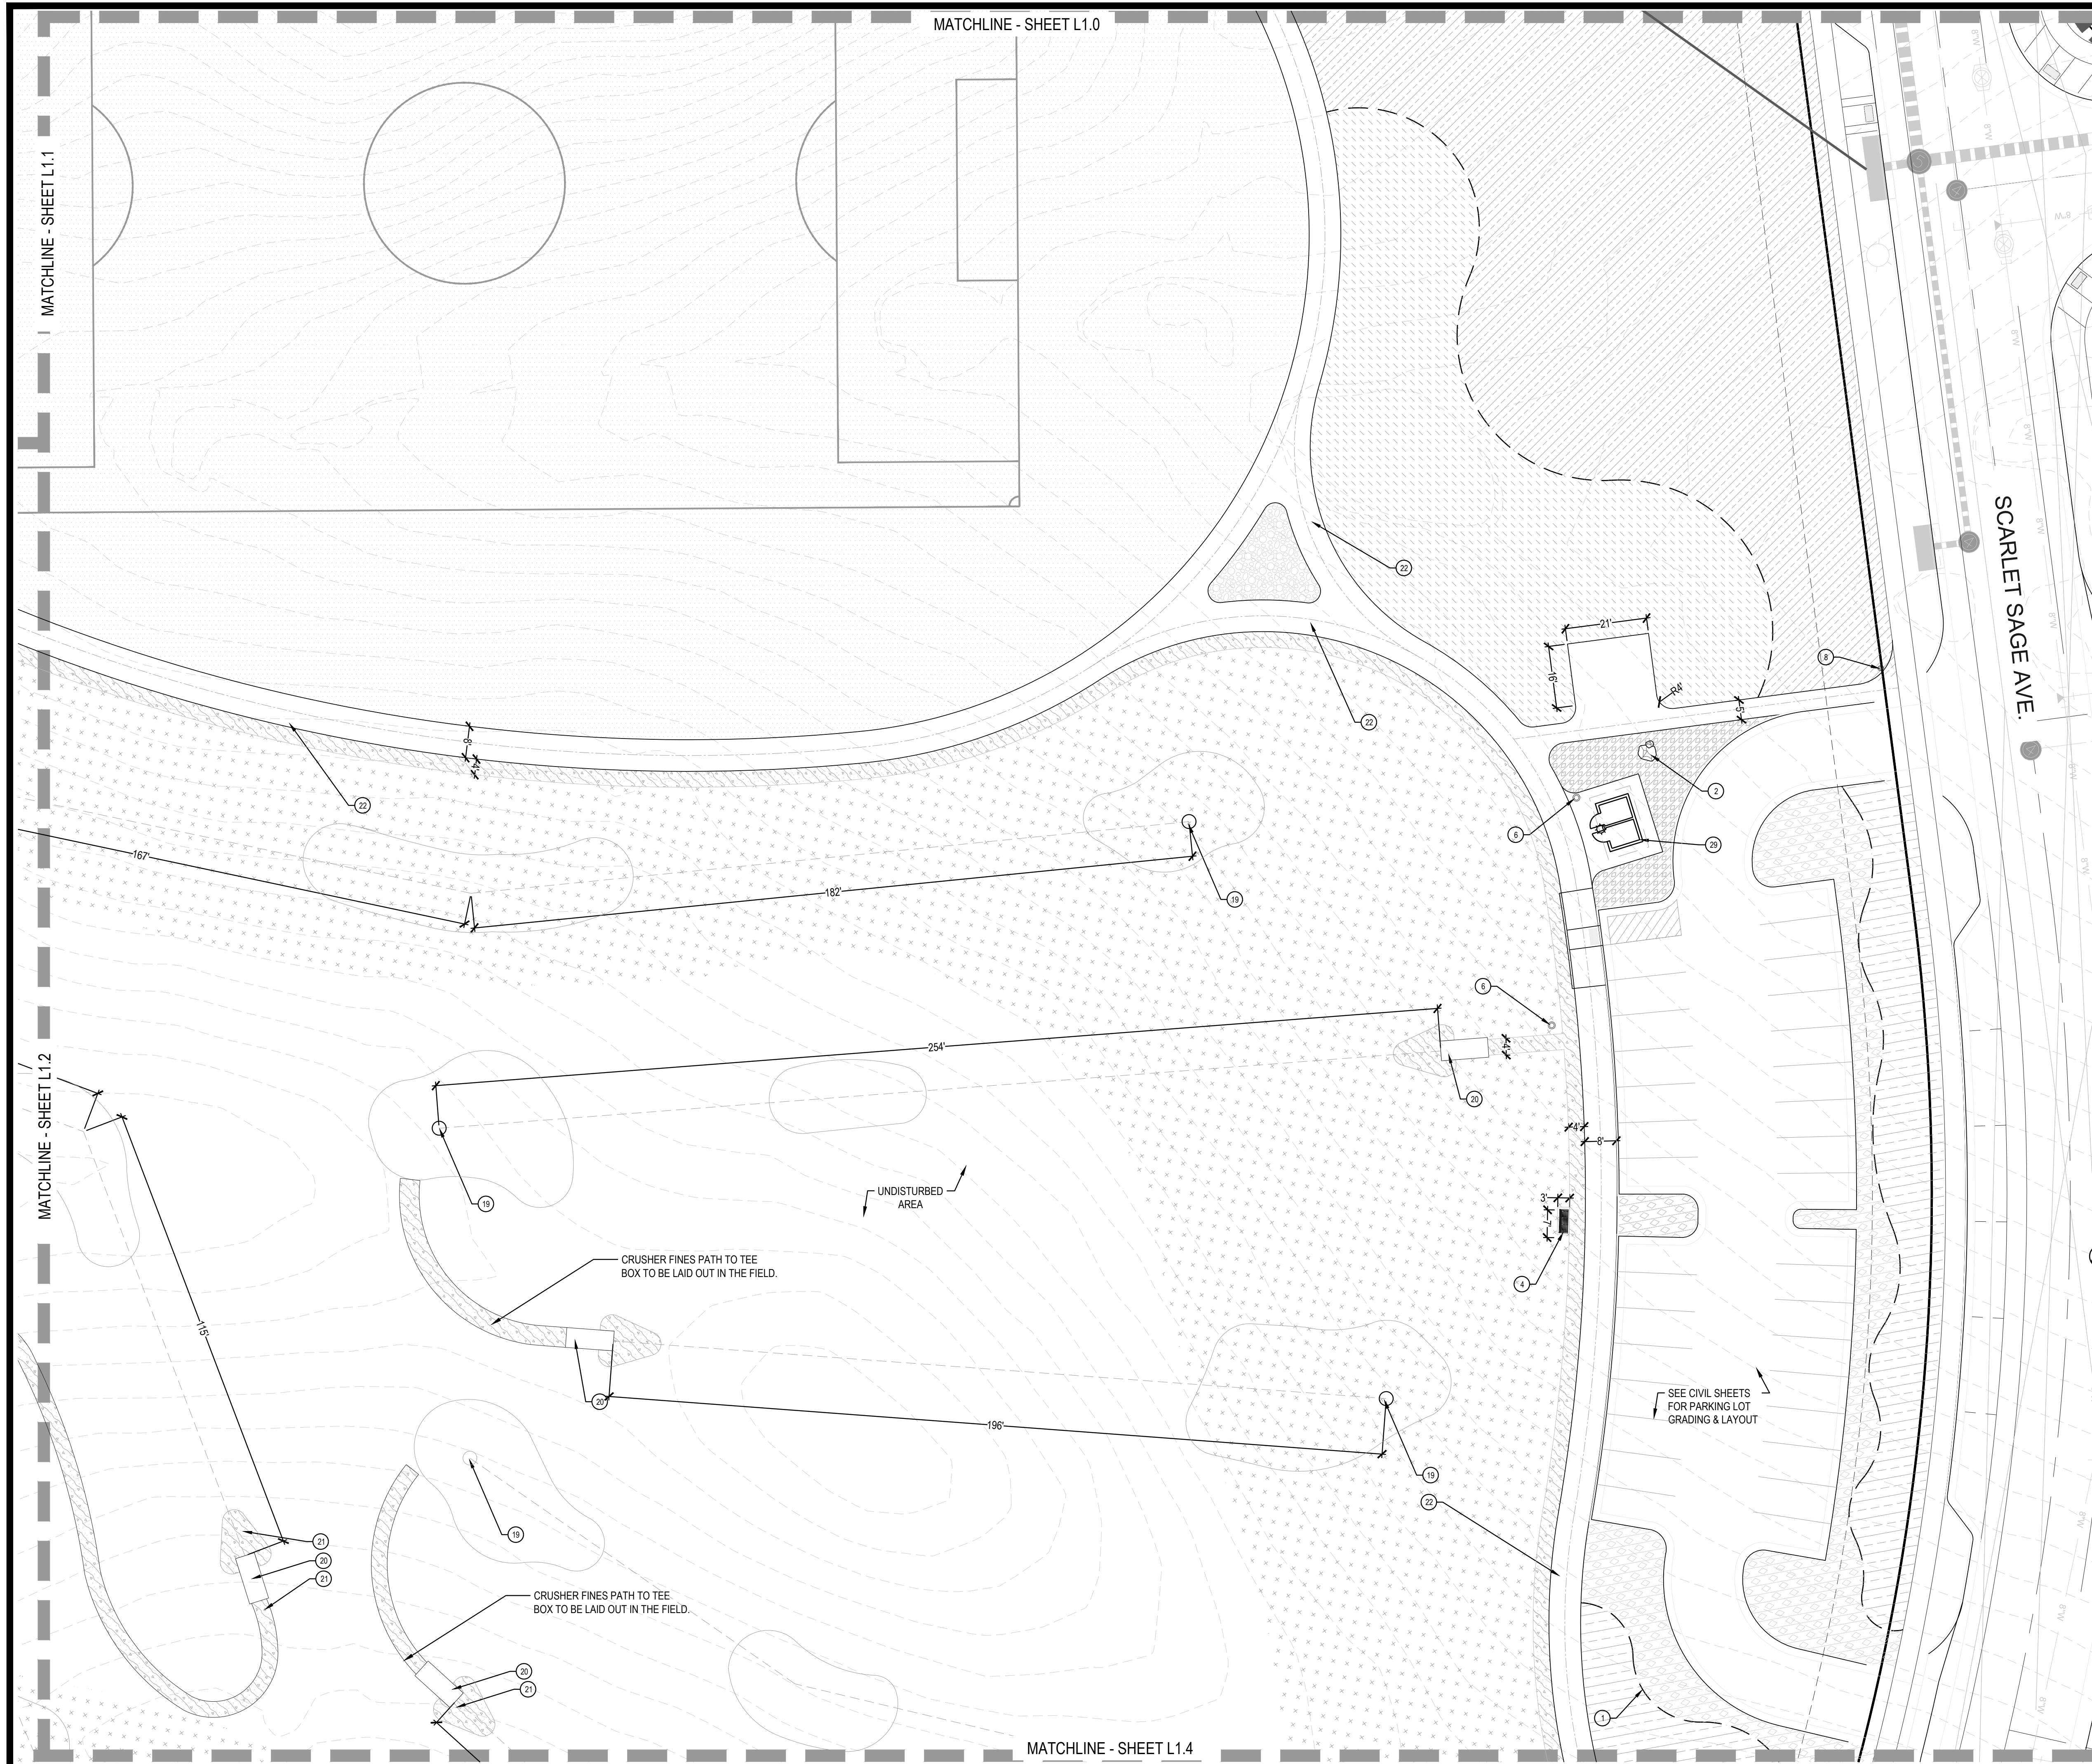
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TRAILS AT CROWFOOT
 PARK PLANS
 PARKER, COLORADO
 LANDSCAPE PLANS

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 Checked by: PCS STAFF
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11.23.2020
03.16.2022


Sheet Name
AMENITY PLAN

Sheet Number
L1.2



CONSTRUCTION NOTES

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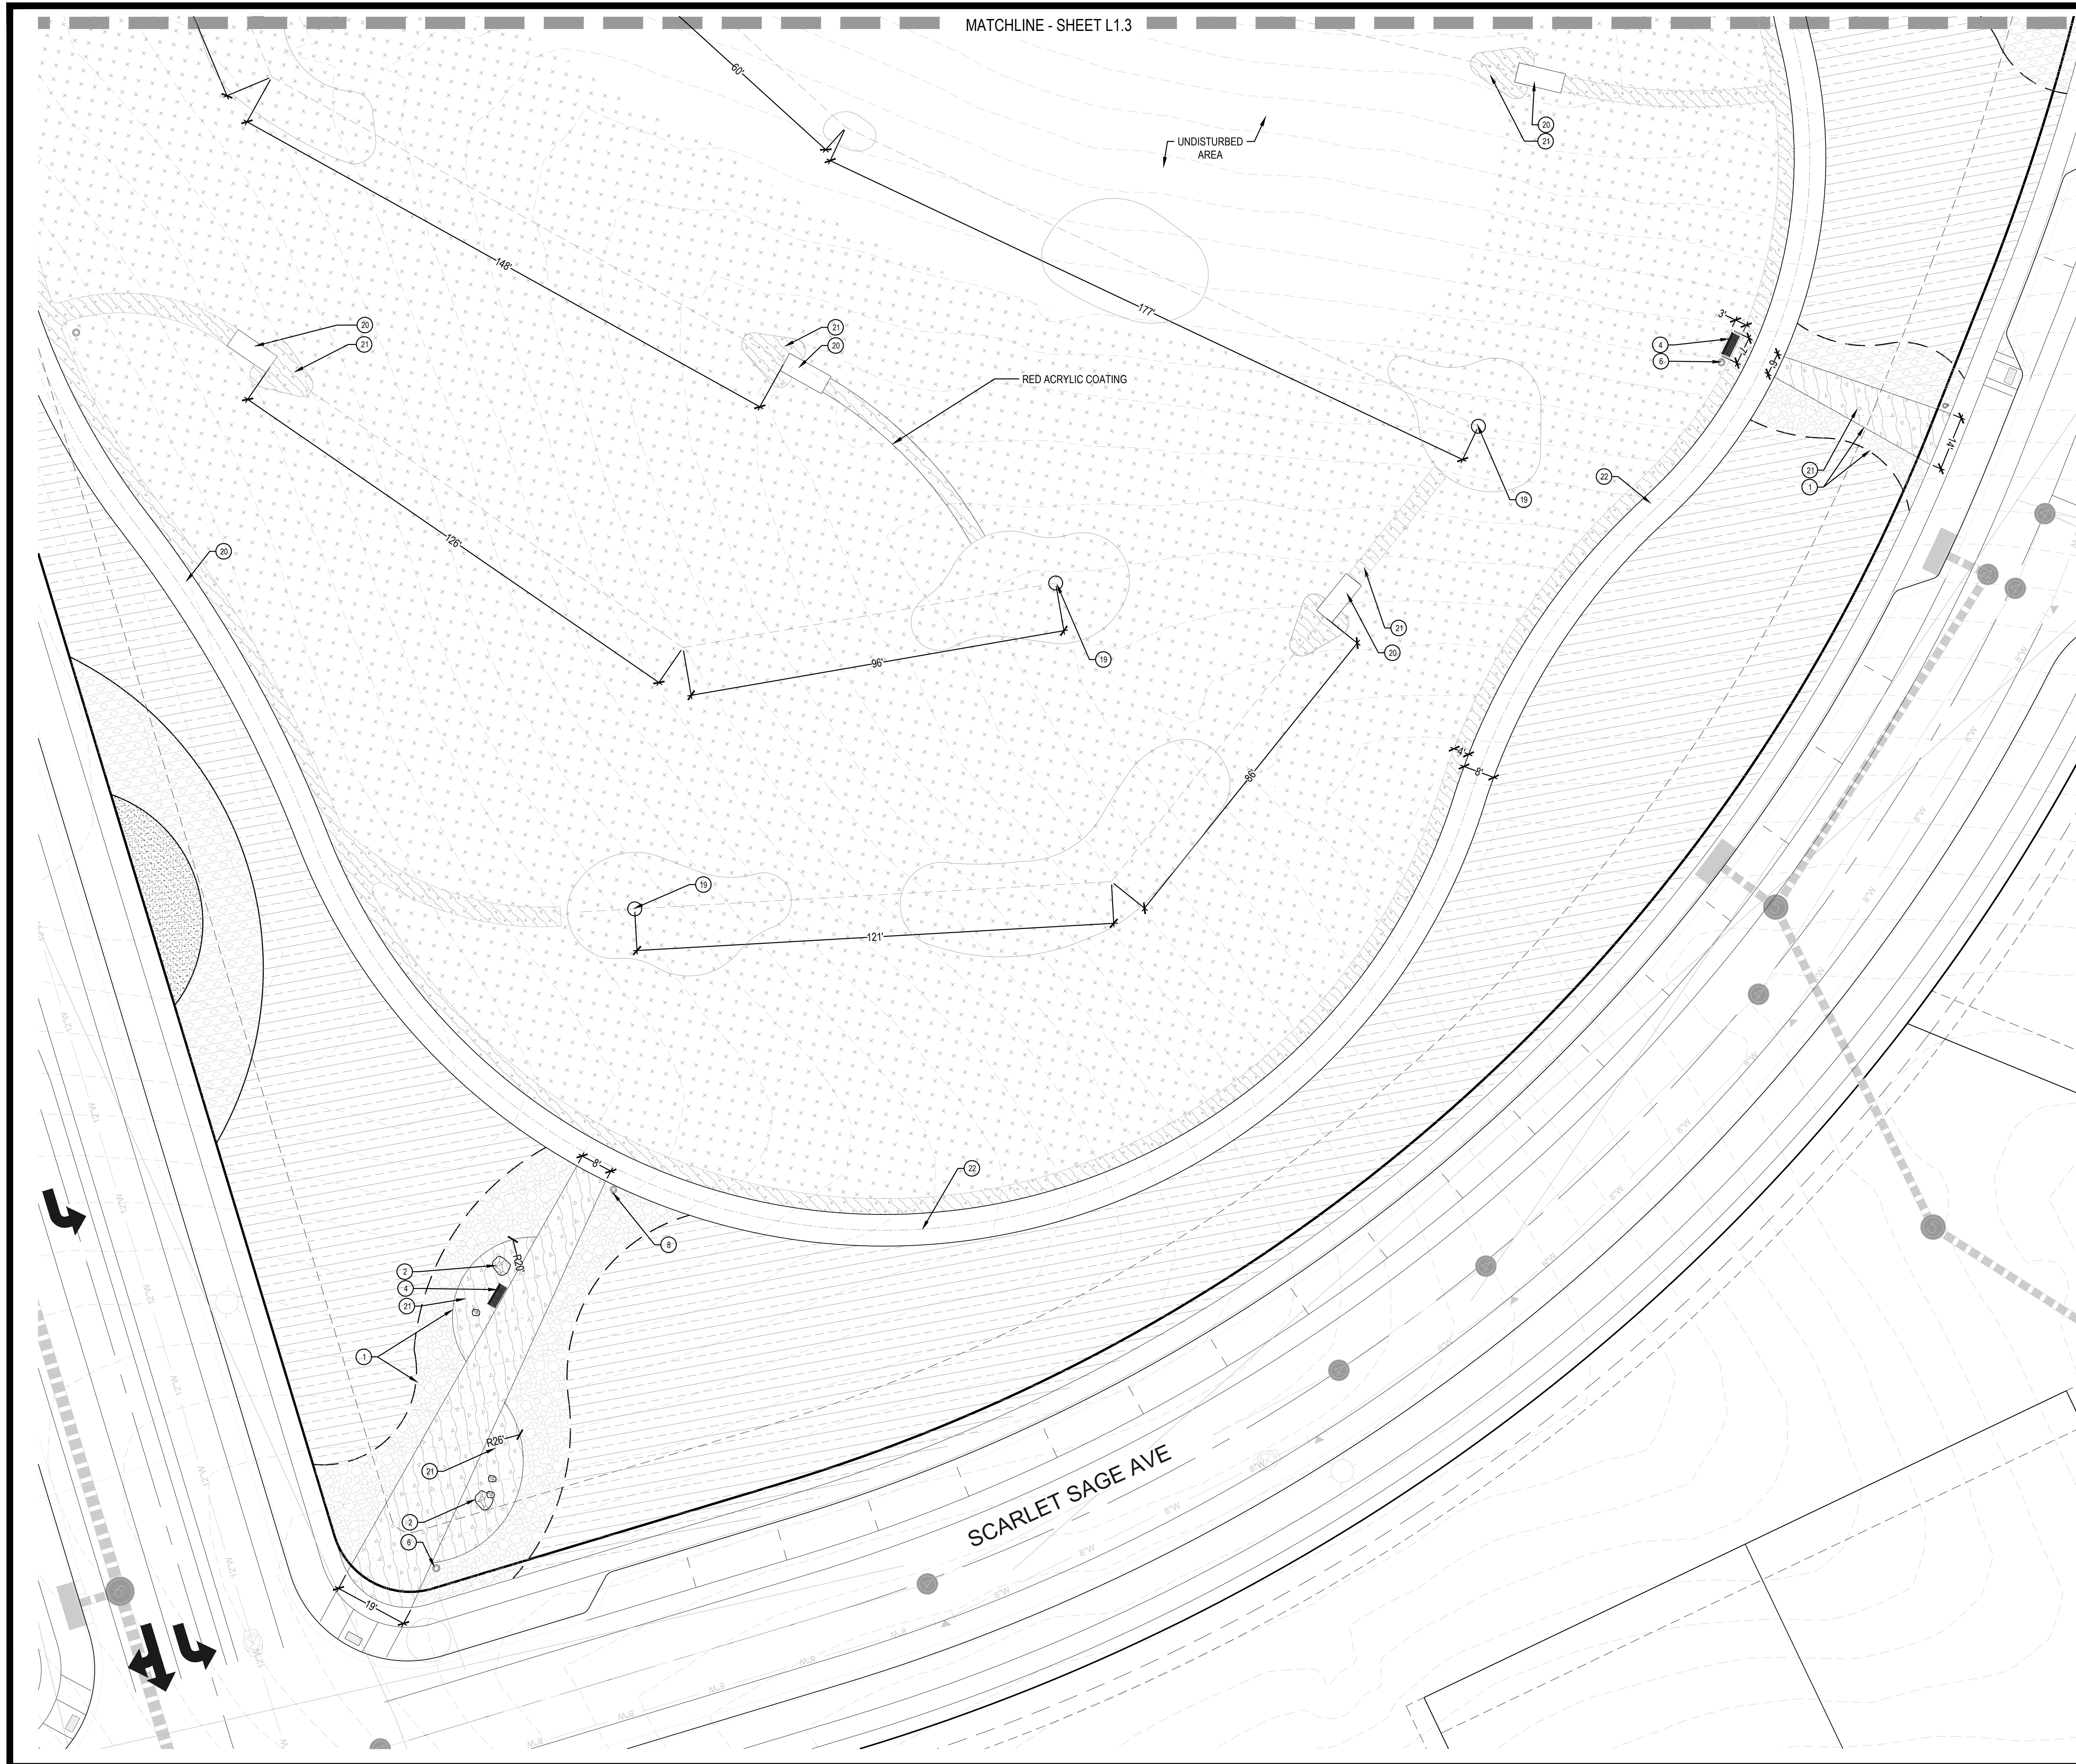
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 PARK PLANS
 PARKER, COLORADO
 LANDSCAPE PLANS

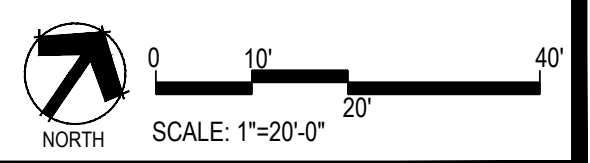Drawn by: BEM, GG
 Checked by: PCS STAFF
 Submittal Date: 08.01.2017
 Date: 02.27.2018
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 11.23.2020
 03.16.2022

Sheet Name
AMENITY PLAN

Sheet Number
L1.3




MATCHLINE - SHEET L1.3

UNDISTURBED AREA


RED ACRYLIC COATING

SCARLET SAGE AVE

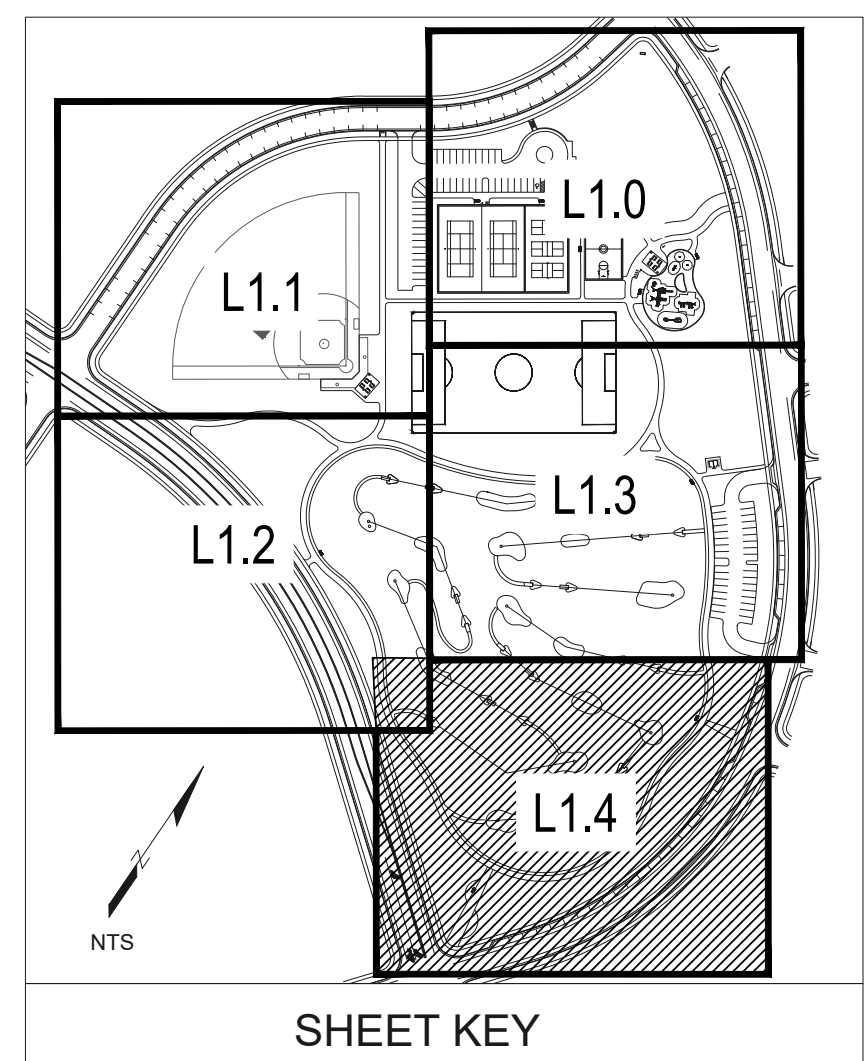

CONSTRUCTION NOTES

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- 18 TENNIS/PICKLEBALL GATE (8, L3.5)
- 19 DISK GOLF TARGET (1, L3.6)
- 20 DISK GOLF TEE (2, L3.6)
- 21 CRUSHER FINES PATH/PAD (3, L3.6)
- 22 LOOP TRAIL (5, L3.6)
- 23 CONCRETE WALKS (6, L3.6)
- 24 SHADE STRUCTURE (7, L3.6)
- 25 BASEBALL CHAIN LINK FENCE (1, L3.7)
- 26 BASEBALL PED. GATE (2, L3.7)
- 27 12' SERVICE GATE (3, L3.7)
- 28 BASEBALL BACKSTOP (4, L3.7)
- 29 DOUBLE VAULT TOILET (1, L3.8)
- 30 OUTDOOR GRILL (7, L3.1)
- 31 DUGOUTS & BENCHES (2, L3.8)

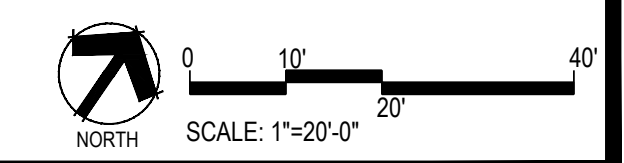

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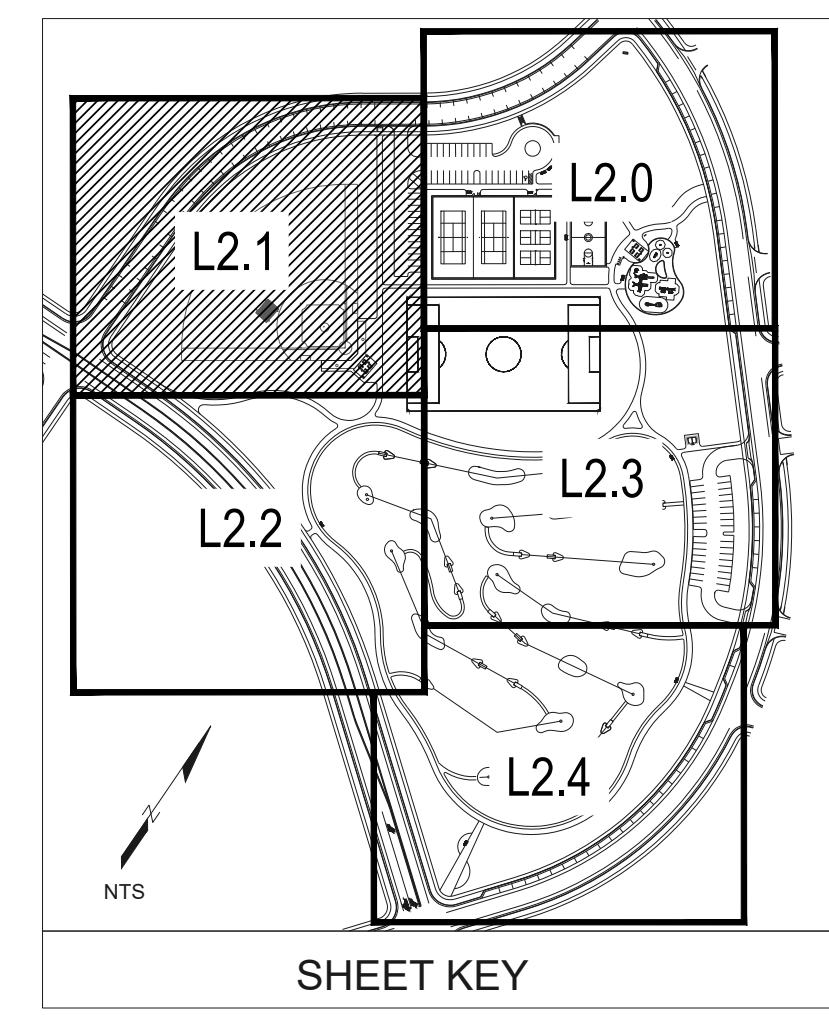
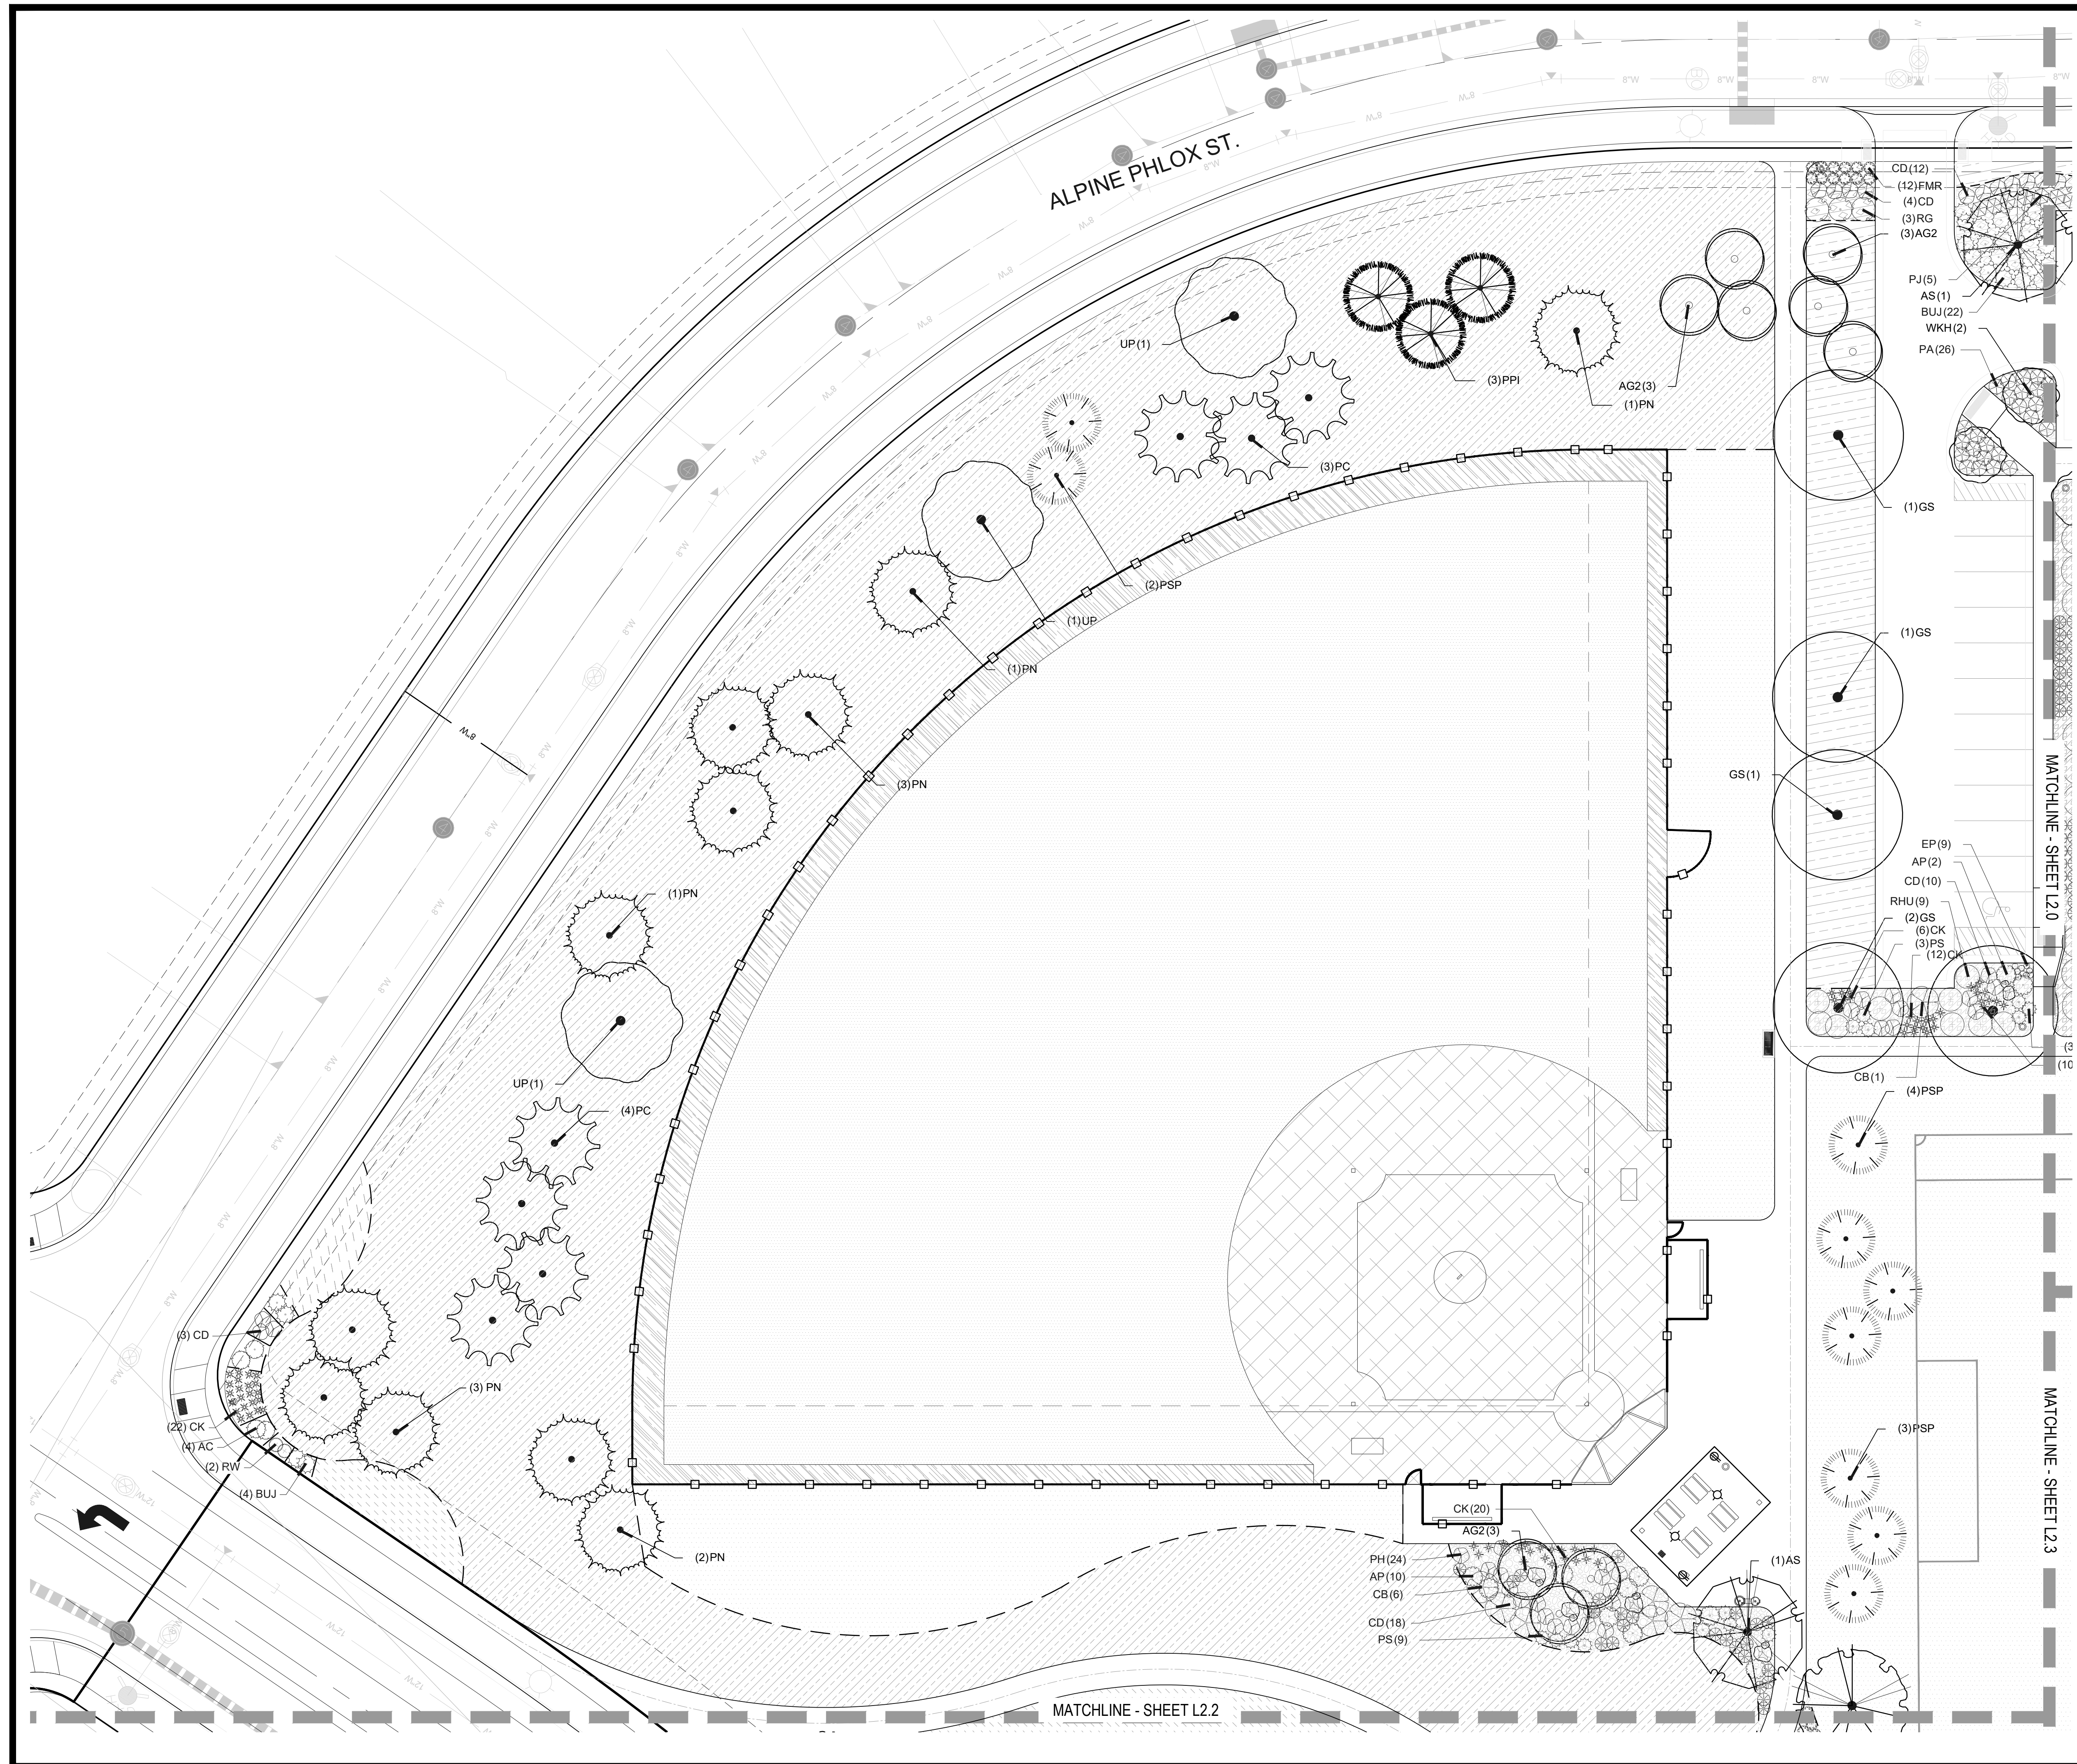
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TRAILS AT CROWFOOT
 PARK PLANS
 PARKER, COLORADO
 LANDSCAPE PLANS

Drawn by:	BEM, GG
Checked by:	PCS STAFF
Submittal Date:	08.01.2017
Date:	02.27.2018
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Sheet Name
AMENITY PLAN

Sheet Number
L1.4



PLANT SCHEDULE

COMMON NAME	COMMON NAME
DECIDUOUS TREES	COMMON NAME
AS Schwedler Maple	AS Schwedler Maple
BR River Birch	BR River Birch
GI Imperial Honeylocust	GI Imperial Honeylocust
GS Shademoor Locust	GS Shademoor Locust
GK Kentucky Coffee Tree	GK Kentucky Coffee Tree
OV American Hornbeam	OV American Hornbeam
PO American Sycamore	PO American Sycamore
QM Burr Oak	QM Burr Oak
QM2 Chinquapin Oak	QM2 Chinquapin Oak
QR Red Oak	QR Red Oak
TG2 Glenleven Littleleaf Linden	TG2 Glenleven Littleleaf Linden
TG Greenspire Littleleaf Linden	TG Greenspire Littleleaf Linden
UP American Elm	UP American Elm
EVERGREEN TREES	COMMON NAME
PC Colorado Spruce	PC Colorado Spruce
VAN Vanderwolf's Pyramid Pine	VAN Vanderwolf's Pyramid Pine
PSP Limber Pine	PSP Limber Pine
PN Austrian Black Pine	PN Austrian Black Pine
PPI Ponderosa Pine	PPI Ponderosa Pine
ORNAMENTAL TREES	COMMON NAME
AG2 Rocky Mountain Maple	AG2 Rocky Mountain Maple
WKH 'Winter King' Hawthorn	WKH 'Winter King' Hawthorn
ORNAMENTAL GRASSES	COMMON NAME
CK Feather Reed Grass	CK Feather Reed Grass
MY Yaku Jima Dwarf Maiden Grass	MY Yaku Jima Dwarf Maiden Grass
PH Blue Switch Grass	PH Blue Switch Grass
PB2 Little Bunny Fountain Grass	PB2 Little Bunny Fountain Grass
ANNUALS/PERENNIALS	COMMON NAME
EP Threadleaf Coreopsis	EP Threadleaf Coreopsis
EP Purple Coneflower	EP Purple Coneflower
BES Black-eyed Susan	BES Black-eyed Susan
DECIDUOUS SHRUBS	COMMON NAME
SSB Saskatoon Serviceberry	SSB Saskatoon Serviceberry
AG 'Autumn Brilliance' Serviceberry	AG 'Autumn Brilliance' Serviceberry
CD Blue Mist Shrub	CD Blue Mist Shrub
RB Rabbitbrush	RB Rabbitbrush
CB Red Twig Dogwood	CB Red Twig Dogwood
CH Rock Cotoneaster	CH Rock Cotoneaster
PS2 Rocky Mountain Penstemon	PS2 Rocky Mountain Penstemon
PA Russian Sage	PA Russian Sage
PJ Jackman's Potentilla	PJ Jackman's Potentilla
RHU Gro-Low Fragrant Sumac	RHU Gro-Low Fragrant Sumac
RG Golden Currant	RG Golden Currant
FMR Fire Meidiland Rose	FMR Fire Meidiland Rose
RW White Meidiland Rose	RW White Meidiland Rose
EVERGREEN SHRUBS	COMMON NAME
AC Manzanita	AC Manzanita
AP Panchito Manzanita	AP Panchito Manzanita
JB Blue Chip Juniper	JB Blue Chip Juniper
JH Hughes Juniper	JH Hughes Juniper
BUJ Buffalo Juniper	BUJ Buffalo Juniper
PS Mugo Pine	PS Mugo Pine
GROUND COVERS	COMMON NAME
[Symbol] BLUEGRASS SOD	BLUEGRASS SOD
[Symbol] RE: LANDSCAPE NOTES	RE: LANDSCAPE NOTES
[Symbol] BUFFALO GRASS	BUFFALO GRASS
[Symbol] RE: LANDSCAPE NOTES	RE: LANDSCAPE NOTES
[Symbol] CRUSHER FINES	CRUSHER FINES
[Symbol] ENV/ROTURF	ENV/ROTURF
[Symbol] RE: LANDSCAPE NOTES	RE: LANDSCAPE NOTES
[Symbol] FIBAR PLAYGROUND MULCH	FIBAR PLAYGROUND MULCH
[Symbol] G&S SOLUTIONS-CLASSIC INFIELD MIX. GOLD	G&S SOLUTIONS-CLASSIC INFIELD MIX. GOLD
[Symbol] COLOR: GOLD, WITHOUT STABILIZER	COLOR: GOLD, WITHOUT STABILIZER
[Symbol] ROCK MULCH GREY, 1-1/2" MOUNTAIN GRANITE	ROCK MULCH GREY, 1-1/2" MOUNTAIN GRANITE
[Symbol] 3" DEPTH, RE: LDSCP NOTES	3" DEPTH, RE: LDSCP NOTES
[Symbol] ROCK MULCH GRAY-1-1/2" MTN GRANITE	ROCK MULCH GRAY-1-1/2" MTN GRANITE
[Symbol] 3" DEPTH, RE: LDSCP NOTES	3" DEPTH, RE: LDSCP NOTES
[Symbol] SEED MIX 1	SEED MIX 1
[Symbol] TOWN OF PARKER - SEED MIX 1,	TOWN OF PARKER - SEED MIX 1,
[Symbol] RE: LANDSCAPE NOTES	RE: LANDSCAPE NOTES
[Symbol] SEED MIX 2	SEED MIX 2
[Symbol] TOWN OF PARKER - SEED MIX 2,	TOWN OF PARKER - SEED MIX 2,
[Symbol] RE: LANDSCAPE NOTES	RE: LANDSCAPE NOTES
[Symbol] G&S SOLUTIONS CLASSIC WARNING TRACK MIX	G&S SOLUTIONS CLASSIC WARNING TRACK MIX
[Symbol] COLOR: GOLD, WITHOUT STABILIZER	COLOR: GOLD, WITHOUT STABILIZER

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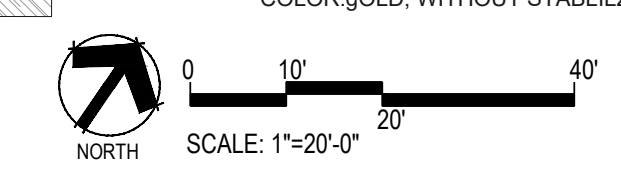
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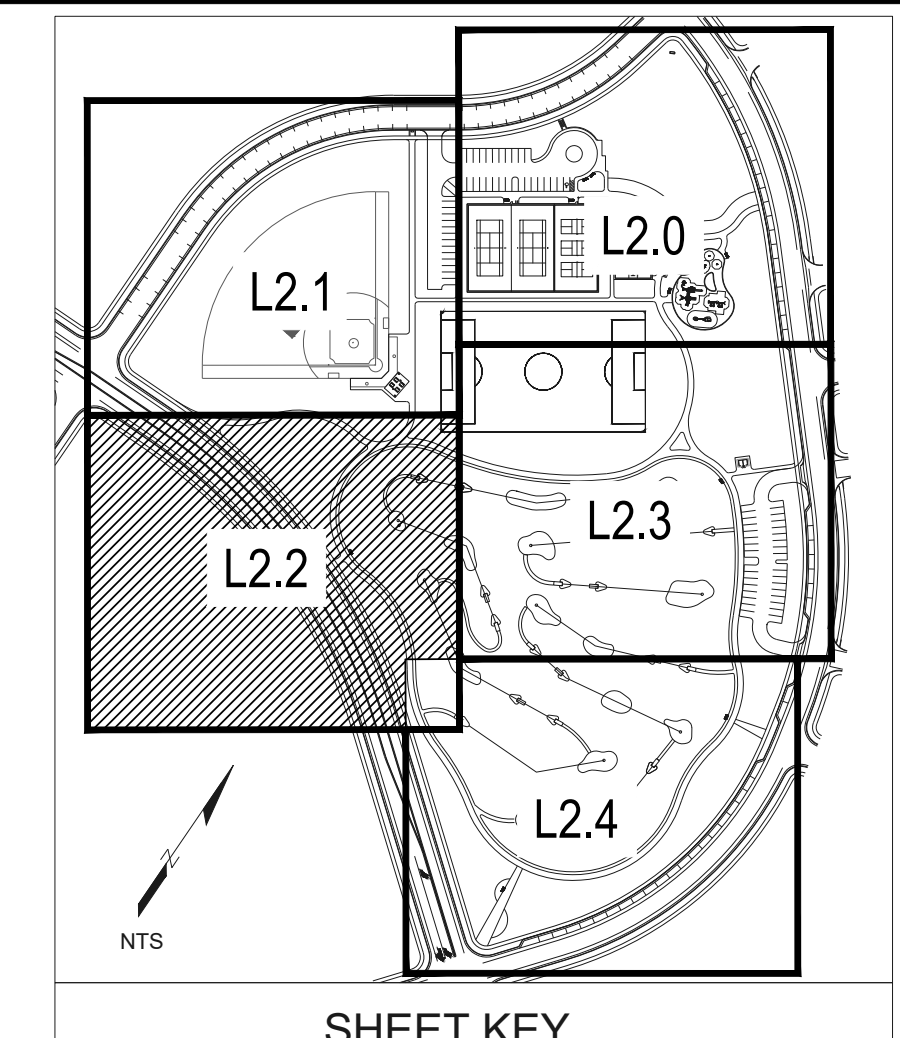
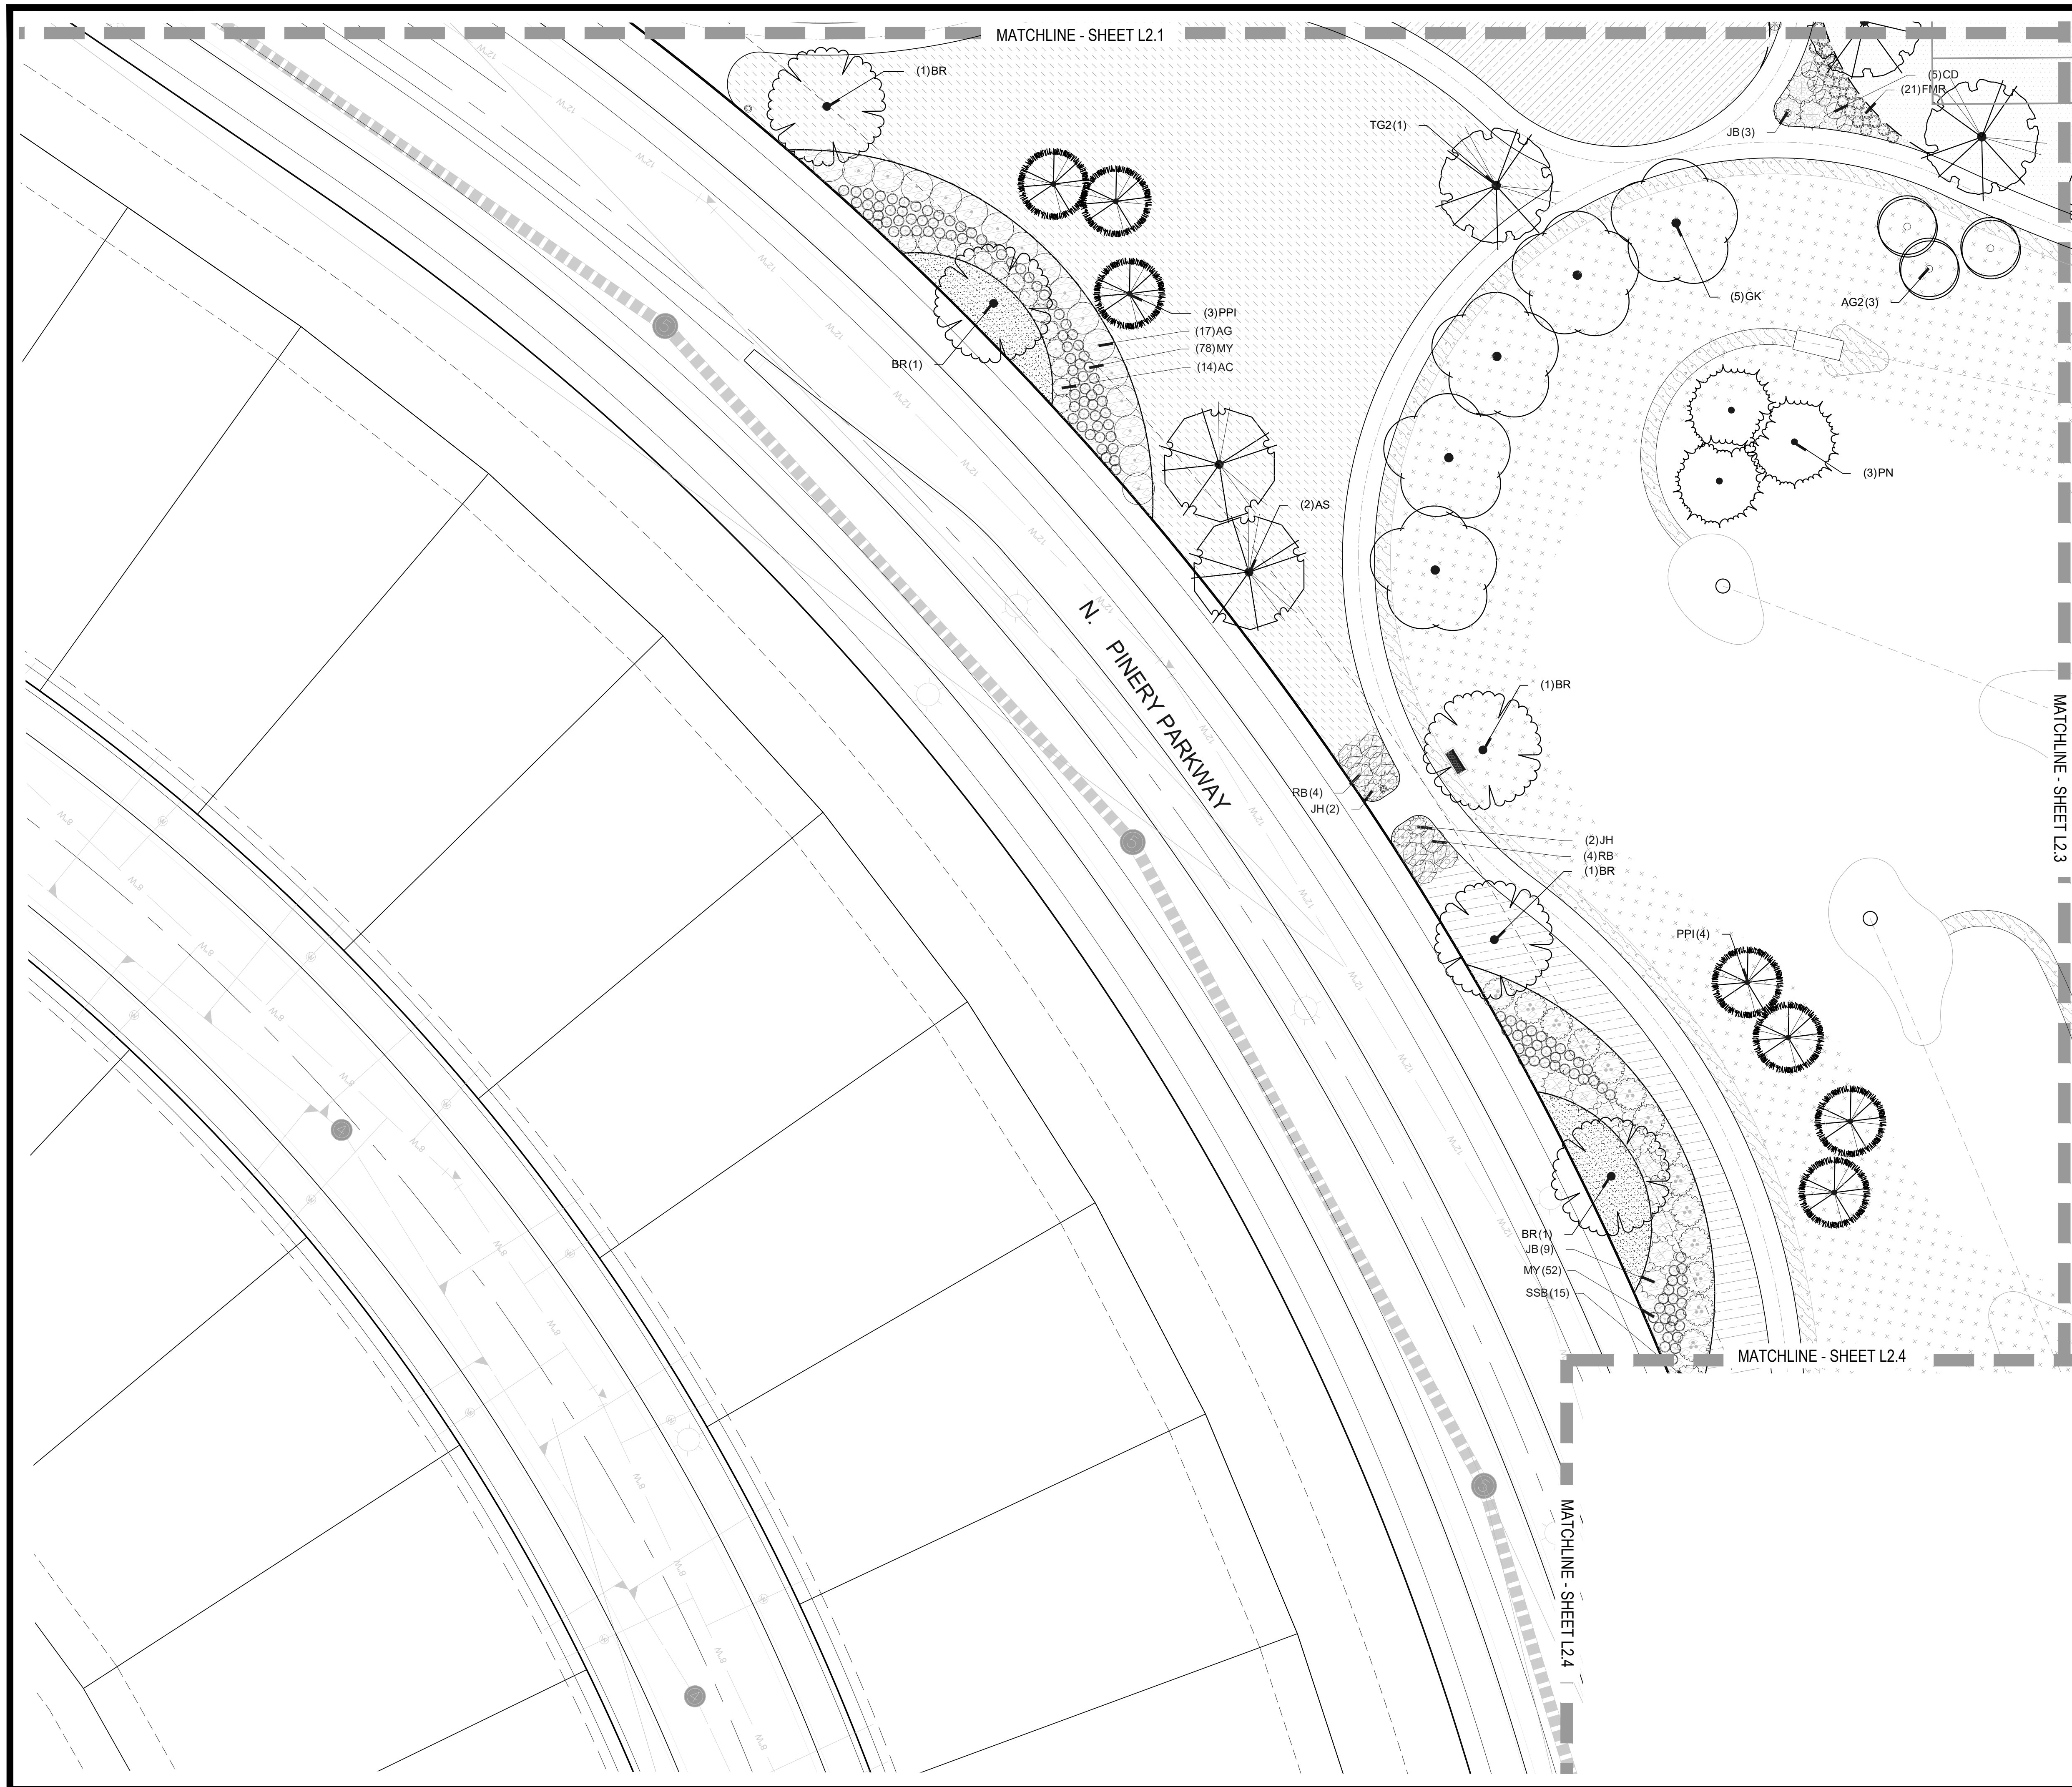
TRAILS AT CROWFOOT
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 PARKER, COLORADO
LANDSCAPE PLANS

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LANDSCAPE PLAN


Sheet Number
L2.1





PLANT SCHEDULE

COMMON NAME	COMMON NAME
DECIDUOUS TREES	COMMON NAME
AS	Schwedler Maple
BR	River Birch
GI	Imperial Honeylocust
GS	Shademaster Locust
GK	Kentucky Coffee Tree
OV	American Hornbeam
PO	American Sycamore
OM	Burr Oak
QM2	Chinkapin Oak
OR	Red Oak
TG2	Glennleven Littleleaf Linden
TG	Greenspire Littleleaf Linden
UP	American Elm
EVERGREEN TREES	COMMON NAME
PC	Colorado Spruce
VAN	Vanderwolf's Pyramid Pine
PSP	Limber Pine
PN	Austrian Black Pine
PPI	Ponderosa Pine
ORNAMENTAL TREES	COMMON NAME
AG2	Rocky Mountain Maple
WKH	Winter King Hawthorn
ORNAMENTAL GRASSES	COMMON NAME
CK	Feather Reed Grass
MY	Yaku Jima Dwarf Maiden Grass
PH	Blue Switch Grass
PB2	Little Bunny Fountain Grass
ANNUALS/PERENNIALS	COMMON NAME
CV	Threadleaf Coreopsis
EP	Purple Coneflower
BES	Black-eyed Susan
DECIDUOUS SHRUBS	COMMON NAME
SSB	Saskatoon Serviceberry
AG	Autumn Brilliance Serviceberry
CD	Blue Mist Shrub
RB	Rabbitbrush
CB	Red Twig Dogwood
CH	Rock Columbine
PS2	Rocky Mountain Penstemon
PA	Russian Sage
PJ	Jackman's Potentilla
RJU	Gro-Low Fragrant Sumac
RG	Golden Currant
FMR	Fire Meidiland Rose
RW	White Meidiland Rose
EVERGREEN SHRUBS	COMMON NAME
AC	Manzanita
AP	Panchito Manzanita
JB	Blue Chip Juniper
JH	Hughes Juniper
BUJ	Buffalo Juniper
PS	Mugo Pine
GROUND COVERS	COMMON NAME
[Pattern]	BLUEGRASS SOD RE: LANDSCAPE NOTES
[Pattern]	BUFFALO GRASS RE: LANDSCAPE NOTES
[Pattern]	CRUSHER FINES
[Pattern]	ENVIROTURF RE: LANDSCAPE NOTES
[Pattern]	FIBAR PLAYGROUND MULCH
[Pattern]	G&S SOLUTIONS-CLASSIC INFIELD MIX, GOLD COLOR: GOLD, WITHOUT STABILIZER
[Pattern]	ROCK MULCH GREY, 1-1/2" MOUNTAIN GRANITE 3" DEPTH, RE: LDSCP NOTES
[Pattern]	ROCK MULCH GRAY-1-1/2" MTN GRANITE 3" DEPTH, RE: LDSCP NOTES
[Pattern]	SEED MIX 1 TOWN OF PARKER - SEED MIX 1, RE: LANDSCAPE NOTES
[Pattern]	SEED MIX 2 TOWN OF PARKER - SEED MIX 2, RE: LANDSCAPE NOTES
[Pattern]	G&S SOLUTIONS CLASSIC WARNING TRACK MIX COLOR:GOLD, WITHOUT STABILIZER

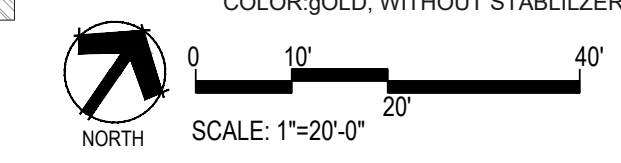

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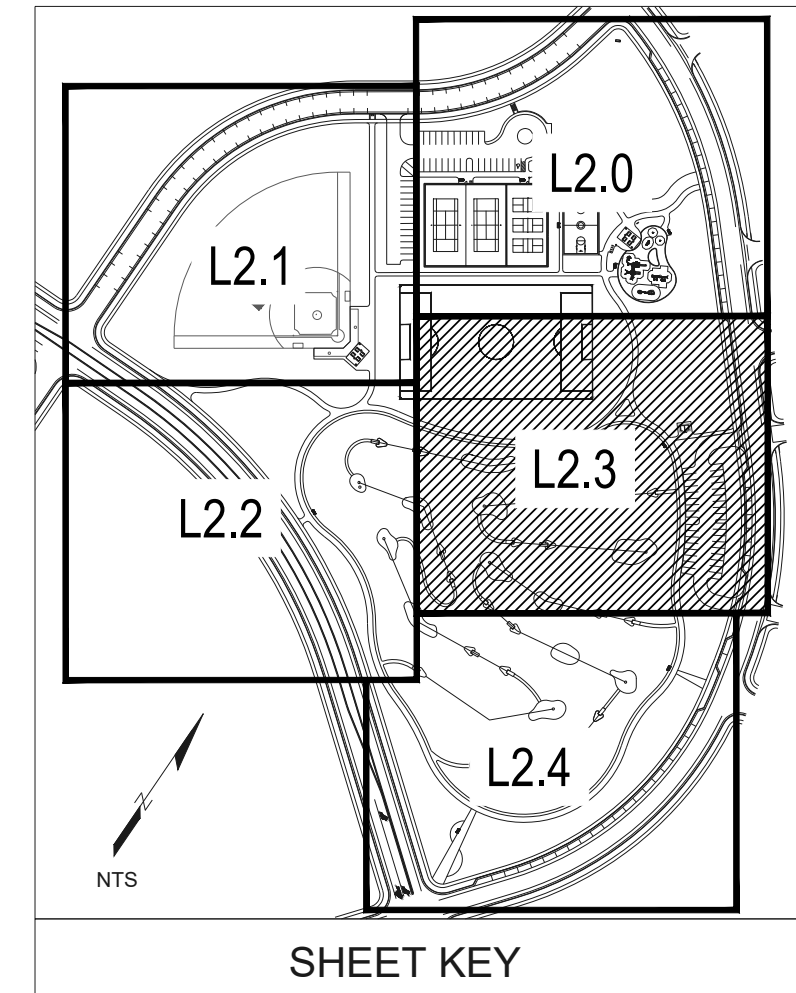
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TRAILS AT CROWFOOT
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 Sheet Number
L2.2



PLANT SCHEDULE

DECIDUOUS TREES	COMMON NAME
AS	Schwedler Maple
BR	River Birch
GI	Imperial Honeylocust
GS	Shademaster Locust
CK	Kentucky Coffee Tree
OV	American Hornbeam
PO	American Sycamore
QM	Burr Oak
QM2	Chickapin Oak
OR	Red Oak
TG2	Glenleven Littleleaf Linden
TP	Greenspire Littleleaf Linden
UP	American Elm

EVERGREEN TREES	COMMON NAME
PC	Colorado Spruce
VAN	Vanderwolf's Pyramid Pine
PSP	Limber Pine
PN	Austrian Black Pine
PPI	Ponderosa Pine

ORNAMENTAL TREES	COMMON NAME
AG2	Rocky Mountain Maple
WKH	"Winter King" Hawthorn


ORNAMENTAL GRASSES	COMMON NAME
CK	Feather Reed Grass
MY	Yaku Jima Dwarf Maiden Grass
PH	Blue Switch Grass
PB2	Little Bunny Fountain Grass

ANNUALS/PERENNIALS	COMMON NAME
CV	Threadleaf Coreopsis
EP	Purple Coneflower
BES	Black-eyed Susan

DECIDUOUS SHRUBS	COMMON NAME
SSB	Saskatoon Serviceberry
AG	"Autumn Brilliance" Serviceberry
CD	Blue Mist Shrub
RB	Rabbitbrush
CB	Red Twig Dogwood
CH	Rock Coloneaster
PS2	Rocky Mountain Penstemon
PA	Russian Sage
PJ	Jackman's Potentilla
RHU	Gro-Low Fragrant Sumac
RG	Golden Currant
FMR	Fire Meidiland Rose
RW	White Meidiland Rose

EVERGREEN SHRUBS	COMMON NAME
AC	Manzanita
AP	Panchito Manzanita
JB	Blue Chip Juniper
JH	Hughes Juniper
BUJ	Buffalo Juniper
PS	Mugo Pine

GROUND COVERS	COMMON NAME
[Pattern]	BLUEGRASS SOD RE: LANDSCAPE NOTES
[Pattern]	BUFFALO GRASS RE: LANDSCAPE NOTES
[Pattern]	CRUSHER FINES
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[Pattern]	SEED MIX 1 TOWN OF PARKER - SEED MIX 1, RE: LANDSCAPE NOTES
[Pattern]	SEED MIX 2 TOWN OF PARKER - SEED MIX 2, RE: LANDSCAPE NOTES
[Pattern]	G&S SOLUTIONS CLASSIC WARNING TRACK MIX COLOR:GOLD, WITHOUT STABILIZER

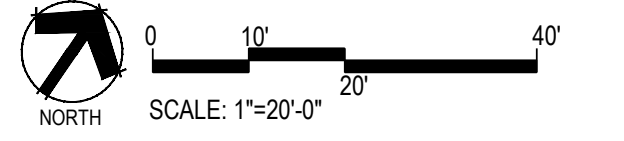

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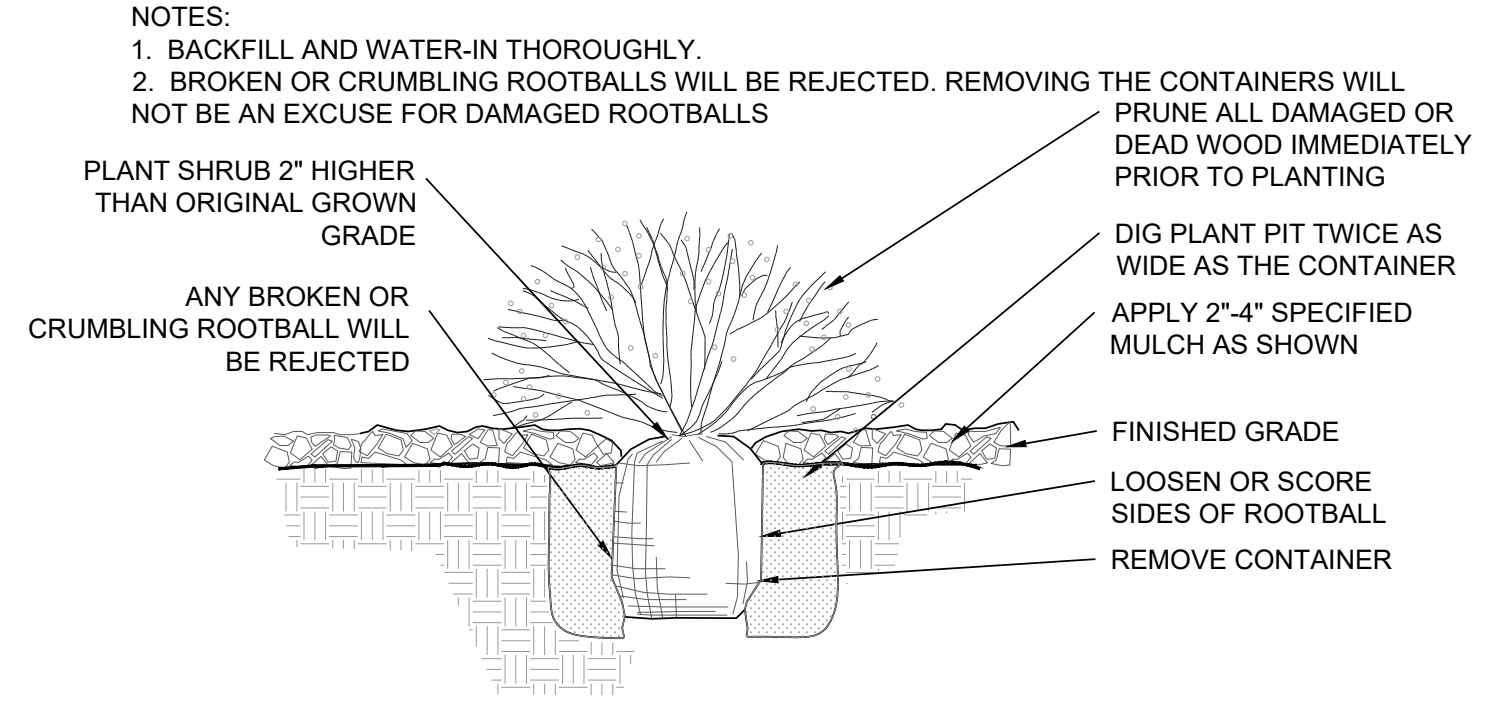
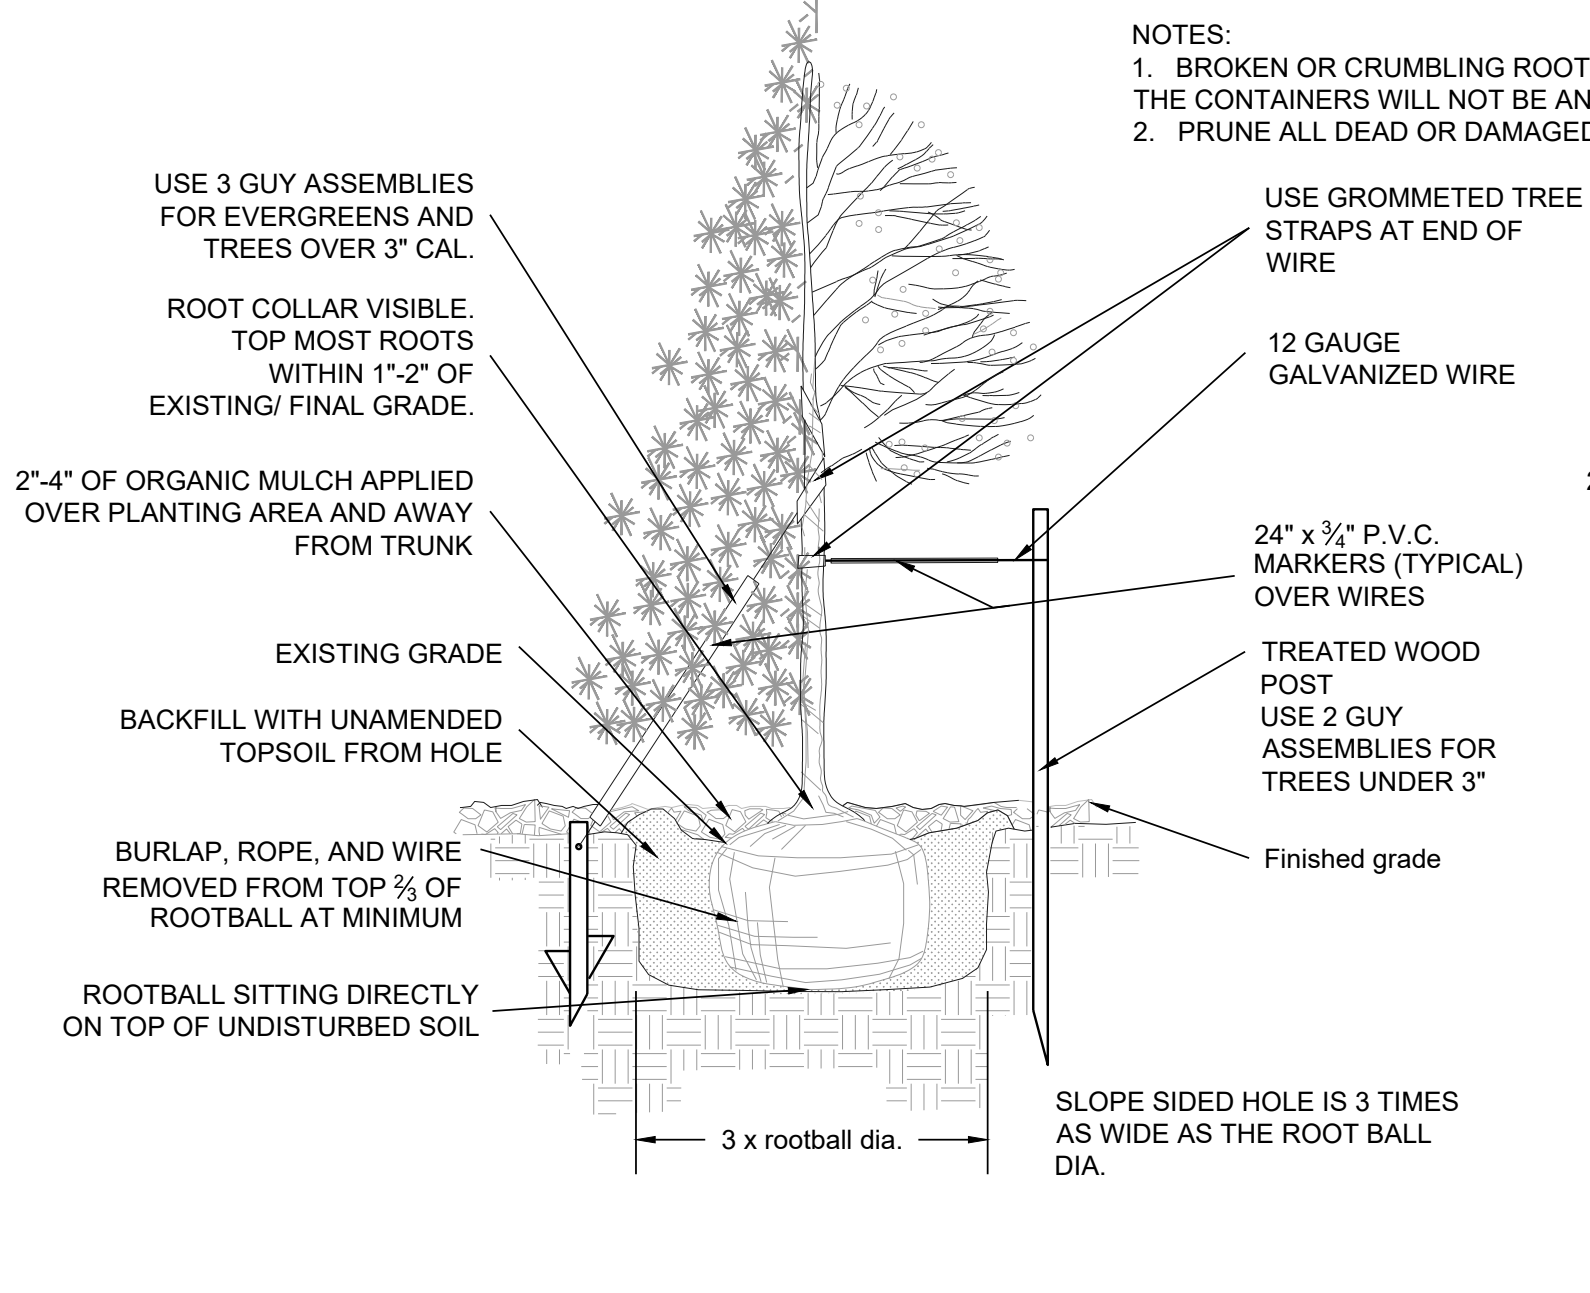
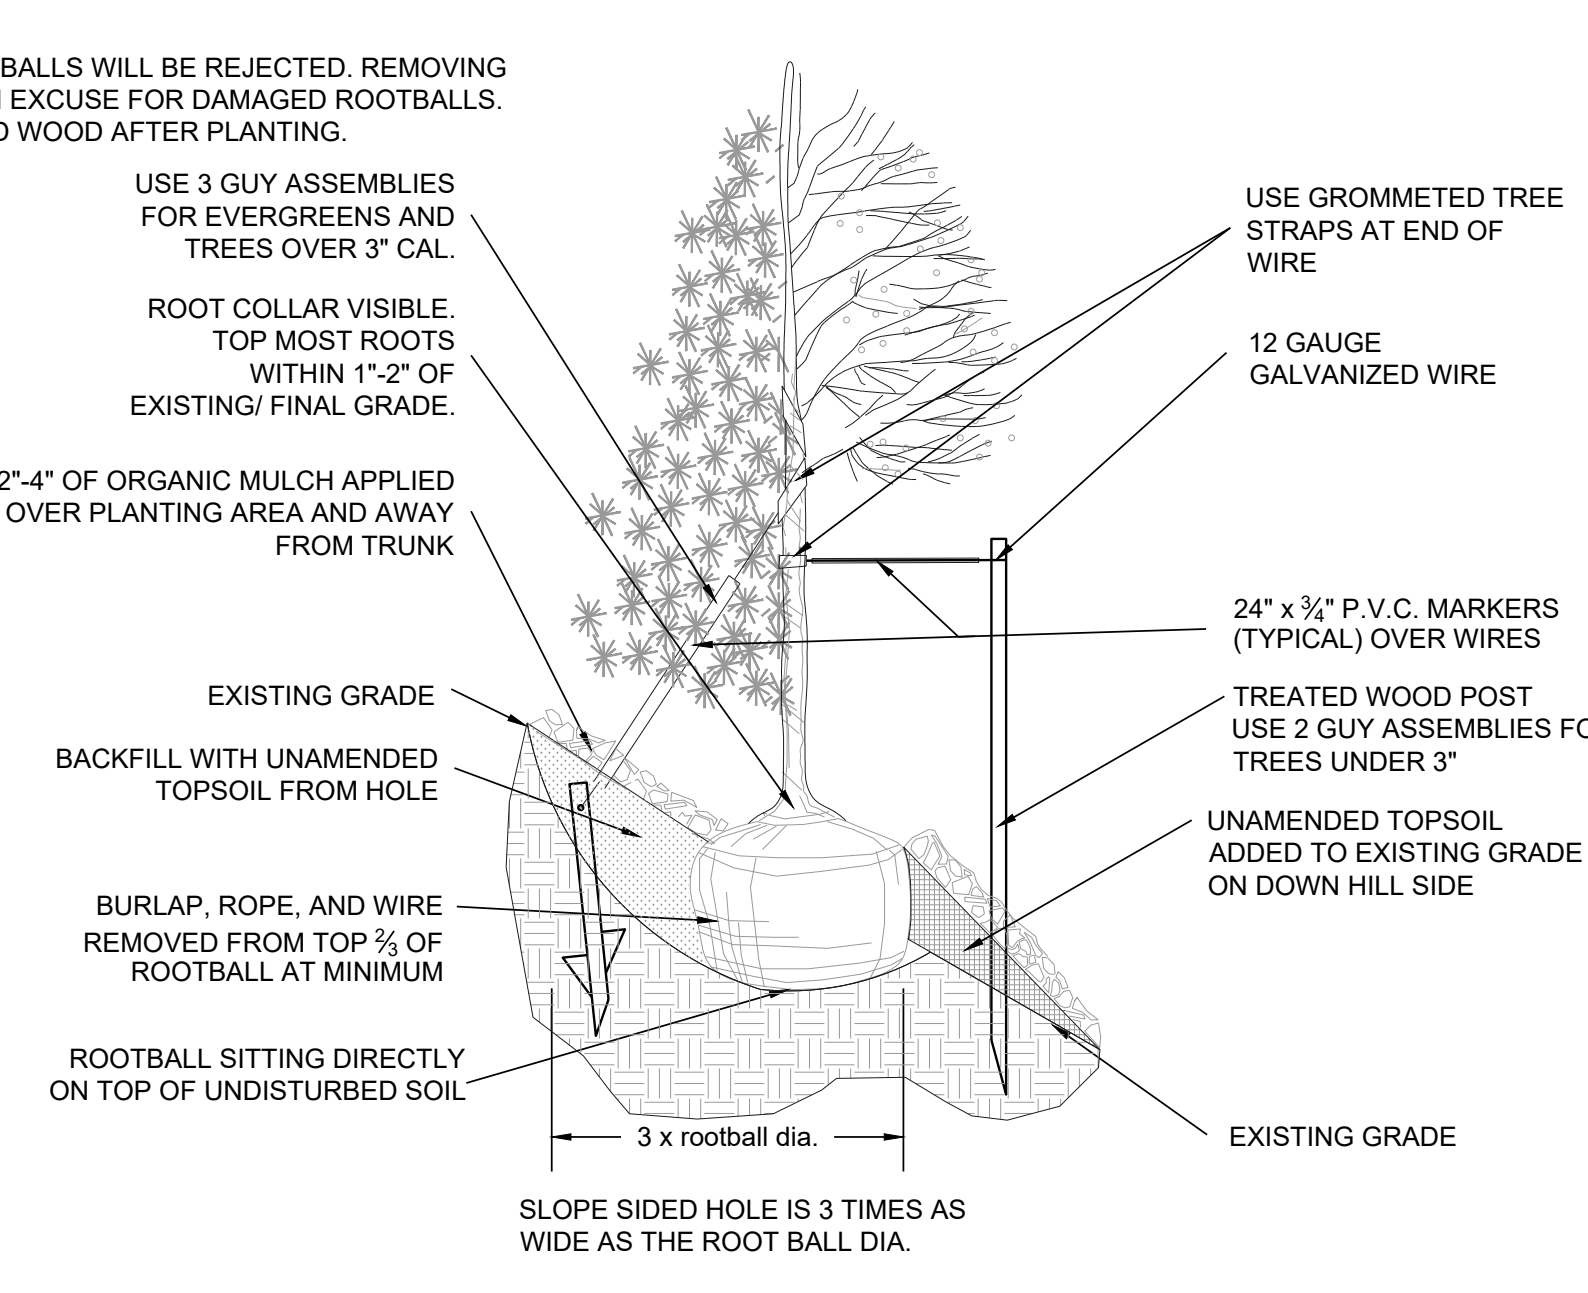
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LANDSCAPE PLAN

Sheet Number
L2.3




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- NOTES:
1. ALL WORK TO BE DONE AT TIME OF PLANTING
 2. PEEL BACK ONLY TOP OF BURLAP REQUIRED TO PERFORM WORK. REPLACE BURLAP BEFORE MOVING TREE INTO PLANTING PIT. DO NOT REMOVE WIRE BASKET UNTIL INSIDE PLANTING PIT.
 3. MEASURE NEW HEIGHT OF ROOTBALL AND DIG PLANTING PIT SO FINAL TOP ROOTBALL GRADE IS 3" ABOVE FINAL GRADE SURROUNDING BALL.
 4. EXCAVATE PLANTING HOLES WITH SLOPING SIDES. MAKE EXCAVATIONS AT LEAST THREE TIMES AS WIDE AS THE ROOT BALL DIAMETER AND NO DEEPER THAN THE DISTANCE FROM THE TOP MOST ROOTS IN THE ROOT BALL TO THE BOTTOM OF THE ROOT BALL TO ALLOW FOR SETTLING. DO NOT DISTURB SOIL AT BOTTOM OF PLANTING HOLES, BUT DO SCORE THE SIDES OF THE PLANTING HOLE. THE PLANTING AREA SHALL BE LOOSENEED AND AERATED AT LEAST THREE TIMES THE DIAMETER OF THE ROOT BALL. BACKFILL SHALL CONSIST OF EXISTING SITE TOPSOIL - NO AMENDMENTS SHALL BE USED UNLESS OTHERWISE SPECIFIED.
 5. TREES SHALL BE PLANTED WITH THE ROOT COLLAR/FLARE VISIBLE ABOVE GRADE AND TWO OR MORE STRUCTURAL ROOTS LOCATED WITHIN THE TOP 1" TO 2" OF THE ROOT BALL/FINISHED GRADE MEASURED 3" TO 4" FROM TRUNK. THIS INCLUDES TREES THAT ARE SET ON SLOPES (SEE SLOPE PLANTING DETAIL). TREES THAT DO NOT HAVE A VISIBLE ROOT COLLAR SHALL BE REJECTED. DO NOT COVER THE ROOT BALL WITH SOIL.
 6. WHEN ROOT BALL WILL REMAIN INTACT, CUT OFF BOTTOM 1/4 OF WIRE BASKET BEFORE PLACING TREE IN HOLE, CUT OFF REMAINDER OF BASKET AFTER TREE IS SET IN HOLE, REMOVE BASKET COMPLETELY. AT A MINIMUM, THE TOP 2/3 OF THE BURLAP AND BASKET SHALL BE REMOVED FROM THE ROOT BALL ON ALL TREES. REMOVE ALL NYLON TIES, TWINE, ROPE AND BURLAP. REMOVE UNNECESSARY PACKING MATERIAL FORM SOIL INTO A 3" TO 5" TALL WATERING RING (SAUCER) AROUND PLANTING AREA. THIS IS NOT NECESSARY IN IRRIGATED TURF AREAS. APPLY 2" TO 4" DEPTH OF SPECIFIED MULCH OVER PLANTING AREA AND INSIDE SAUCERS, AWAY FROM TRUNK. STAKING AND GUYING OF TREES IS OPTIONAL IN MOST PLANTING SITUATIONS. IN AREAS OF EXTREME WINDS OR ON STEEP SLOPES, STAKING MAY BE REQUIRED TO STABILIZE TREES. STAKING AND GUYING MUST BE REMOVED WITHIN 1 YEAR OF PLANTING DATE.
 7. TREE WRAP IS NOT TO BE USED ON ANY NEW PLANTINGS, EXCEPT IN LATE FALL PLANTING SITUATIONS AND ONLY THEN AFTER CONSULTATION WITH THE TOWN ARBORIST.
 8. RESETTING OF IMPROPERLY PLANTED TREES WILL ONLY BE ALLOWED IF IT IS DETERMINED THAT DOING SO WILL IN NO WAY COMPROMISE THE ROOT BALL, AND SHALL ONLY BE DONE WITH APPROVAL OF THE TOWN ARBORIST.




1 SHRUB PLANTING NOT TO SCALE


2 TREE PLANTING NOT TO SCALE

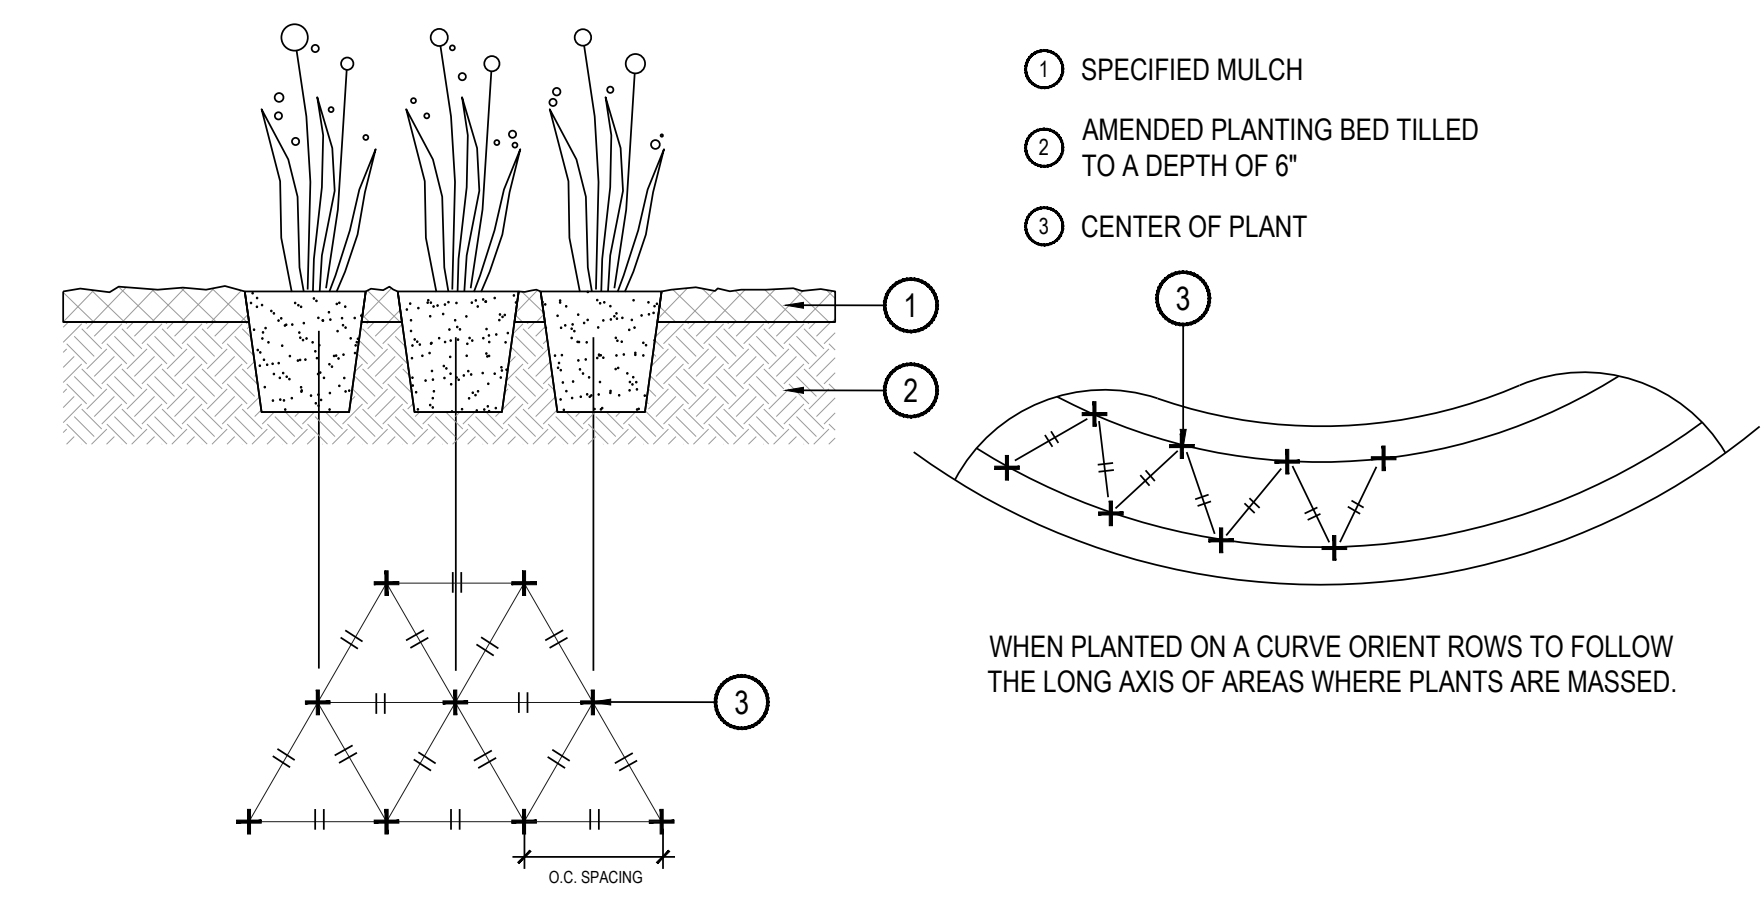


3 PERENNIAL OR GRASS PLANTING NOT TO SCALE

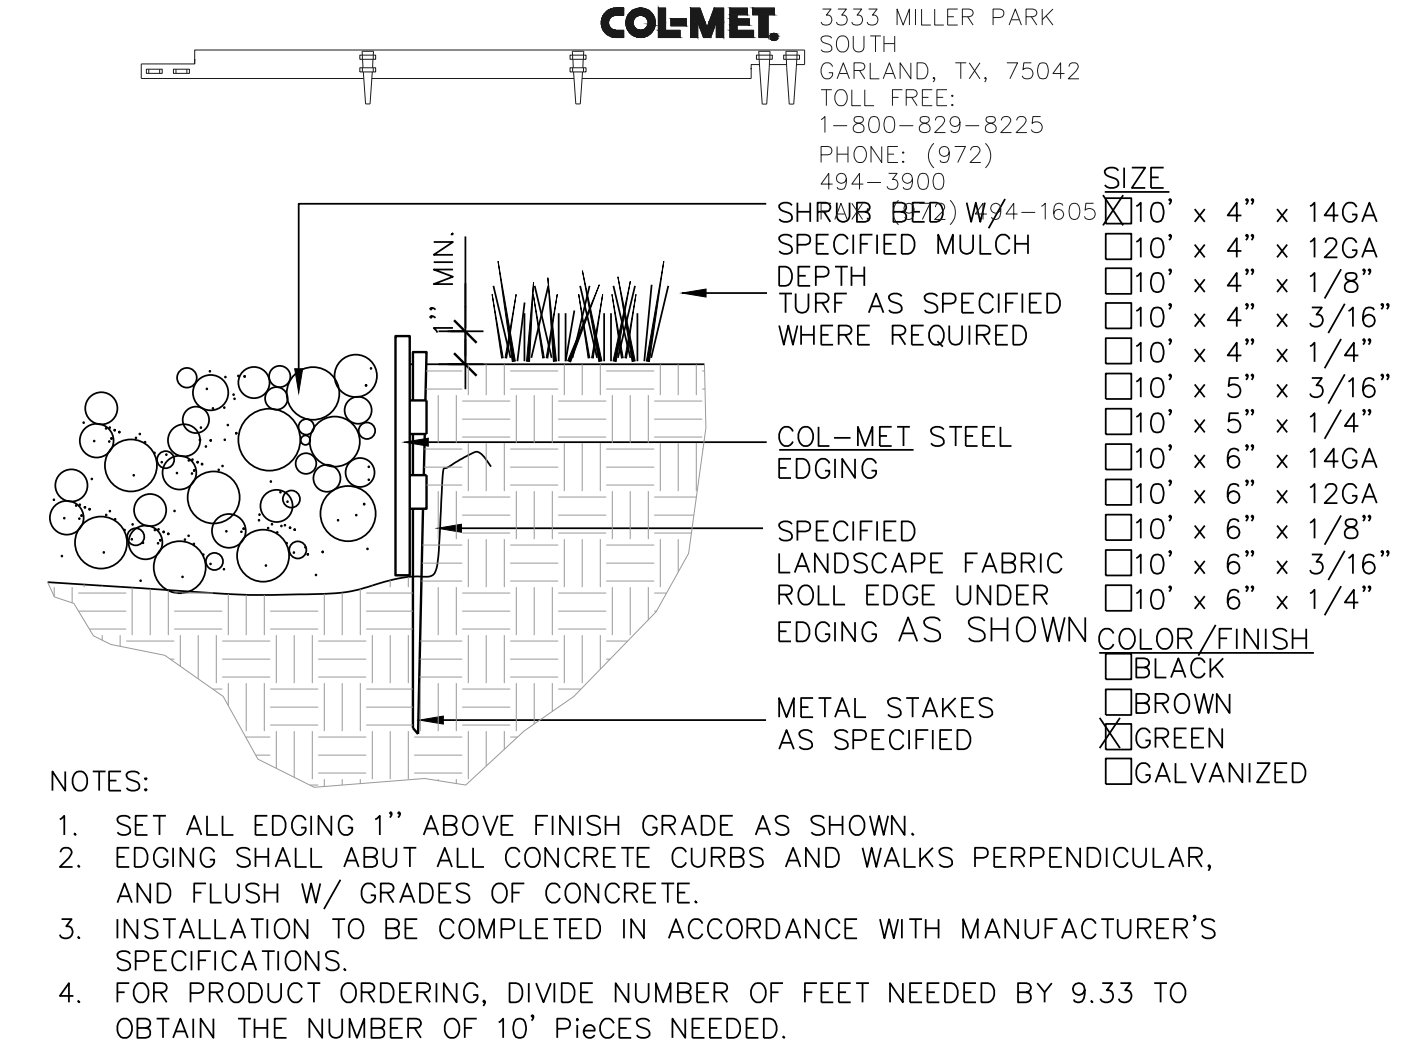

4 STEEL EDGER NOT TO SCALE

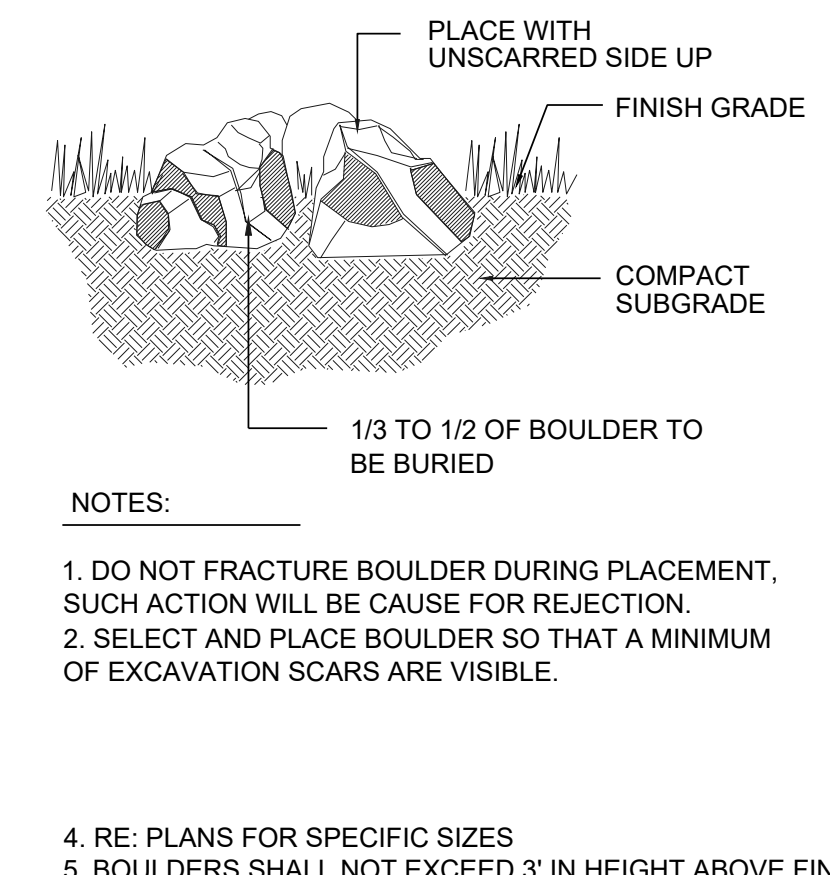

5 SPECIMEN LANDSCAPE BOULDER NOT TO SCALE

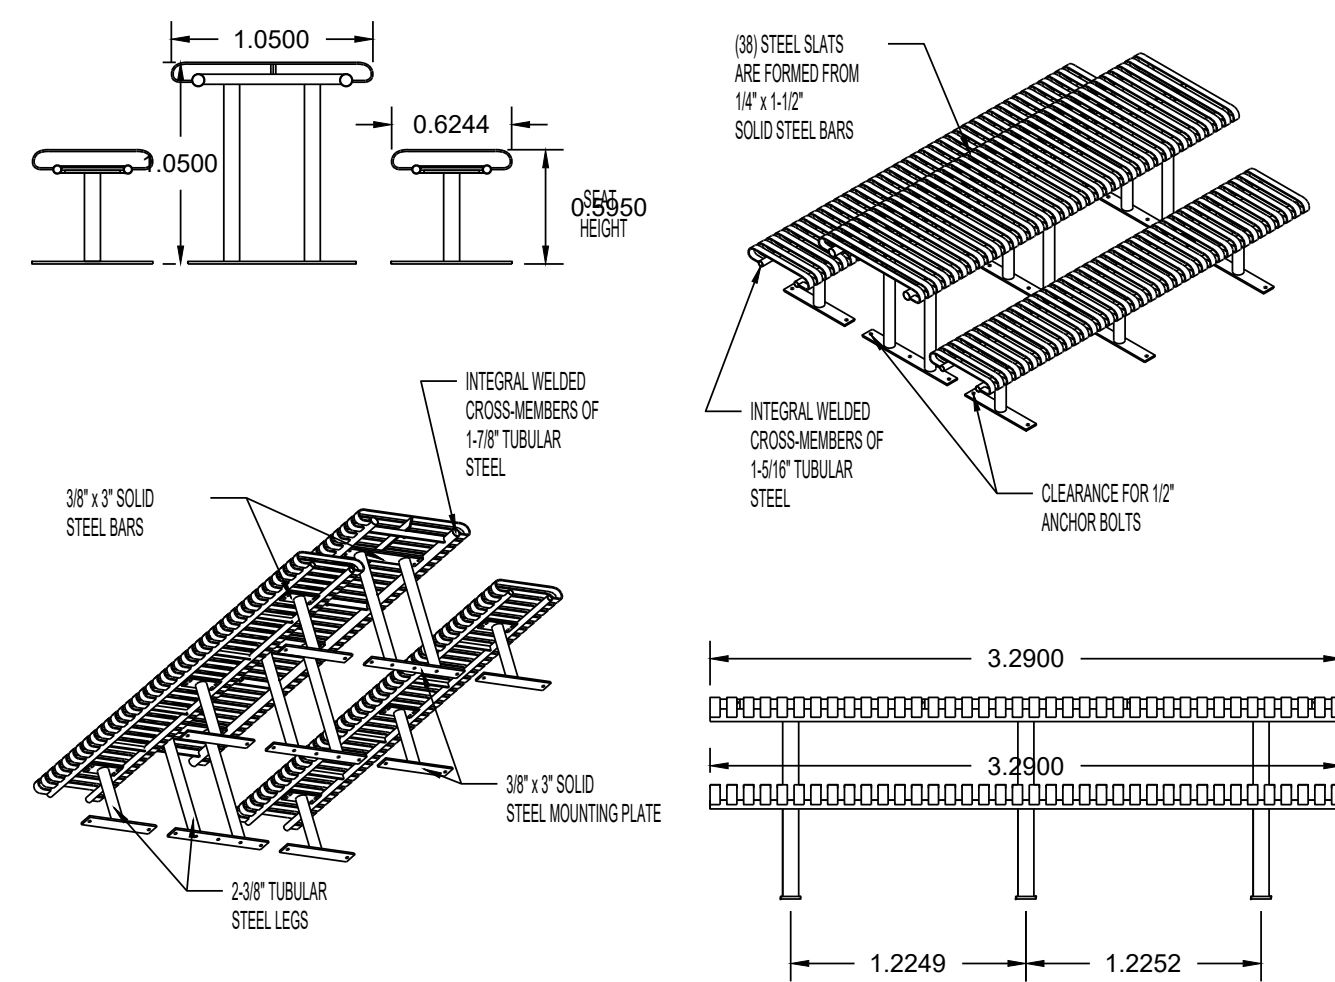

AVAILABLE OPTIONS:
POWDER COATING
10 STANDARD COLORS, CUSTOM COLORS (INCLUDING THE RAL RANGE)
MOUNTING
STANDARD IN-GROUND AND SURFACE

- NOTES:
1. DRAWINGS NOT TO SCALE. DO NOT SCALE DRAWINGS.
2. ALL FABRICATED METAL COMPONENTS ARE STEEL SHOTBLASTED, ETCHED, PHOSPHATIZED, PREHEATED, AND ELECTROSTATICALLY POWDER-COATED WITH T.G.I.C. POLYESTER POWDER COATINGS. PRODUCTS ARE FULLY CLEANED AND PRETREATED, PREHEATED AND COATED WHILE HOT TO FILL CREVICES AND BUILD COATING FILM. COATED PARTS ARE THEN FULLY CURED TO COATING MANUFACTURER'S SPECIFICATIONS.
3. IT IS NOT RECOMMENDED TO LOCATE ANCHOR BOLTS UNTIL TABLE AND BENCHES ARE IN PLACE. THIS VICTOR STANLEY, INC. PRODUCT MUST BE PERMANENTLY AFFIXED TO THE GROUND. CONSULT YOUR LOCAL CODES FOR REGULATIONS.
4. ANCHOR BOLTS NOT PROVIDED BY VICTOR STANLEY, INC.
5. FOR HIGH SALT ABUSIVE CLIMATES, HOT-DIP GALVANIZING BEFORE POWDER COATING IS AVAILABLE. SEE WRITTEN SPECIFICATIONS FOR DETAILS.
6. ALL SPECIFICATIONS ARE SUBJECT TO CHANGE. CONTACT MANUFACTURER FOR DETAILS.
7. THIS PRODUCT IS SHIPPED PARTIALLY UNASSEMBLED.




FRST-6
STEEL SITES SERIES
STANDARD ALL STEEL TABLE
SHOWN: STANDARD 8-FOOT LENGTH STANDARD SURFACE MOUNT
(7) FR84 STANDARD 8-FOOT LENGTH BENCHES STANDARD SURFACE MOUNT

MODEL: FRST-8 (8' LENGTH) COLOR: BLACK
MANUFACTURER: VICTOR STANLEY, INC.
AS SUPPLIED BY DOWNS & ASSOCIATES
CONTACT: MELANIE POLANCO
P: 303-744-0399

1 PICNIC TABLE

NOT TO SCALE

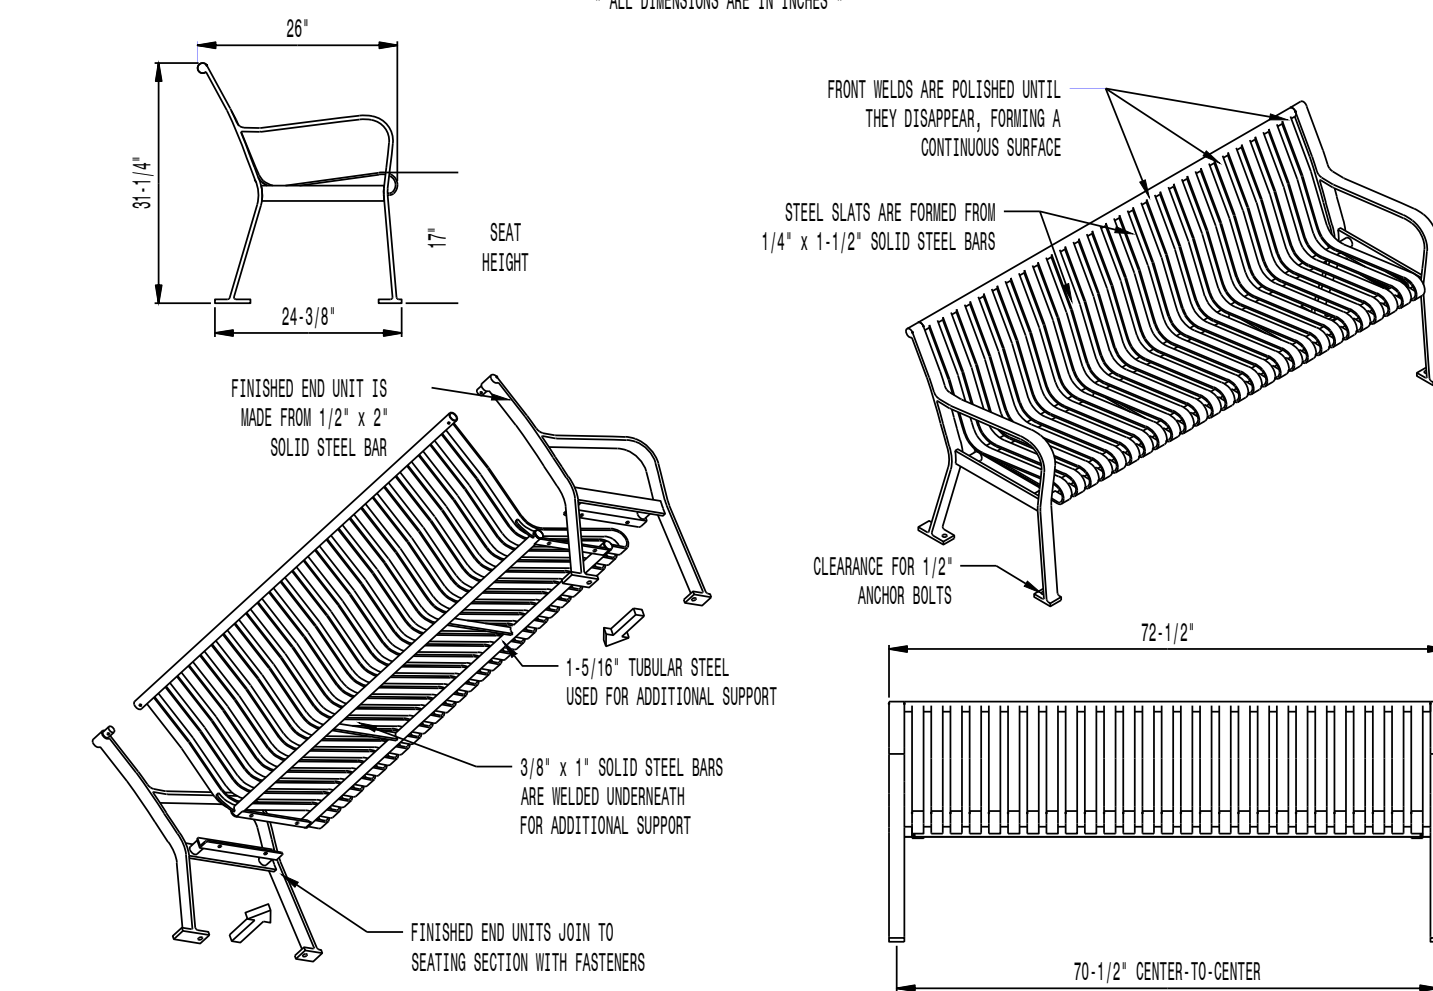

AVAILABLE OPTIONS:
POWDER COATING
10 STANDARD COLORS, 2 OPTIONAL METALLIC COLORS,
CUSTOM COLORS (INCLUDING THE RAL RANGE)
INTERMEDIATE & CENTER ARMRESTS
4\", 6\", & 8\"/>

LENGTHS
STANDARD 4'
STANDARD 6' (AS SHOWN)
STANDARD 8'




RB-28
STEEL SITES™ RB
ALL STEEL CONToured BENCH
SHOWN: STANDARD 6-FOOT LENGTH

MODEL: RB-28, COLOR: BLACK
MANUFACTURER: VICTOR STANLEY, INC.
AS SUPPLIED BY DOWNS & ASSOCIATES
CONTACT: MELANIE POLANCO
P: 303-744-0399

2 BENCH W/ BACK

NOT TO SCALE

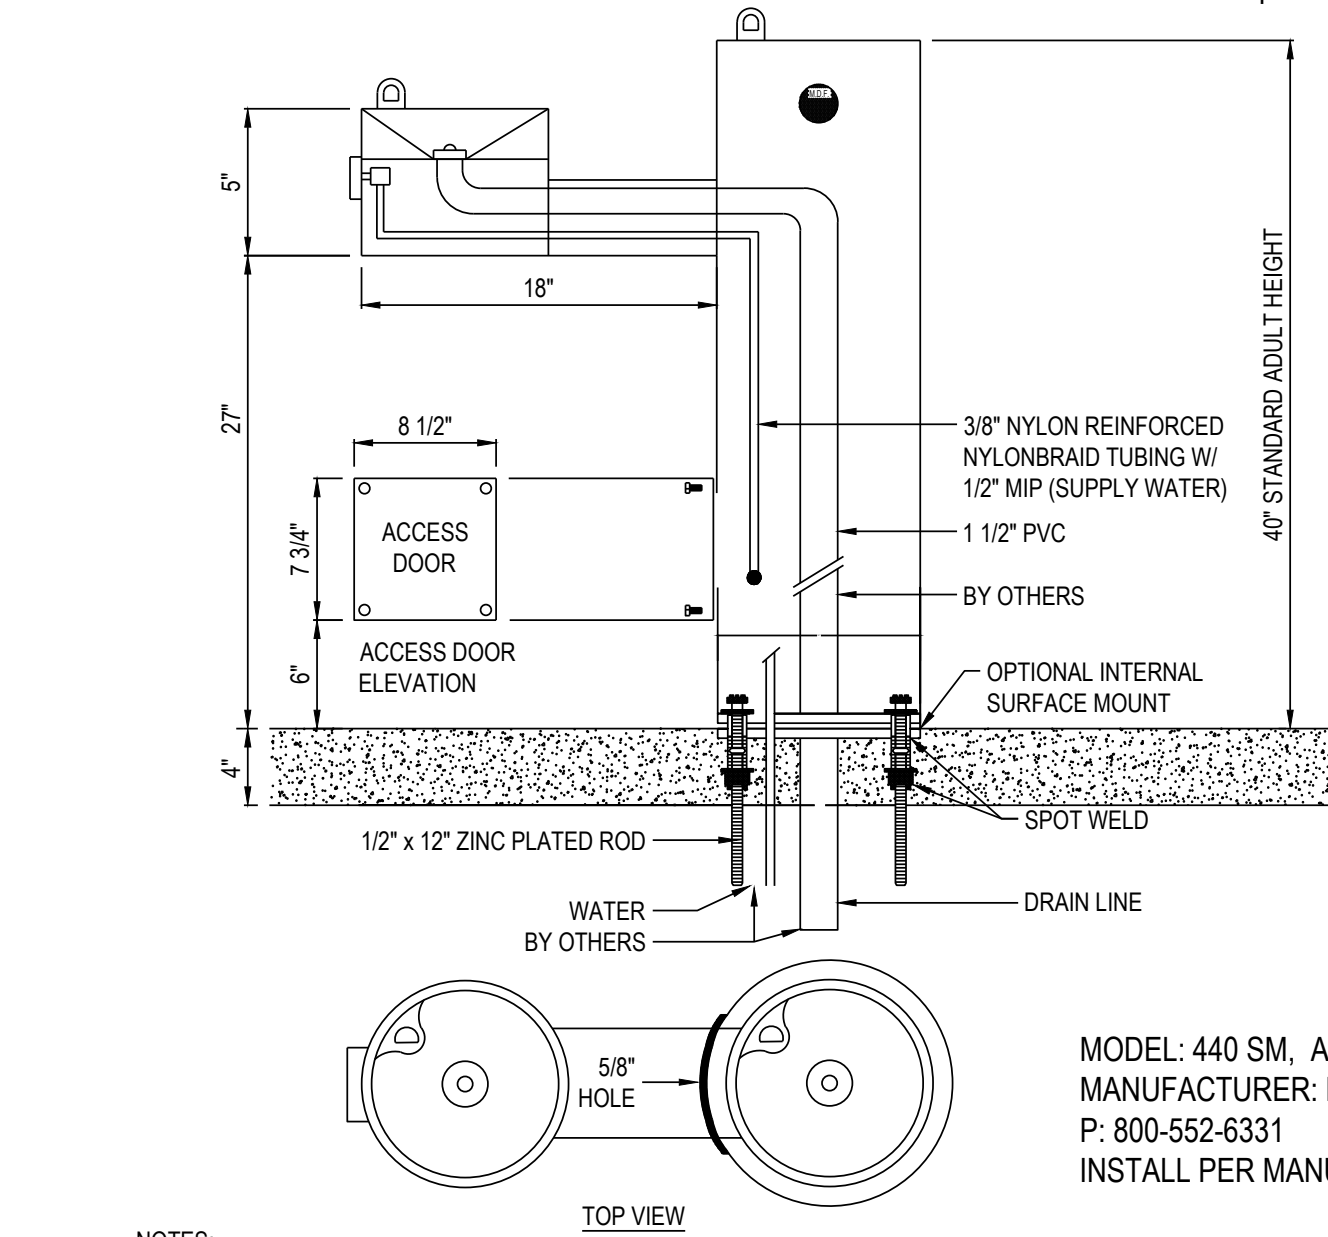

- NOTES:
1. MEETS ADA REGULATIONS.
2. OPTIONAL STAINLESS STEEL SURFACE CARRIER RECOMMENDED.
3. INSTALLATION TO BE COMPLETED IN ACCORDANCE WITH MANUFACTURER'S SPECIFICATIONS.
4. DO NOT SCALE DRAWING.
5. THIS DRAWING IS INTENDED FOR USE BY ARCHITECTS, ENGINEERS, CONTRACTORS, CONSULTANTS AND DESIGN PROFESSIONALS FOR PLANNING PURPOSES ONLY. THIS DRAWING MAY NOT BE USED FOR CONSTRUCTION.
6. ALL INFORMATION CONTAINED HEREIN WAS CURRENT AT THE TIME OF DEVELOPMENT BUT MUST BE REVIEWED AND APPROVED BY THE PRODUCT MANUFACTURER TO BE CONSIDERED ACCURATE.
7. CONTRACTOR'S NOTE: FOR PRODUCT AND COMPANY INFORMATION VISIT WWW.CADDDETAILS.COM/INFO AND ENTER REFERENCE NUMBER 3354-1.5.




MODEL 440 SM
SHOWN W/ OPTIONAL SS SURFACE CARRIER



3 DRINKING FOUNTAIN


NOT TO SCALE

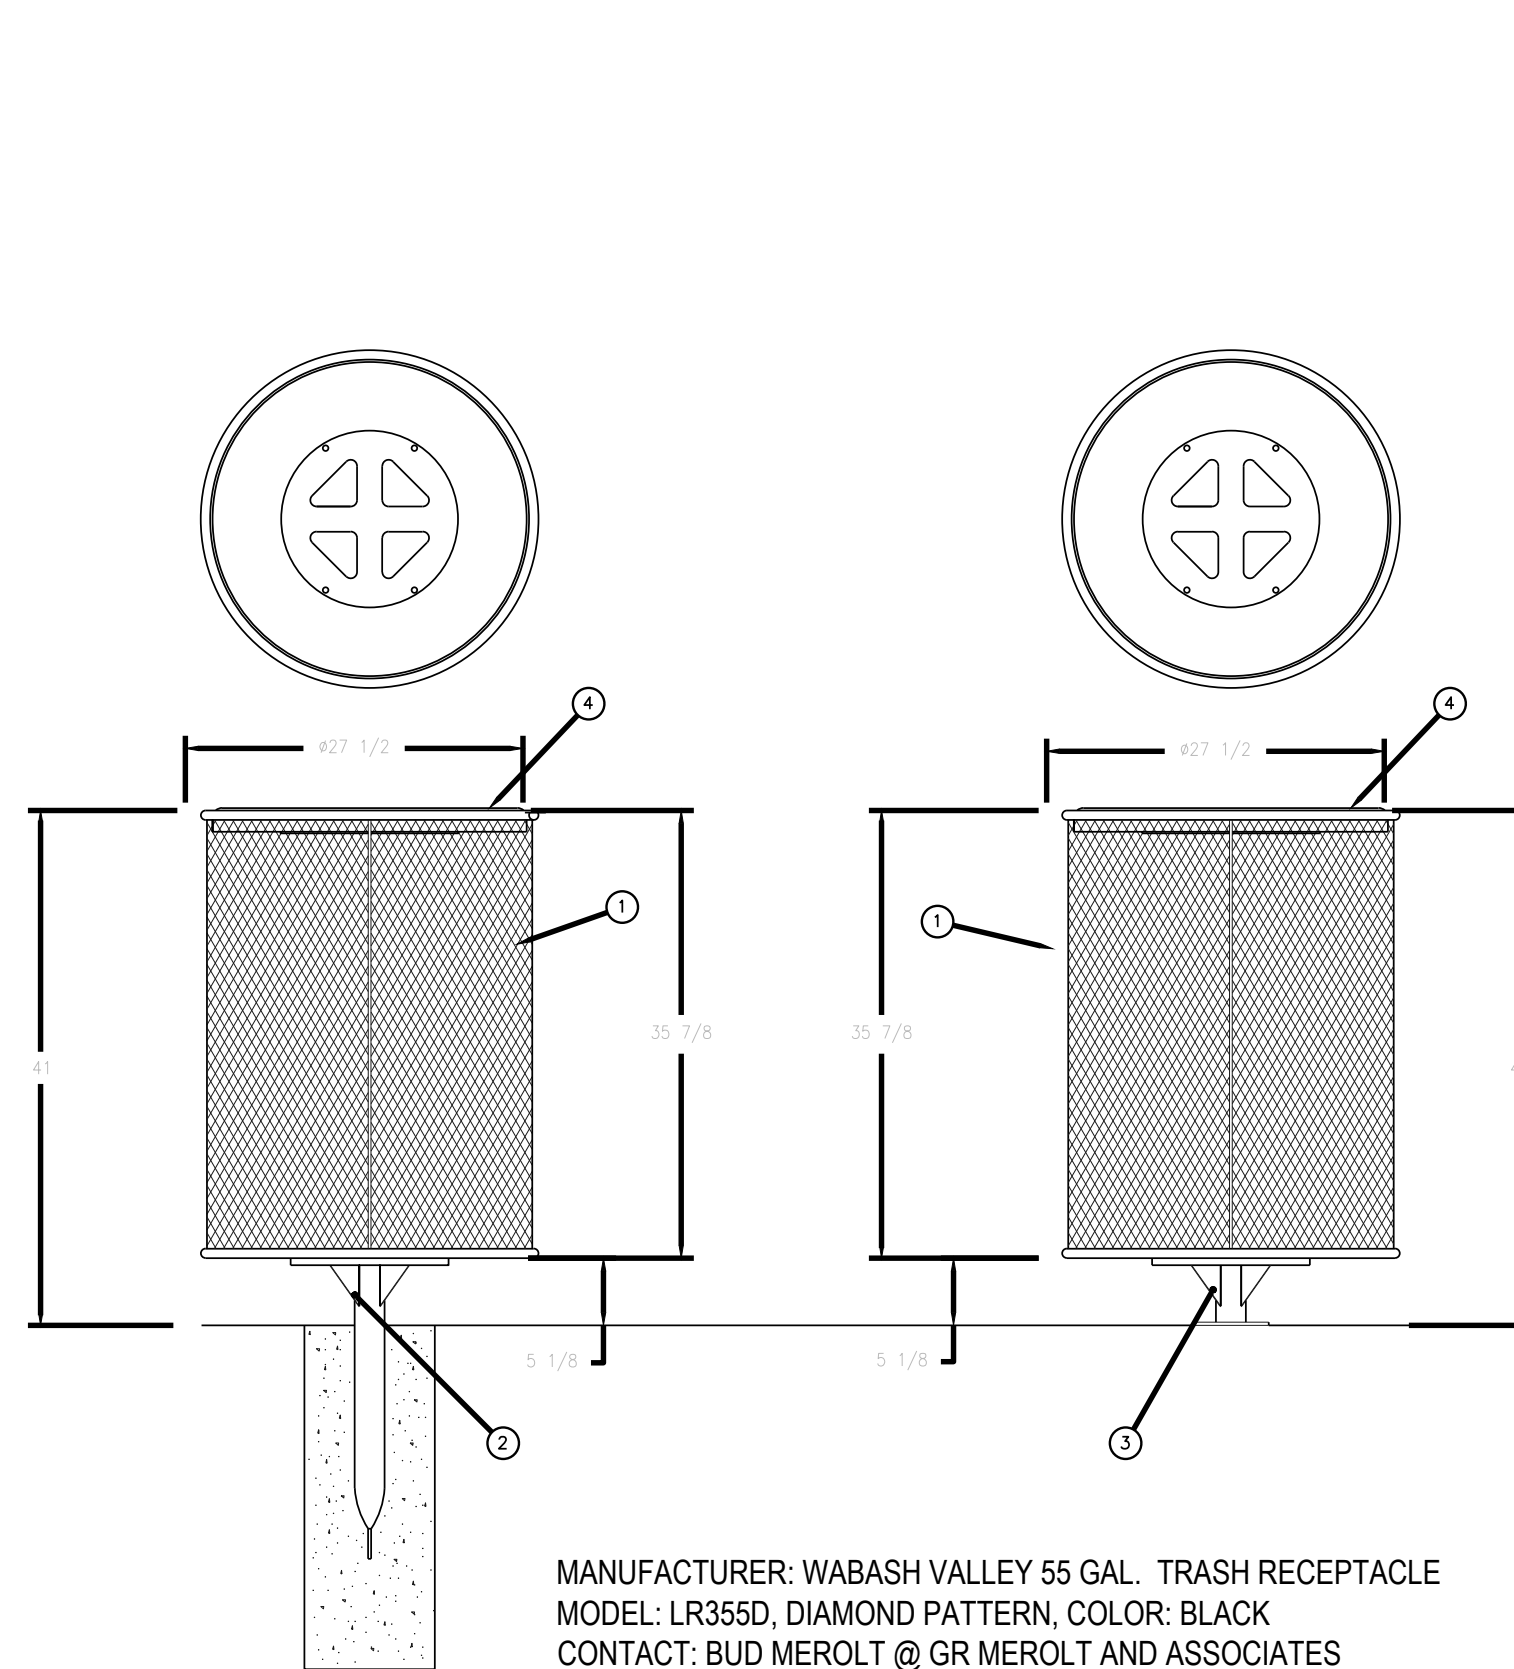

MANUFACTURER: WABASH VALLEY 55 GAL. TRASH RECEPTACLE
MODEL: LR355D, DIAMOND PATTERN, COLOR: BLACK
CONTACT: BUD MEROLT @ GR MEROLT AND ASSOCIATES
PH: (303) 762-1090
INSTALL PER MANUFACTURERS RECOMMENDATION

4 TRASH RECEPTACLE

NOT TO SCALE

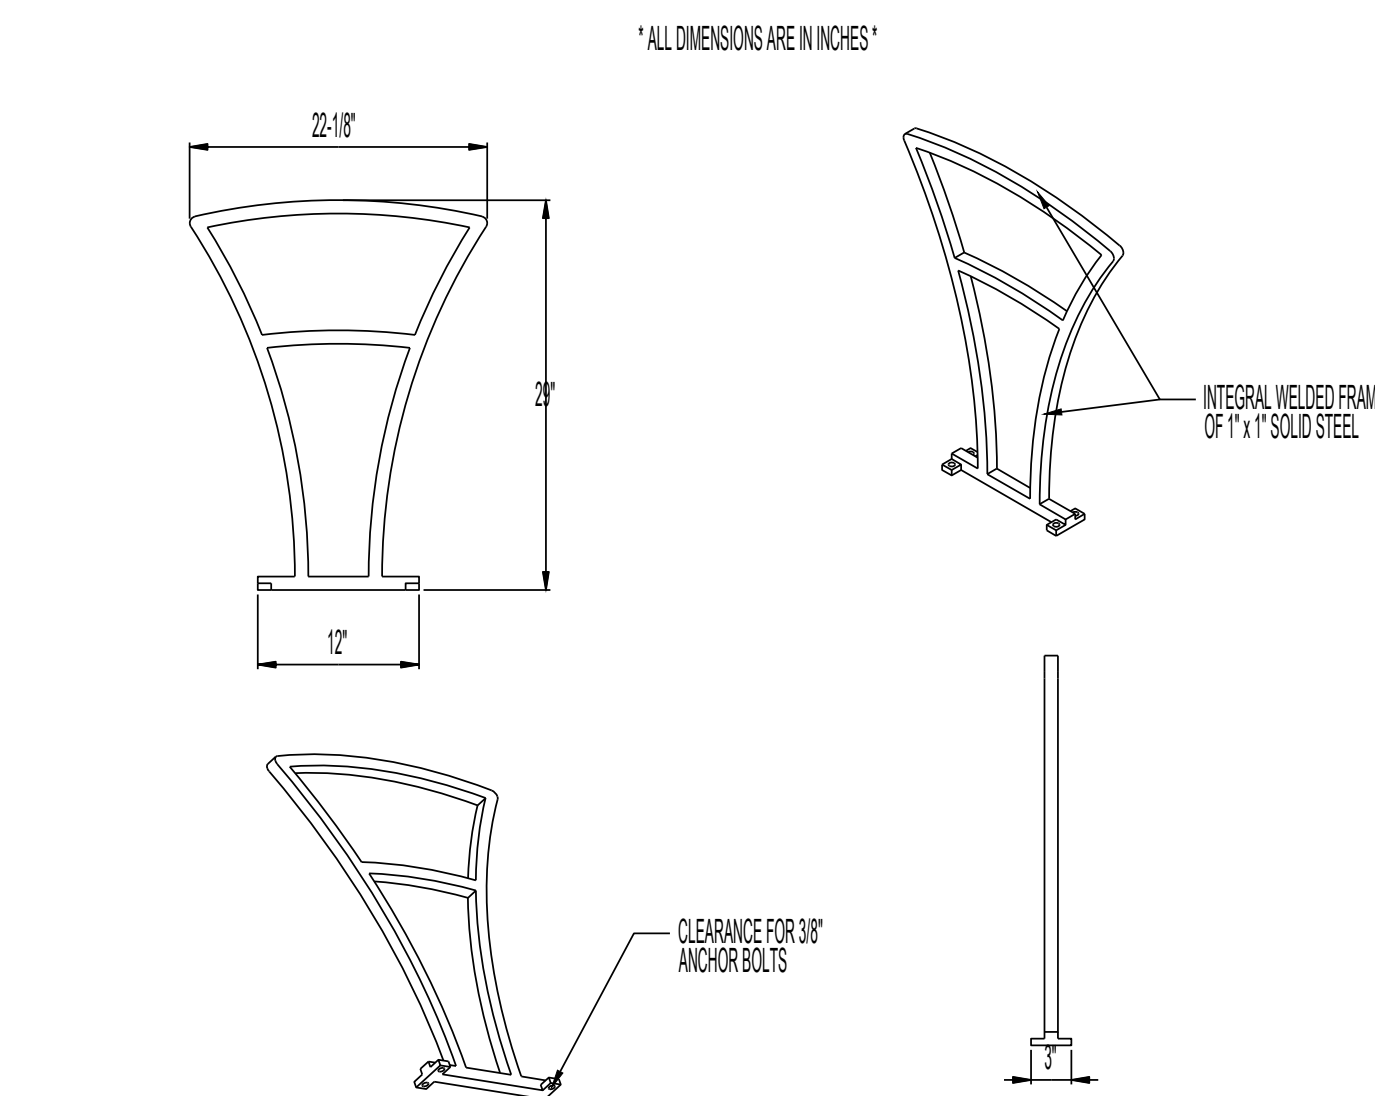


AVAILABLE OPTIONS:
POWDER COATING
10 STANDARD COLORS, 2 OPTIONAL METALLIC COLORS,
CUSTOM COLORS (INCLUDING THE RAL RANGE)

- NOTES:
1. DRAWINGS NOT TO SCALE. DO NOT SCALE DRAWINGS.
2. ALL FABRICATED METAL COMPONENTS ARE STEEL SHOTBLASTED, ETCHED, PHOSPHATIZED, PREHEATED, AND ELECTROSTATICALLY POWDER-COATED WITH T.G.I.C. POLYESTER POWDER COATINGS. PRODUCTS ARE FULLY CLEANED AND PRETREATED, PREHEATED AND COATED WHILE HOT TO FILL CREVICES AND BUILD COATING FILM. COATED PARTS ARE THEN FULLY CURED TO COATING MANUFACTURER'S SPECIFICATIONS. THE THICKNESS OF THE RESULTING FINISH AVERAGES 8-10 MILS (200-250 MICRONS).
3. IT IS NOT RECOMMENDED TO LOCATE ANCHOR BOLTS UNTIL BIKE RACK IS IN PLACE. THIS VICTOR STANLEY, INC. PRODUCT MUST BE PERMANENTLY AFFIXED TO THE GROUND. CONSULT YOUR LOCAL CODES FOR REGULATIONS.
4. ANCHOR BOLTS NOT PROVIDED BY VICTOR STANLEY, INC.
5. FOR HIGH SALT ABUSIVE CLIMATES, HOT-DIP GALVANIZING BEFORE POWDER COATING IS AVAILABLE. HOT-DIP GALVANIZING IS PERFORMED FOR VICTOR STANLEY, INC. BY AN EXPERIENCED QUALIFIED FIRM TO WHICH PRODUCTS ARE SHIPPED FOR GALVANIZING. HOT-DIP GALVANIZING INCLUDES AN AGGRESSIVE PRE-TREATMENT AND IMMERSION IN A TANK OF CHARGED LIQUID ZINC AT OR AROUND 860°F (460°C). THE RESULTING SURFACE IS RESISTANT TO RUST BUT HAS SOME UNEVENNESS RESULTING FROM THE BONDING OF THE ZINC TO THE STEEL SURFACE. AS A RESULT, THE POWDER-COATING SURFACE FINISH OVER THAT GALVANIZED SURFACE MAY EXHIBIT BUMPS, UNEVENNESS, AND MAY NOT BE AS SMOOTH AS THE STANDARD FINISH. THIS UNEVEN AND INCONSISTENT FINISH IS NORMAL FOR GALVANIZING. CONTACT MANUFACTURER FOR DETAILS.
6. ALL SPECIFICATIONS ARE SUBJECT TO CHANGE. CONTACT MANUFACTURER FOR DETAILS.
7. THIS PRODUCT IS SHIPPED FULLY ASSEMBLED.

5 BIKE RACK

NOT TO SCALE

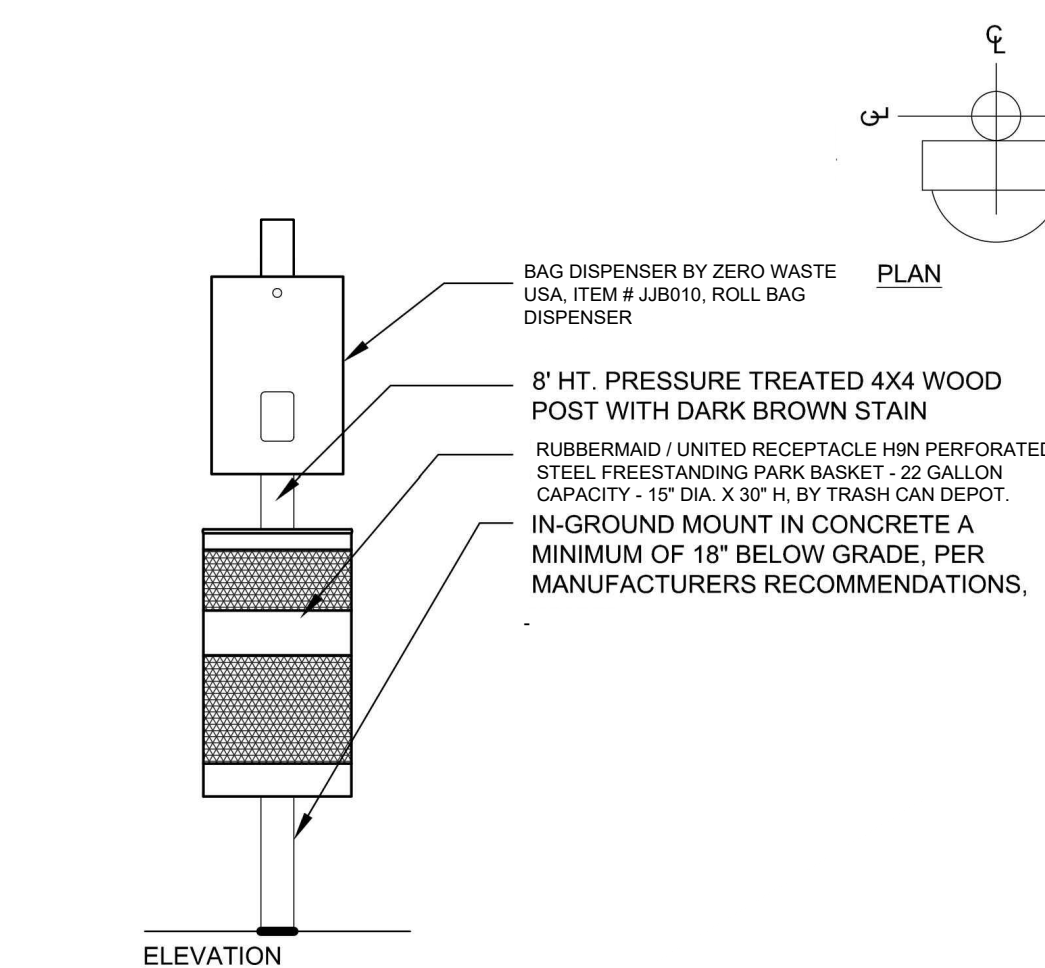

6 PET WASTE STATION

NOT TO SCALE




MODEL: FREESIA BIKE RACK BFRE-161
STANDARD CONVEX RIVETED LID
MANUFACTURER: VICTOR STANLEY, INC.
AS SUPPLIED BY DOWNS & ASSOCIATES
CONTACT:
MELANIE POLANCO
P: 303-744-0399

PATERSON-WILLIAMS ATHLETICS 15\"/>



7 GRILL

NOT TO SCALE

Drawn by:	BEM, GS
Checked by:	PCS STAFF
Submittal Date:	08.01.2017
	02.27.2018
Know what's below. Call before you dig.	08.20.2020
	10.19.2020
	11.23.2020
	03.16.2022

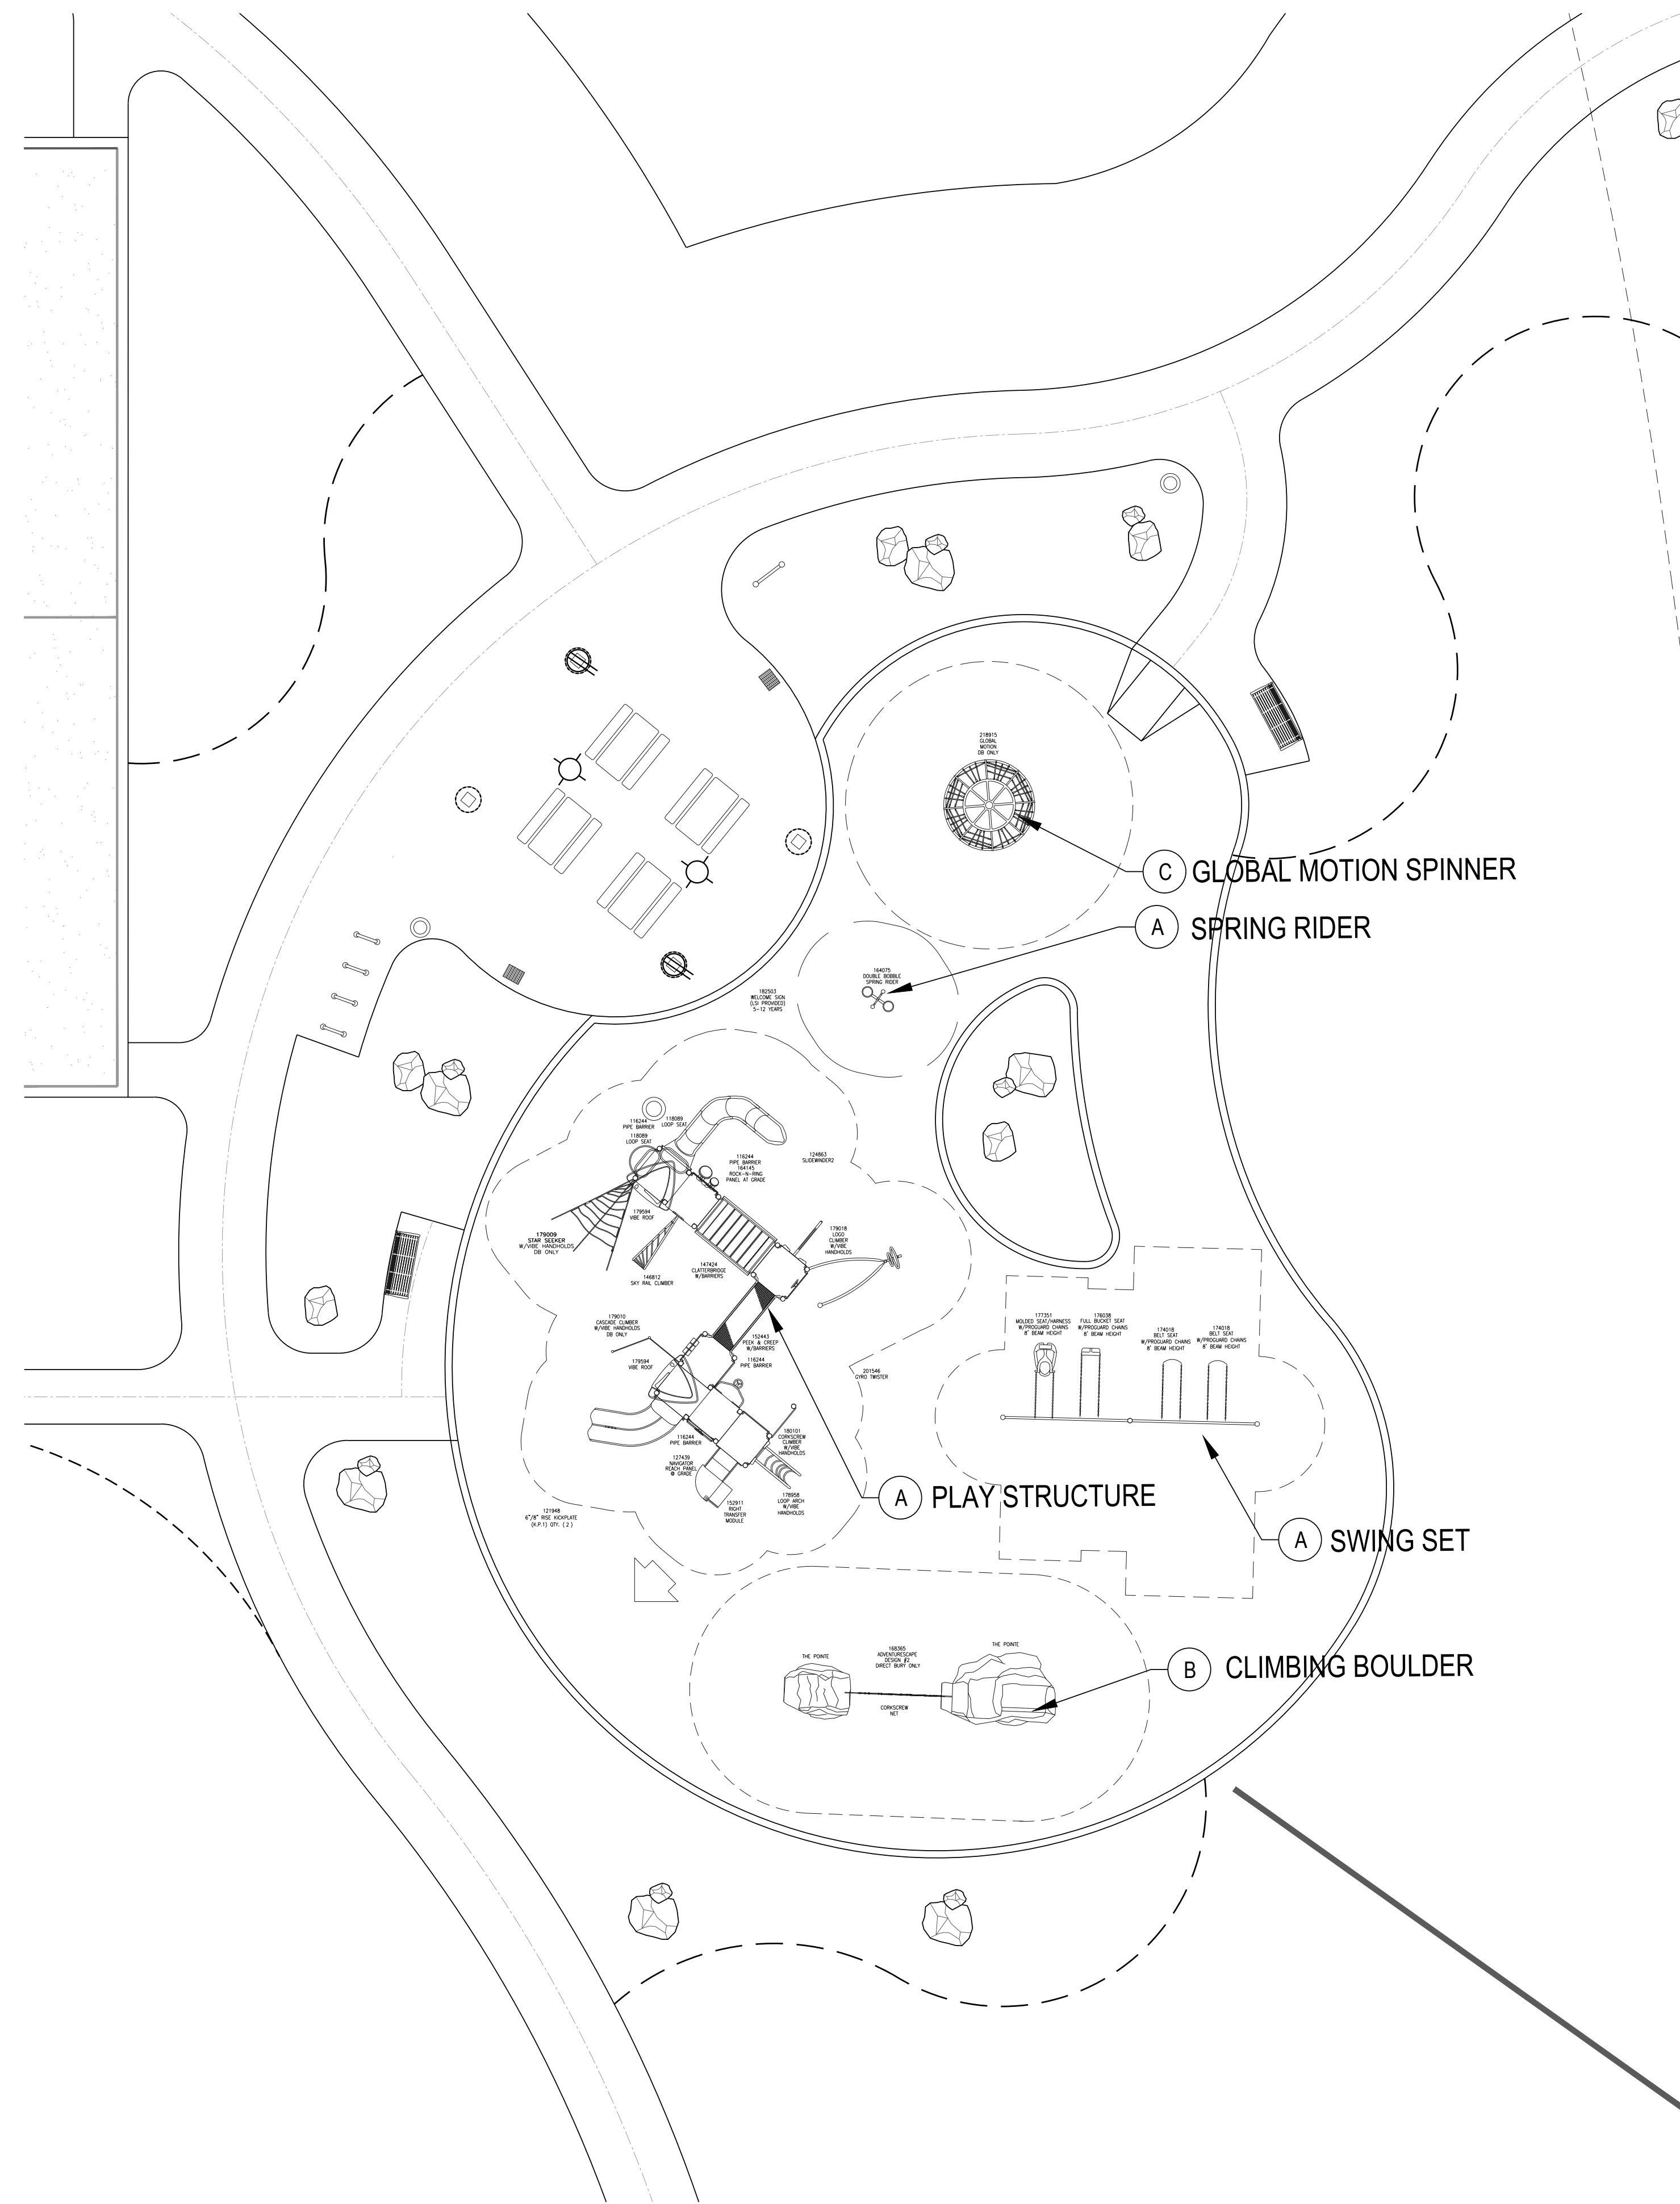

1 PLAYGROUND EQUIPMENT
NOT TO SCALE

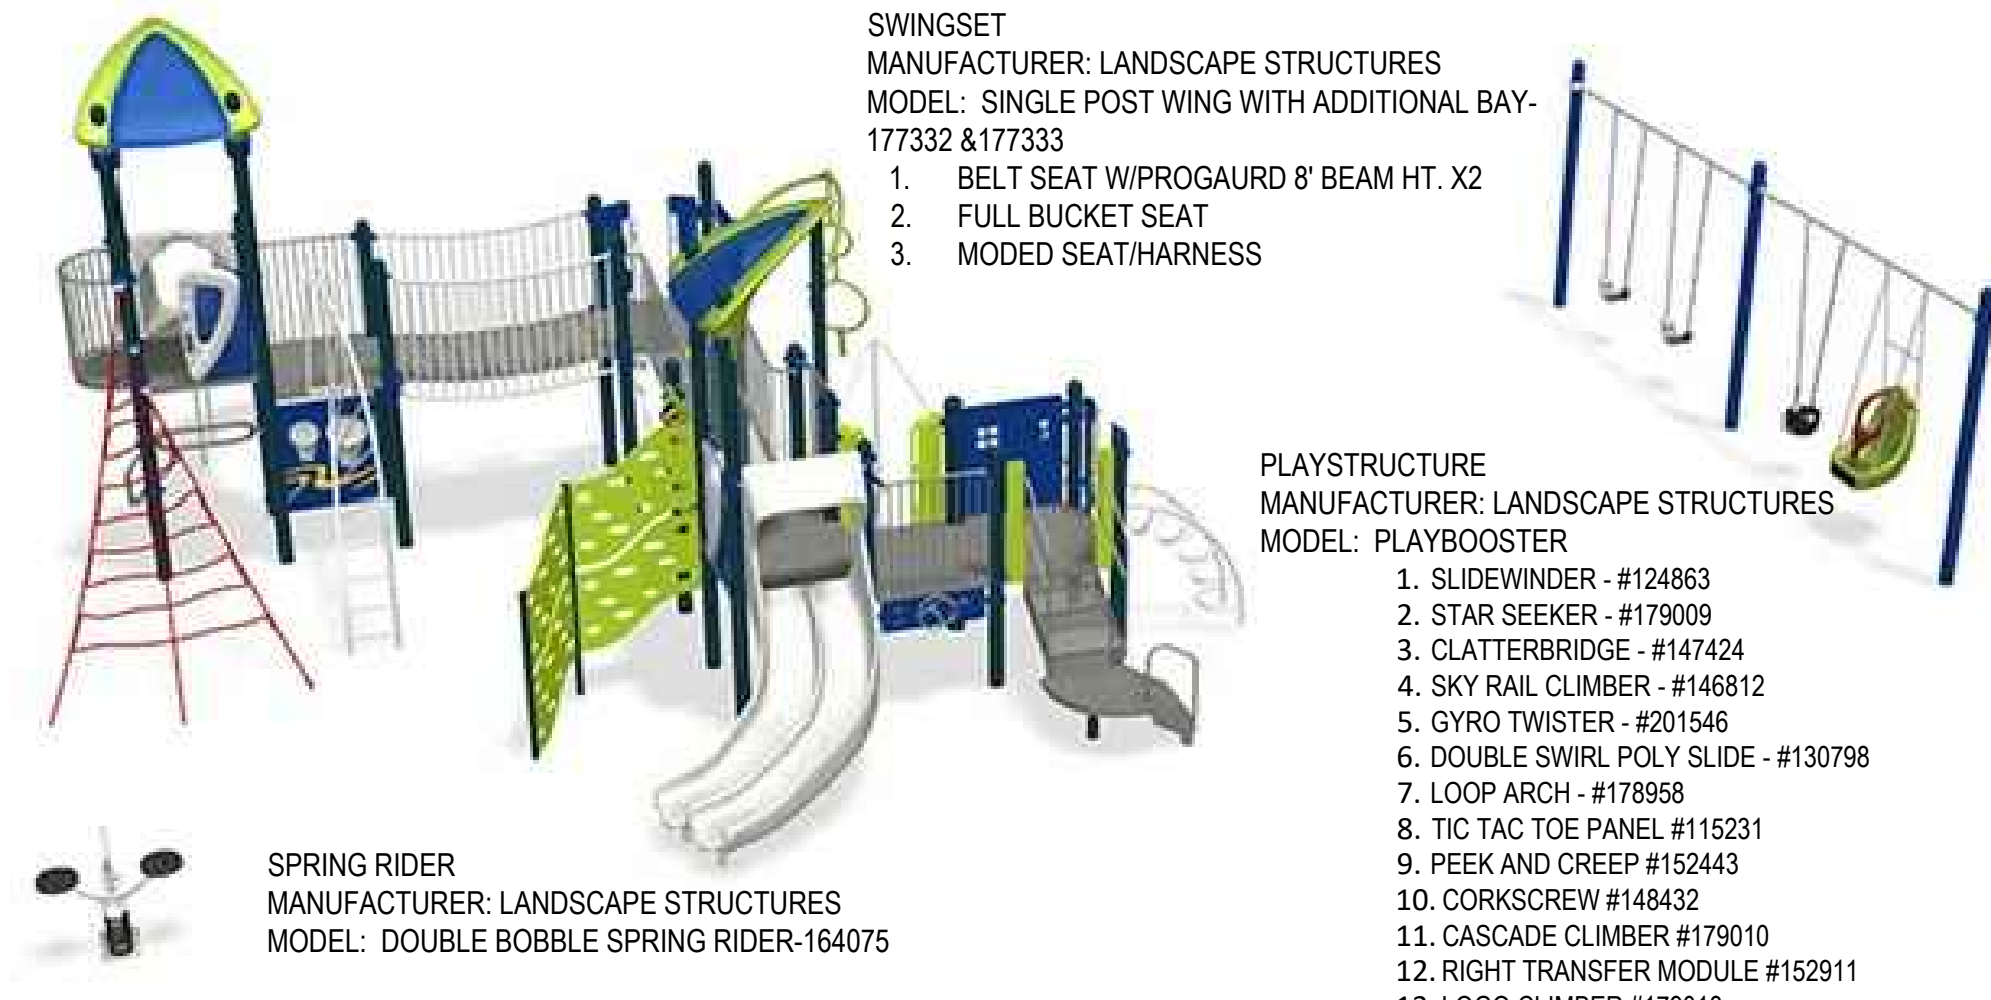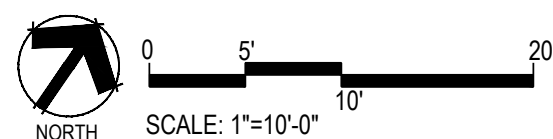


SWINGSET
MANUFACTURER: LANDSCAPE STRUCTURES
MODEL: SINGLE POST WITH ADDITIONAL BAY- 177332 & 177333
1. BELT SEAT W/PROGAURD 8' BEAM HT. X2
2. FULL BUCKET SEAT
3. MODED SEAT/HARNESS

SPRING RIDER
MANUFACTURER: LANDSCAPE STRUCTURES
MODEL: DOUBLE BOBBLE SPRING RIDER-164075

PLAYSTRUCTURE
MANUFACTURER: LANDSCAPE STRUCTURES
MODEL: PLAYBOOSTER
1. SLIDEWINDER - #124863
2. STAR SEEKER - #179009
3. CLATTERBRIDGE - #147424
4. SKY RAIL CLIMBER - #146812
5. GYRO TWISTER - #201546
6. DOUBLE SWIRL POLY SLIDE - #130798
7. LOOP ARCH - #178958
8. TIC TAC TOE PANEL #115231
9. PEEK AND CREEP #152443
10. CORKSCREW #148432
11. CASCADE CLIMBER #179010
12. RIGHT TRANSFER MODULE #152911
13. LOGO CLIMBER #179018

A PLAY STRUCTURE/SWINGS/SPRINGRIDER
NOT TO SCALE

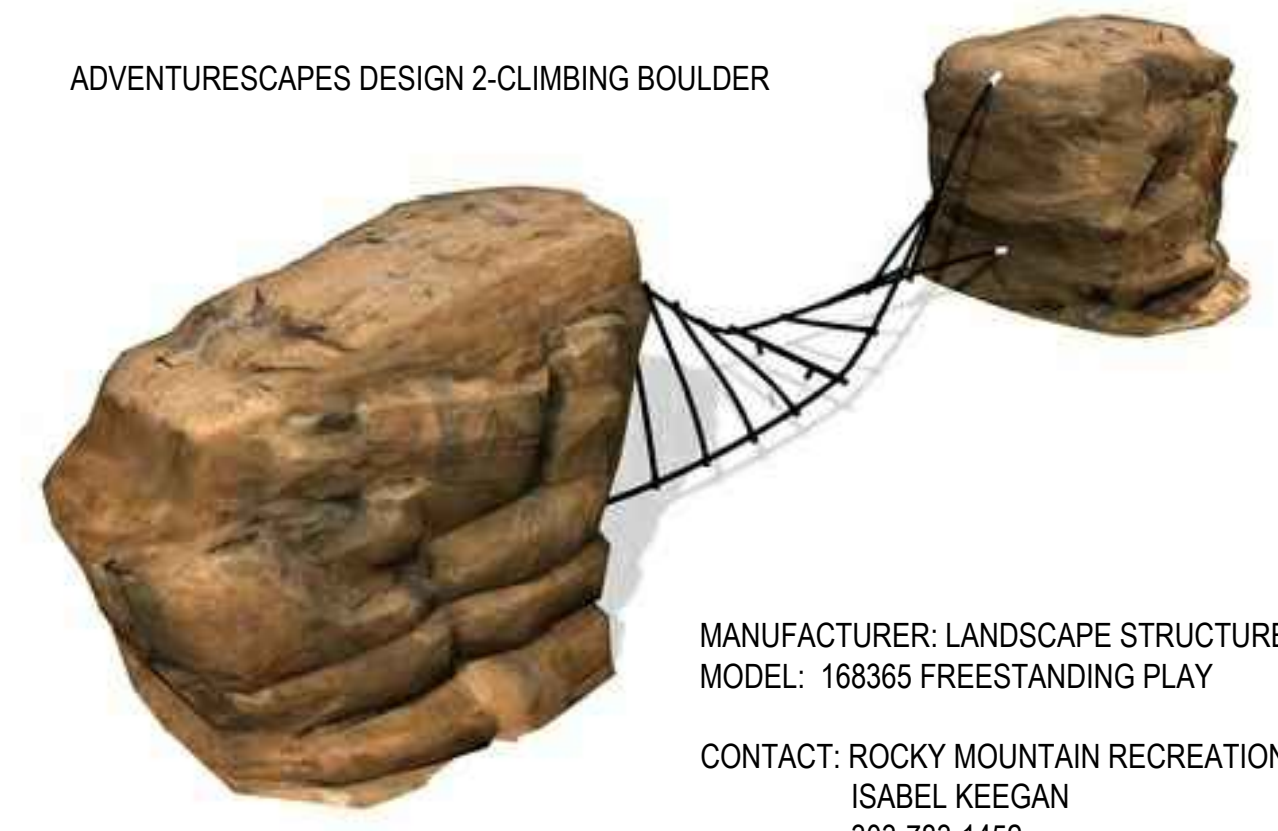

ADVENTURESAPES DESIGN 2-CLIMBING BOULDER

MANUFACTURER: LANDSCAPE STRUCTURES
MODEL: 168365 FREESTANDING PLAY
CONTACT: ROCKY MOUNTAIN RECREATION
ISABEL KEEGAN
303-783-1452

NOTES:
1. INSTALLATION PER MANUFACTURERS RECOMMENDATIONS

B CLIMBING BOULDER
NOT TO SCALE




MANUFACTURER: LANDSCAPE STRUCTURES
MODEL: 218915 FREESTANDING PLAY
CONTACT: ROCKY MOUNTAIN RECREATION

C GLOBAL MOTION SPINNER
NOT TO SCALE

Drawn by:	BEM_GG
Checked by:	PCS STAFF
Submittal Date:	08.01.2017
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Know what's below. Call before you dig.	08.20.2020
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	11.23.2020
	03.16.2022


YIHSS RANCH LANDSCAPE ARCHITECTURE CURRENT DINGSBUSH PARK PLANS DWG
Thursday, July 20, 2017

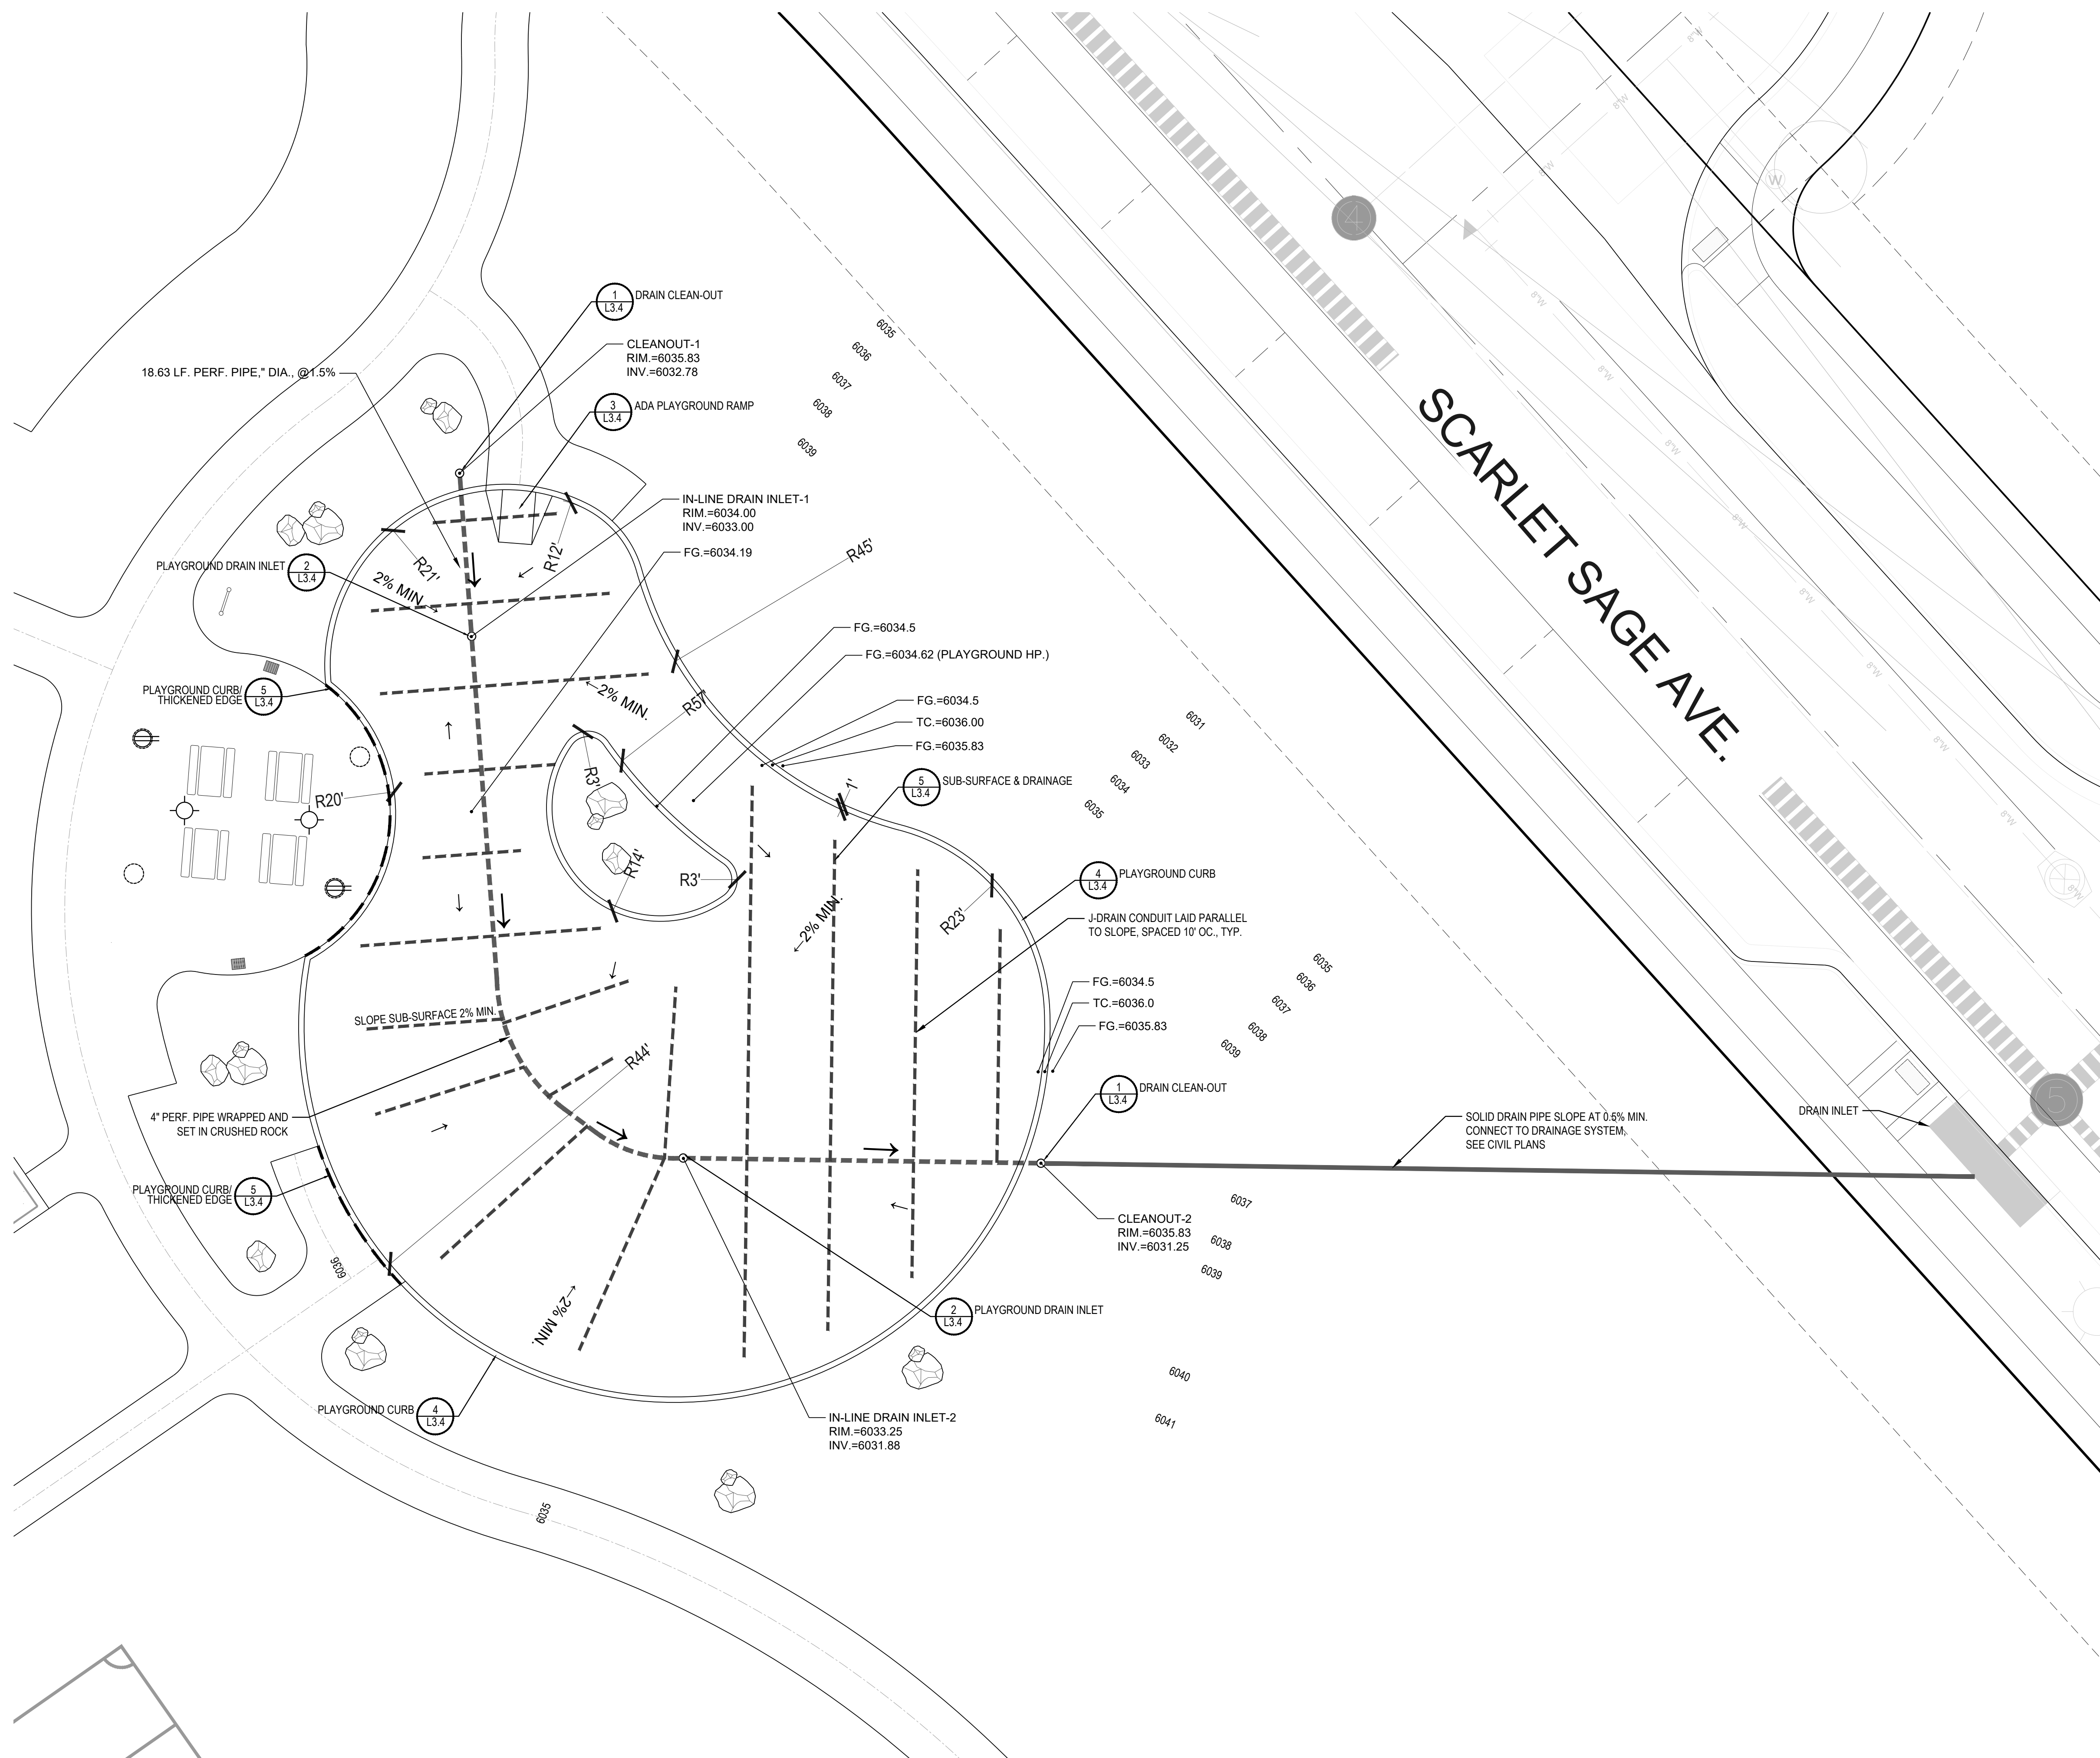


1 PLAYGROUND GRADING & LAYOUT


NOT TO SCALE

NOTES:
1. PLAYGROUND CURB SHALL SLOPE WITH GRADE. DO NOT STEP.
2. ALL CONTOURS SHOW FINISHED GRADE WITH PLAYGROUND SURFACING INSTALLED

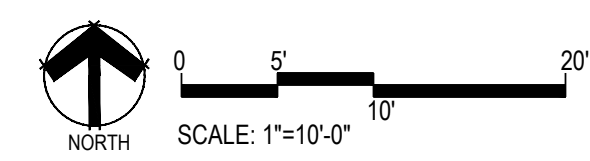


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 CENTENNIAL, CO 80112

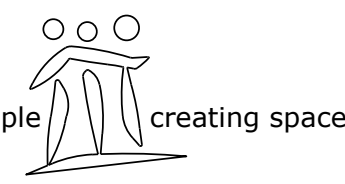■ Land Planning ■

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 pcs group inc. www.pcsgroupco.com
 #3, 8-180 Independence Plaza
 1007 14th Street, Denver, CO 80202
 T 303.531.4905 F 303.531.4908


■ Engineering ■

 CVL CONSULTANTS
 10333 E. DRY CREEK RD. #240
 ENGLEWOOD, CO 80112
 720-482-9526

TRAILS AT CROWFOOT
 PARK PLANS
 PARKER, COLORADO
 LANDSCAPE PLANS


Drawn by:	BEM, GS
Checked by:	PCS STAFF
Submittal Date:	08.01.2017
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Know what's below. Call before you dig.	08.20.2020
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	03.16.2022

■ Sheet Name ■
 LANDSCAPE DETAILS

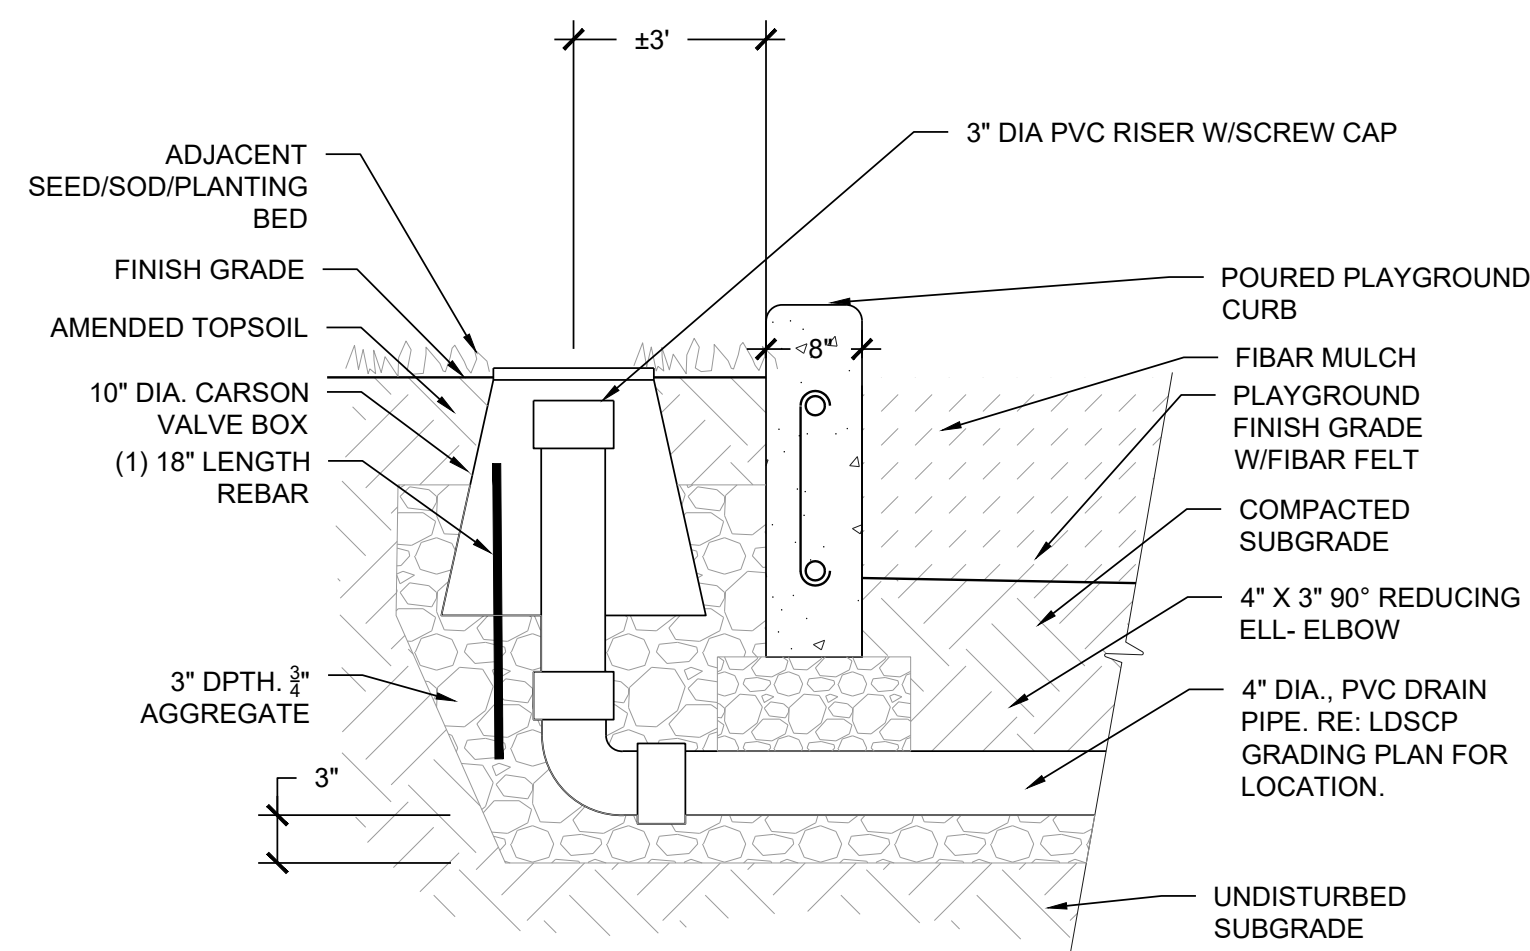
■ Sheet Number ■
 L3.3




1 DRAIN CLEAN-OUT NOT TO SCALE

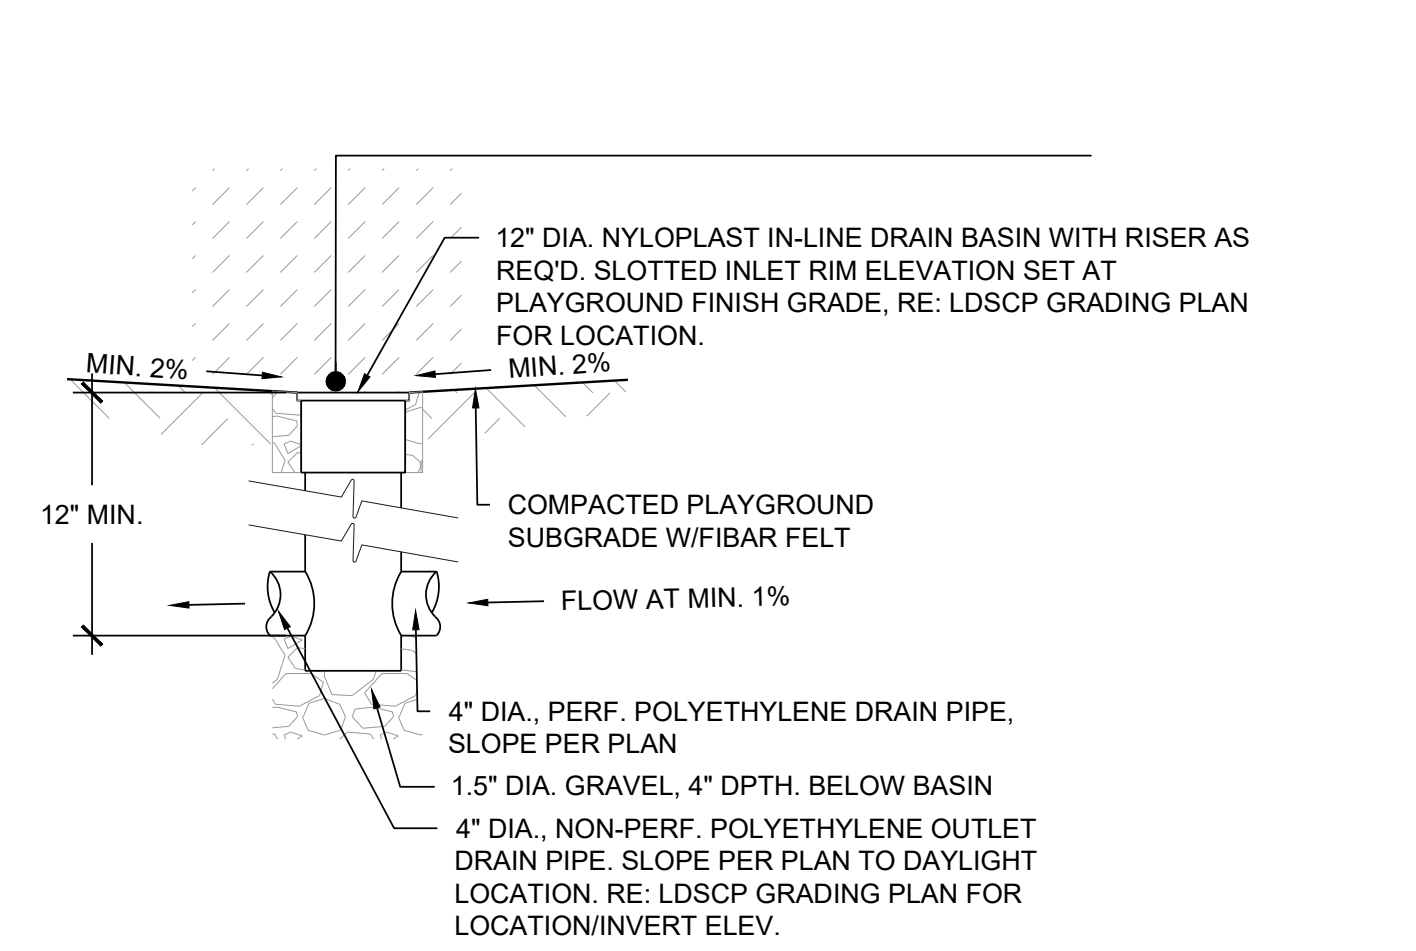


2 PLAYGROUND DRAIN NOT TO SCALE

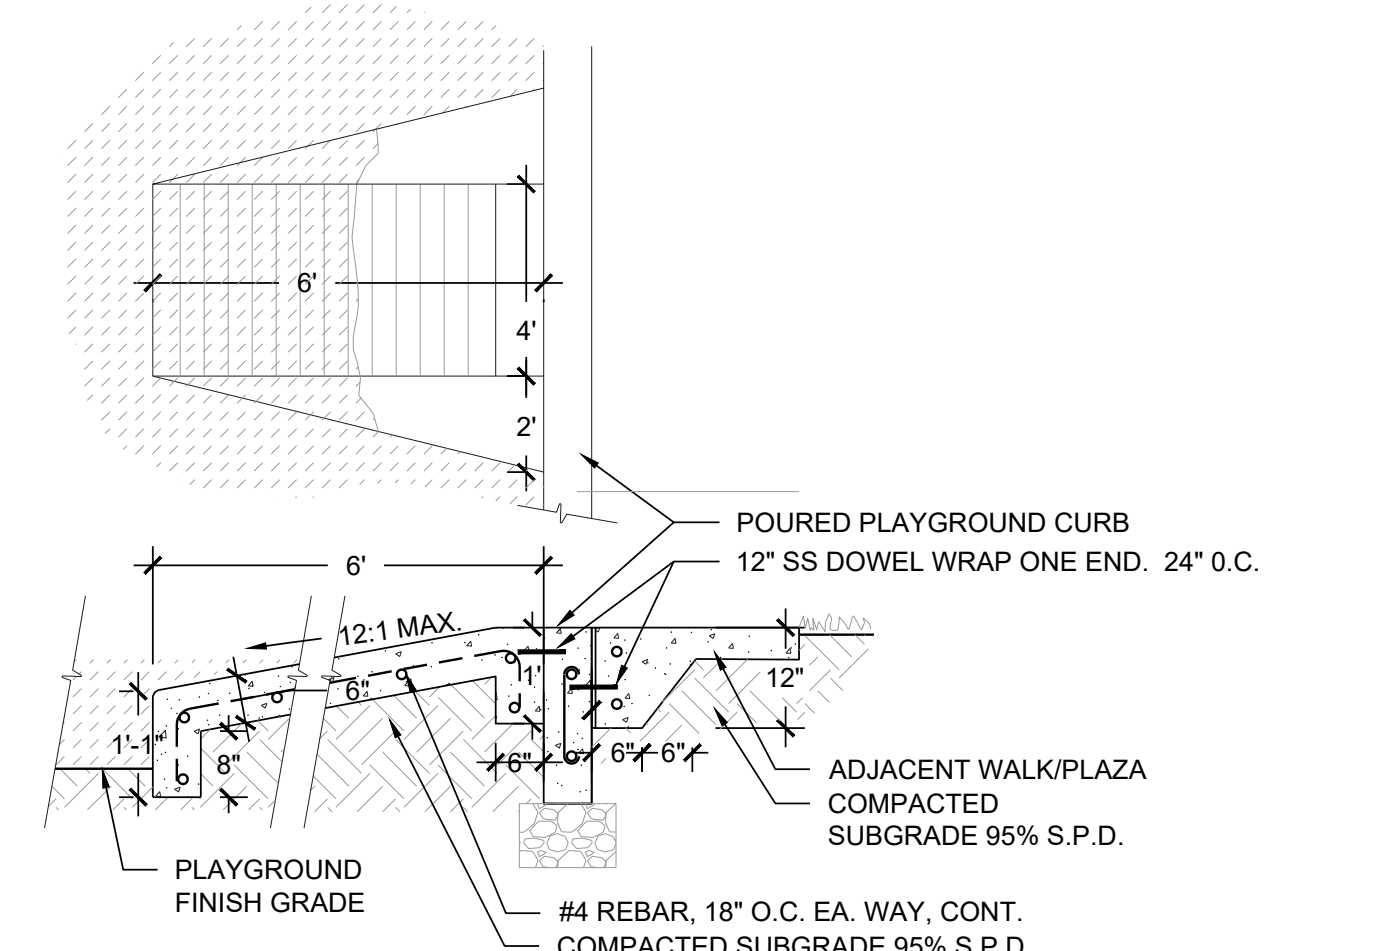


3 ADA PLAYGROUND RAMP NOT TO SCALE

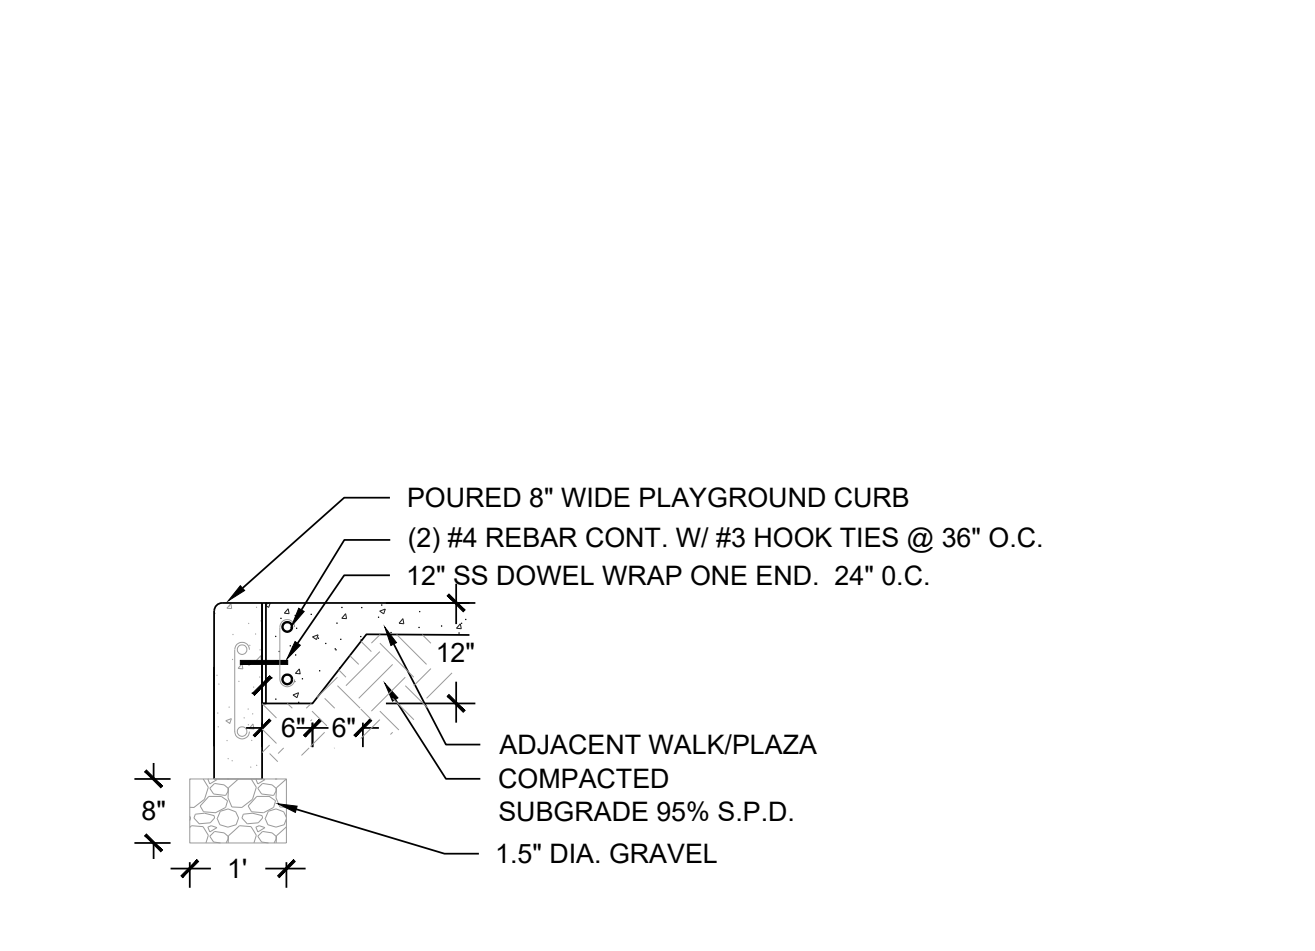

4 PLAYGROUND CURB NOT TO SCALE

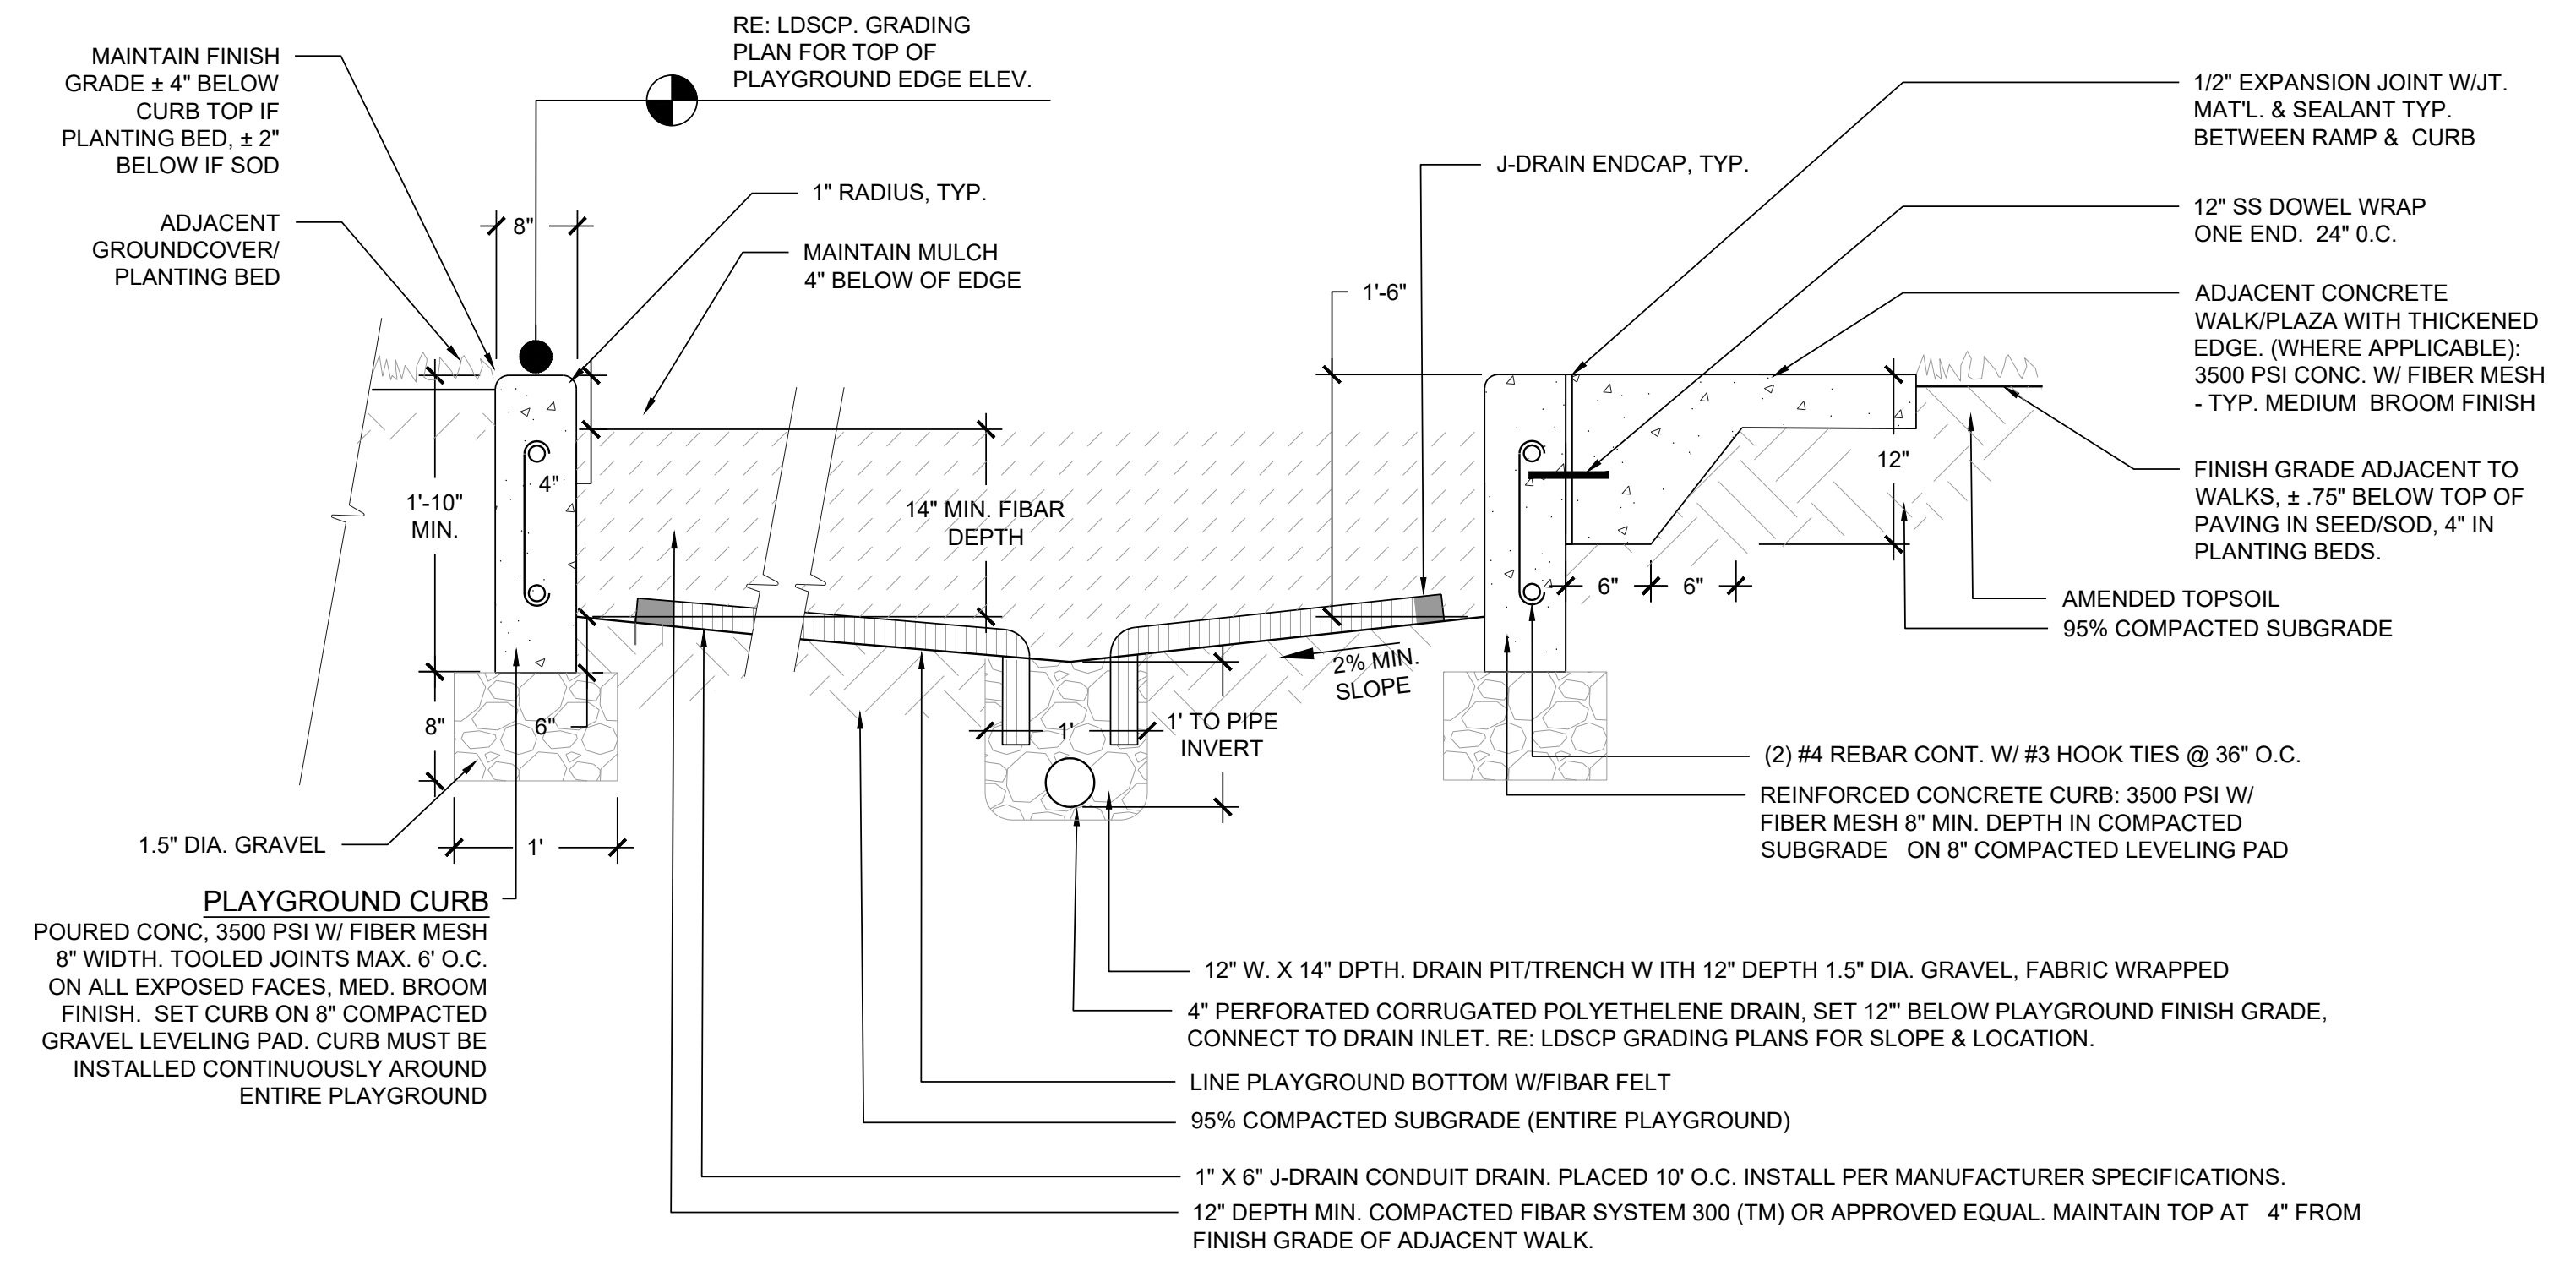

5 PLAYGROUND, CURB, SURFACE & DRAINAGE NOT TO SCALE

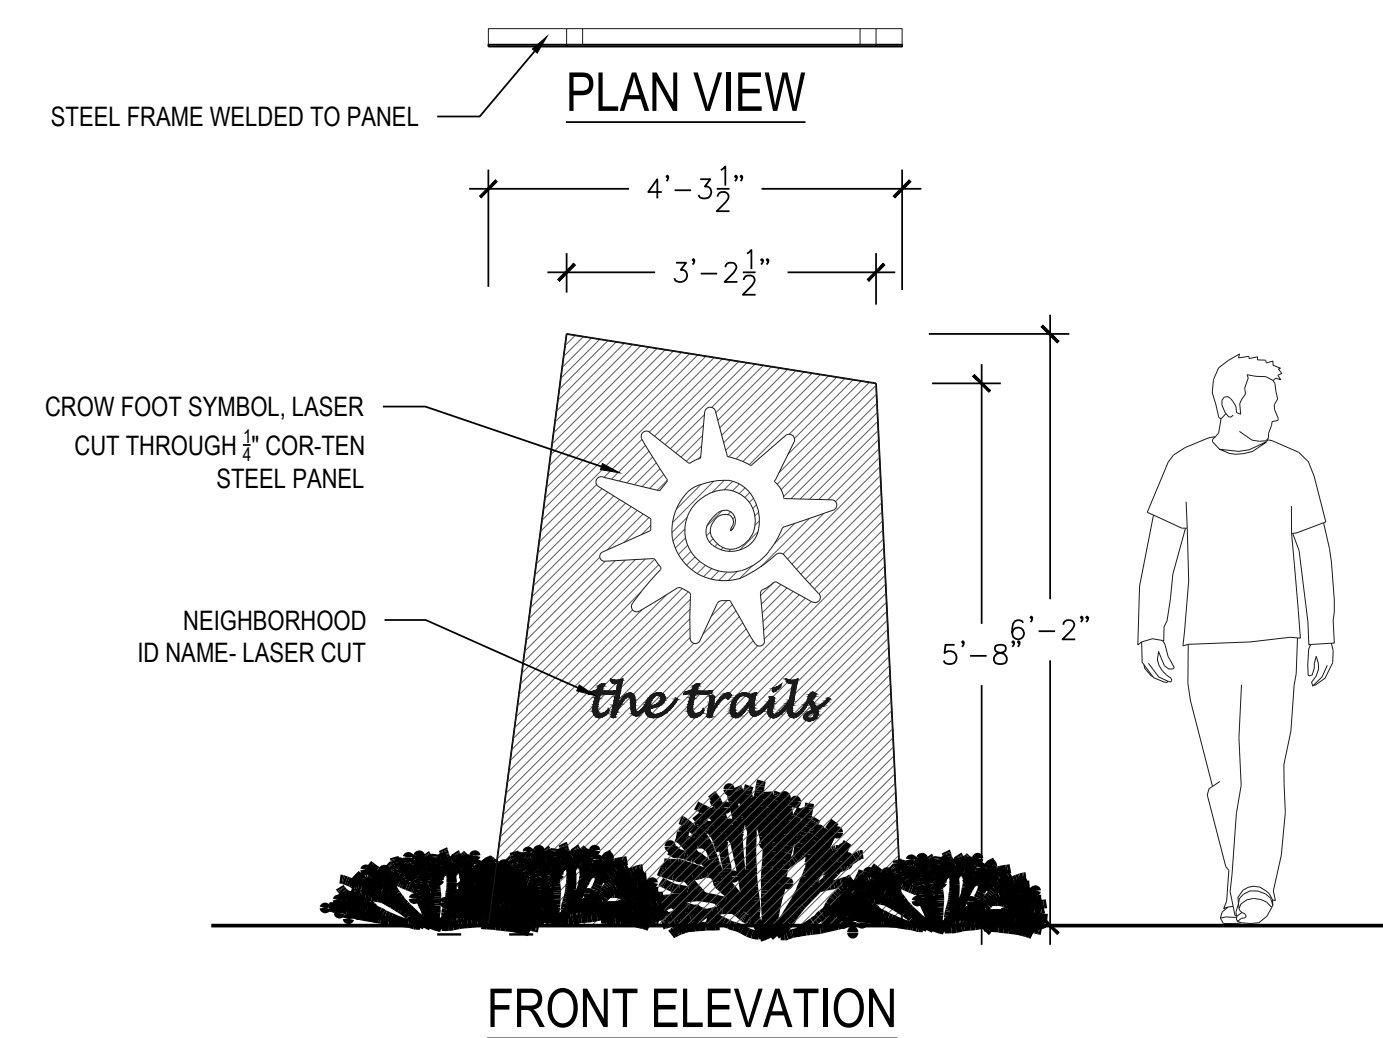

6 PARK SIGN NTS

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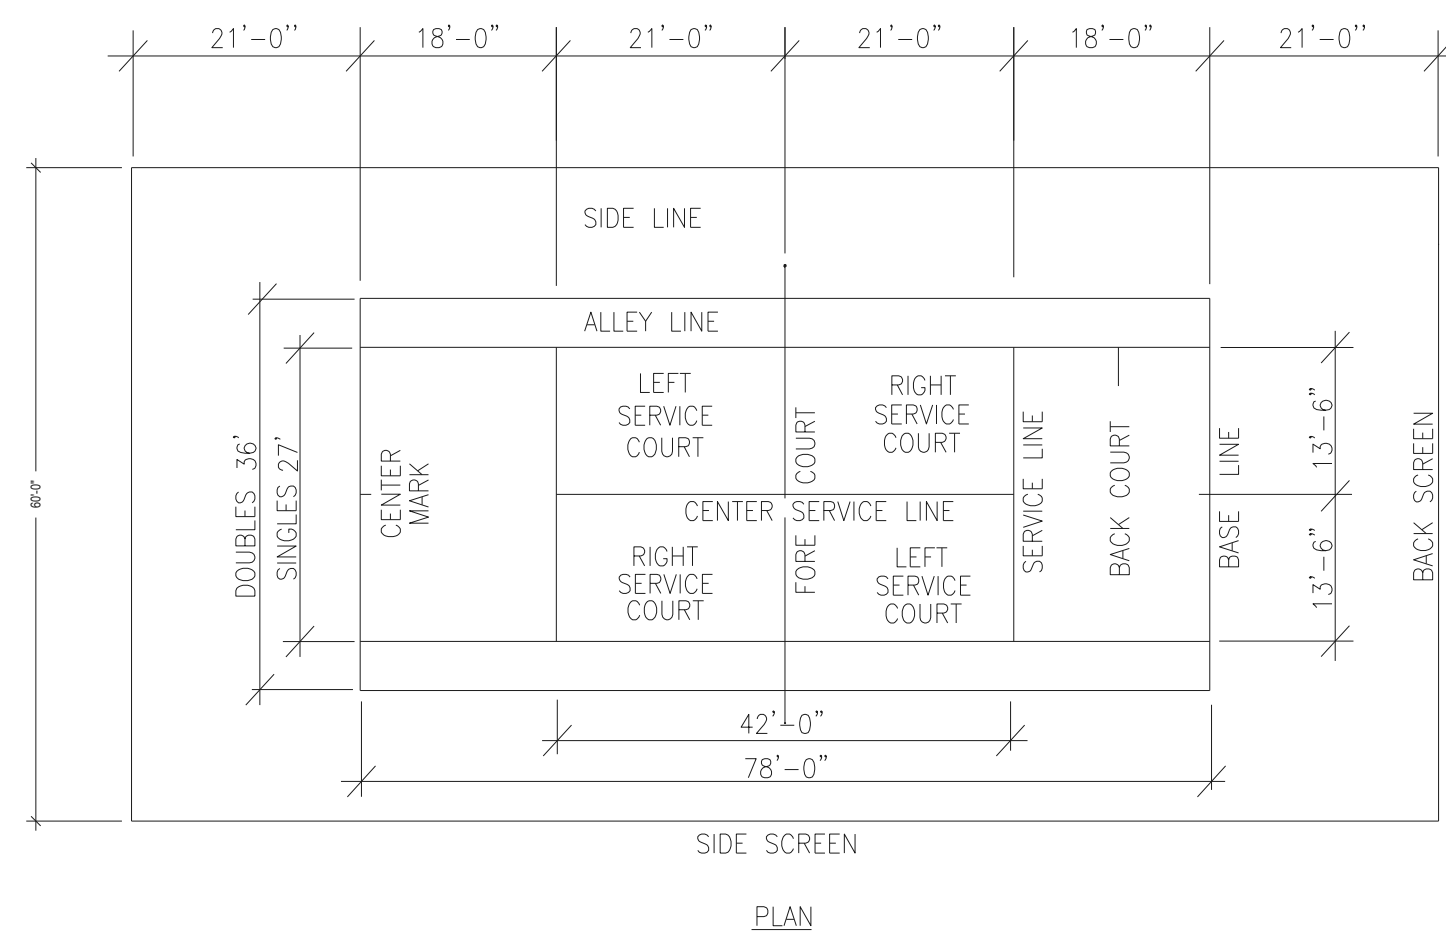
■ Engineering ■
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TRAILS AT CROWFOOT
 PARK PLANS
 PARKER, COLORADO
 LANDSCAPE PLANS


Drawn by:	BEM, GG
Checked by:	PCS STAFF
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■ Sheet Name ■
 LANDSCAPE
 DETAILS


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L3.4




1 TENNIS STRIPING NOT TO SCALE

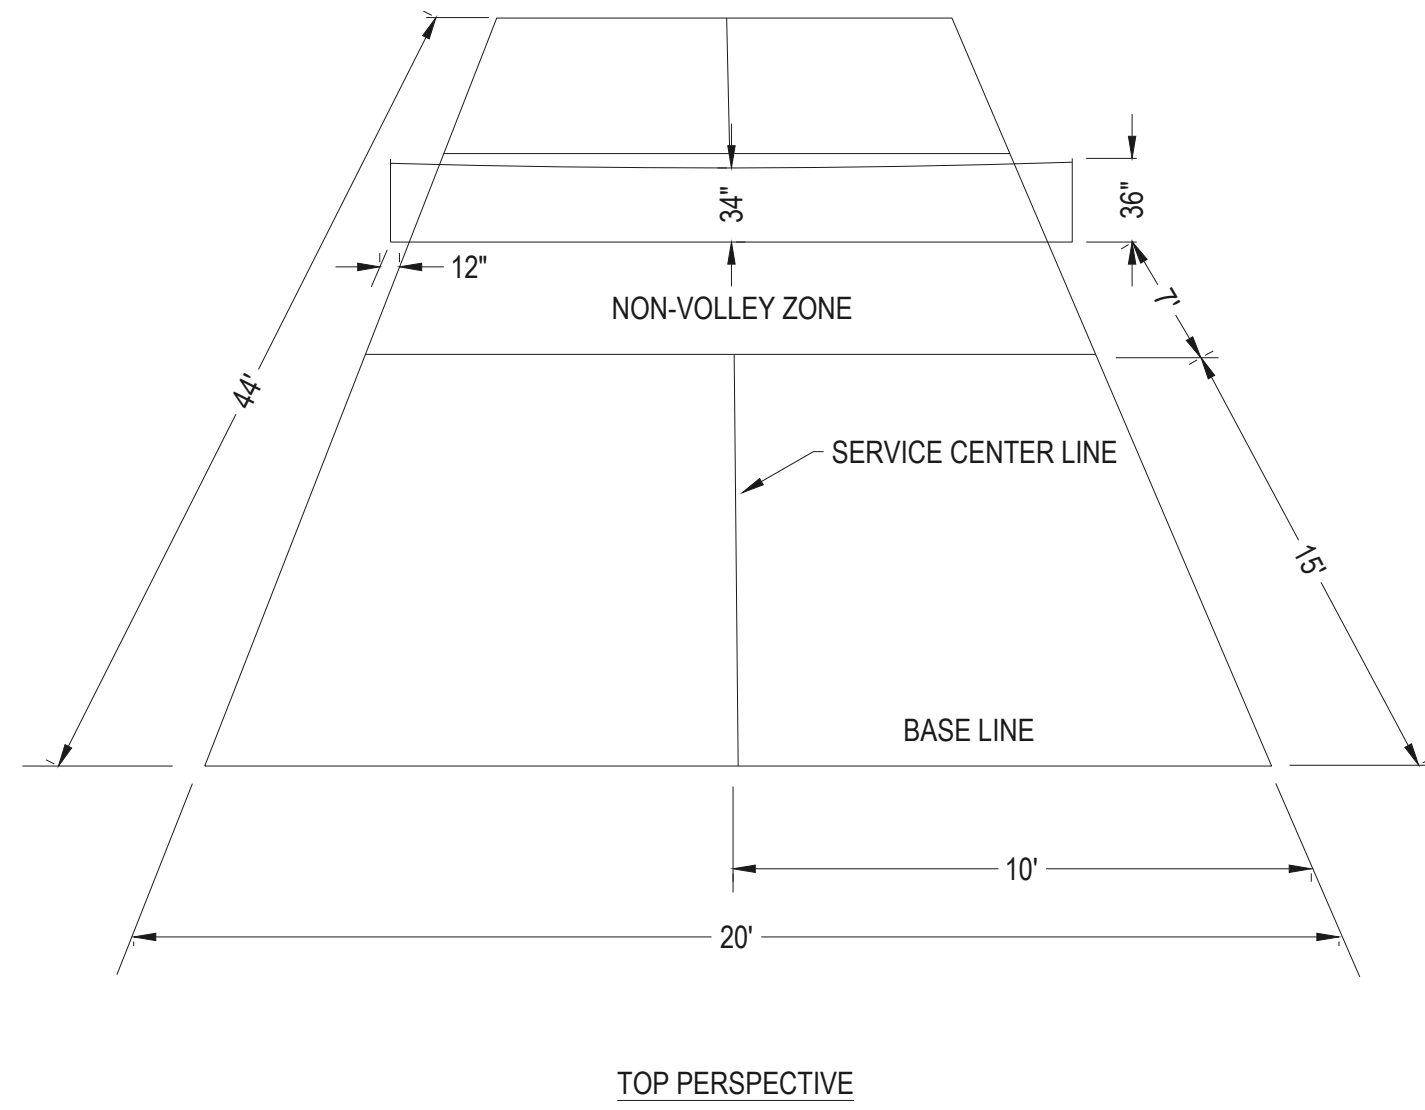

2 PICKLEBALL STRIPING NOT TO SCALE

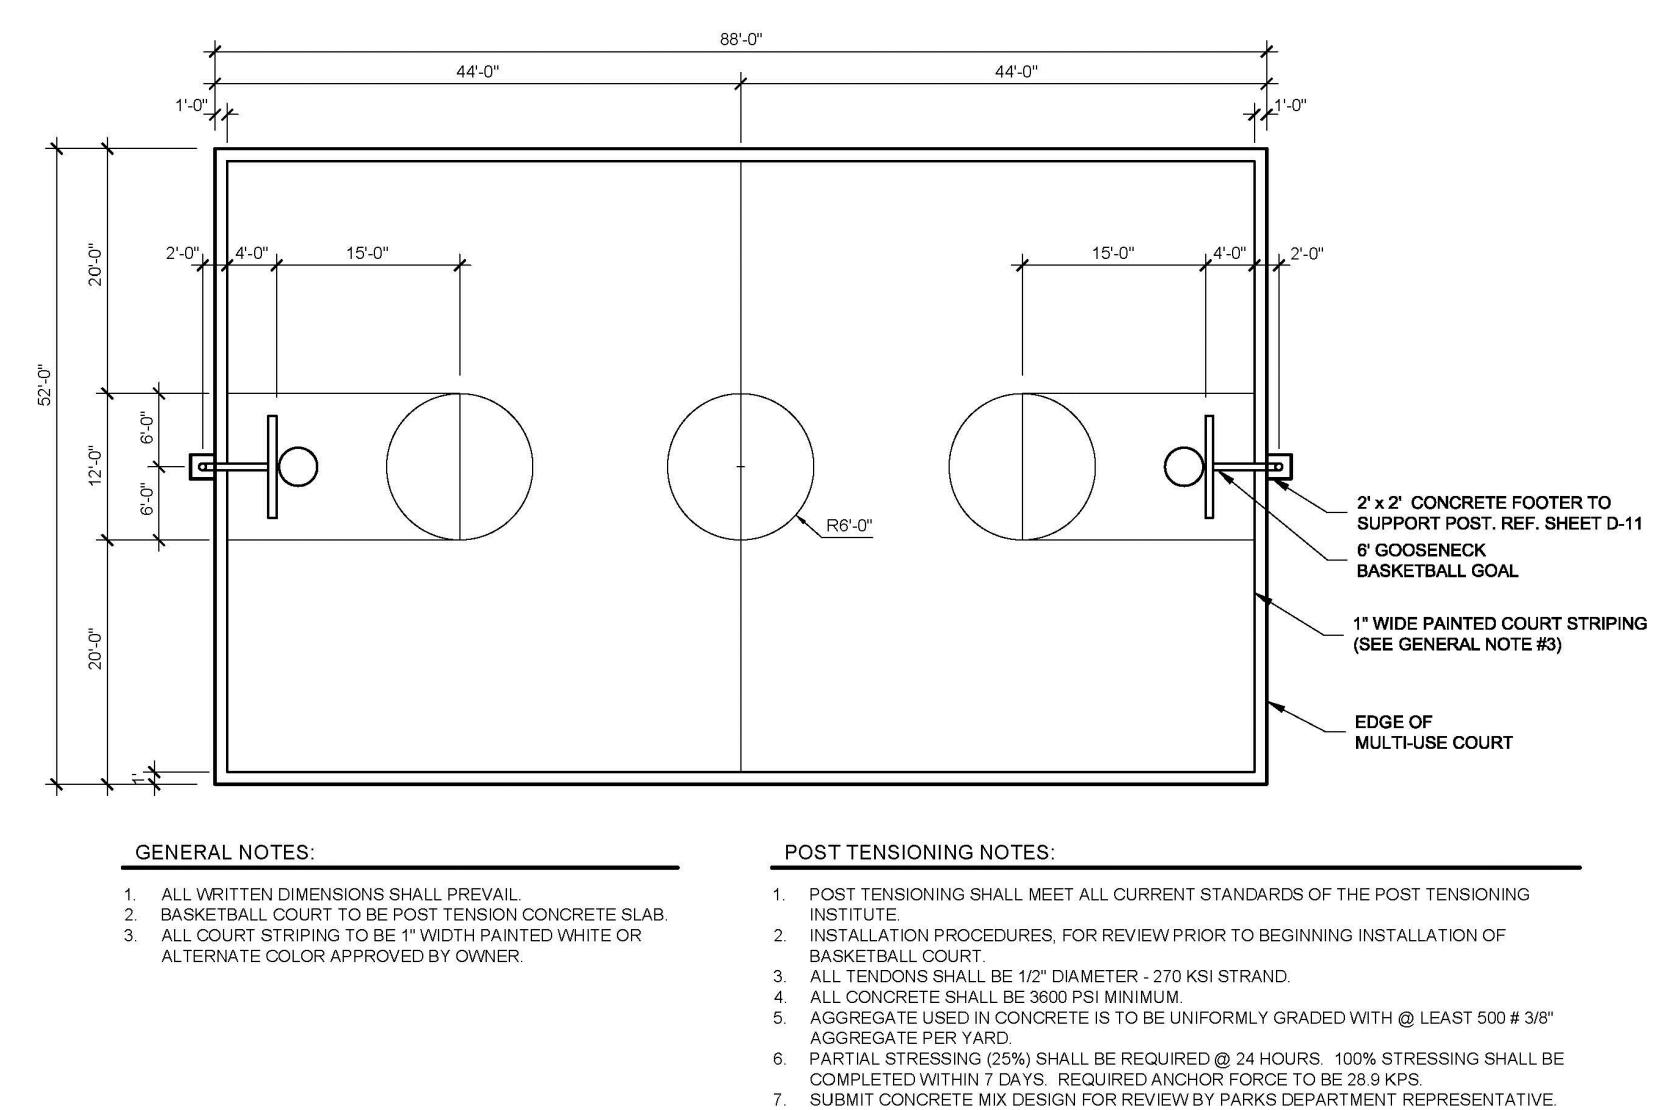


3 BASKETBALL STRIPING/LAYOUT NOT TO SCALE

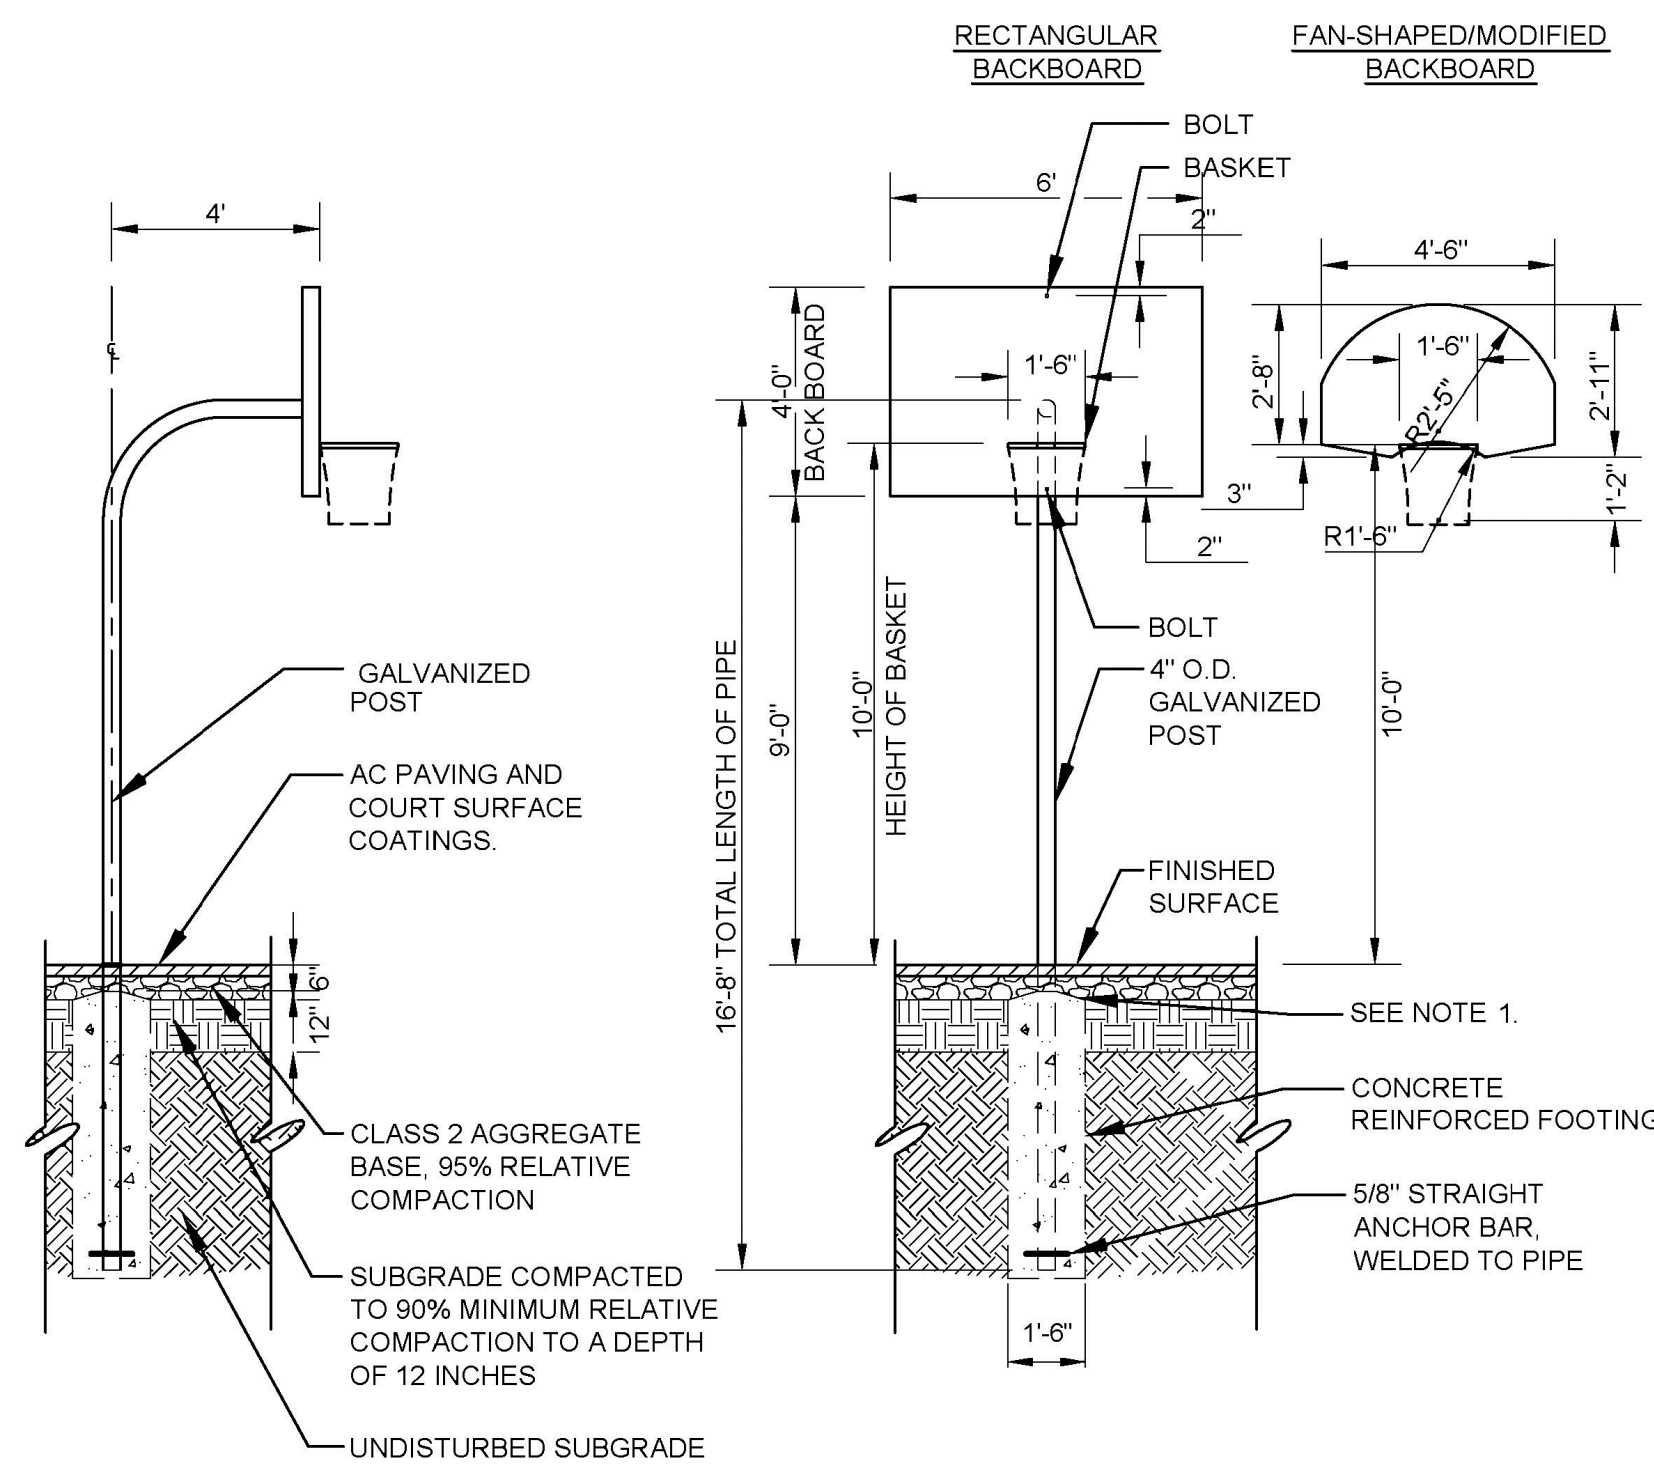


NOTES:
 1. HOLD THE HIGH POINT OF THE CONCRETE FOOTING 6 INCHES BELOW THE FINISHED SURFACE. THE FOOTING SHALL SLOPE AWAY FROM THE POLE TO DRAIN.

MANUFACTURER: PATTERSON WILLIAMS ATHLETIC MFG. CO
 MODEL # 1523-22-45-34 POWDER COAT; BLUE
 CONTACT: RECREATION PLUS, LTD. 3032781455 LETSPLAY@RECREATIONPLUS.COM


4 BASKETBALL HOOP NOT TO SCALE

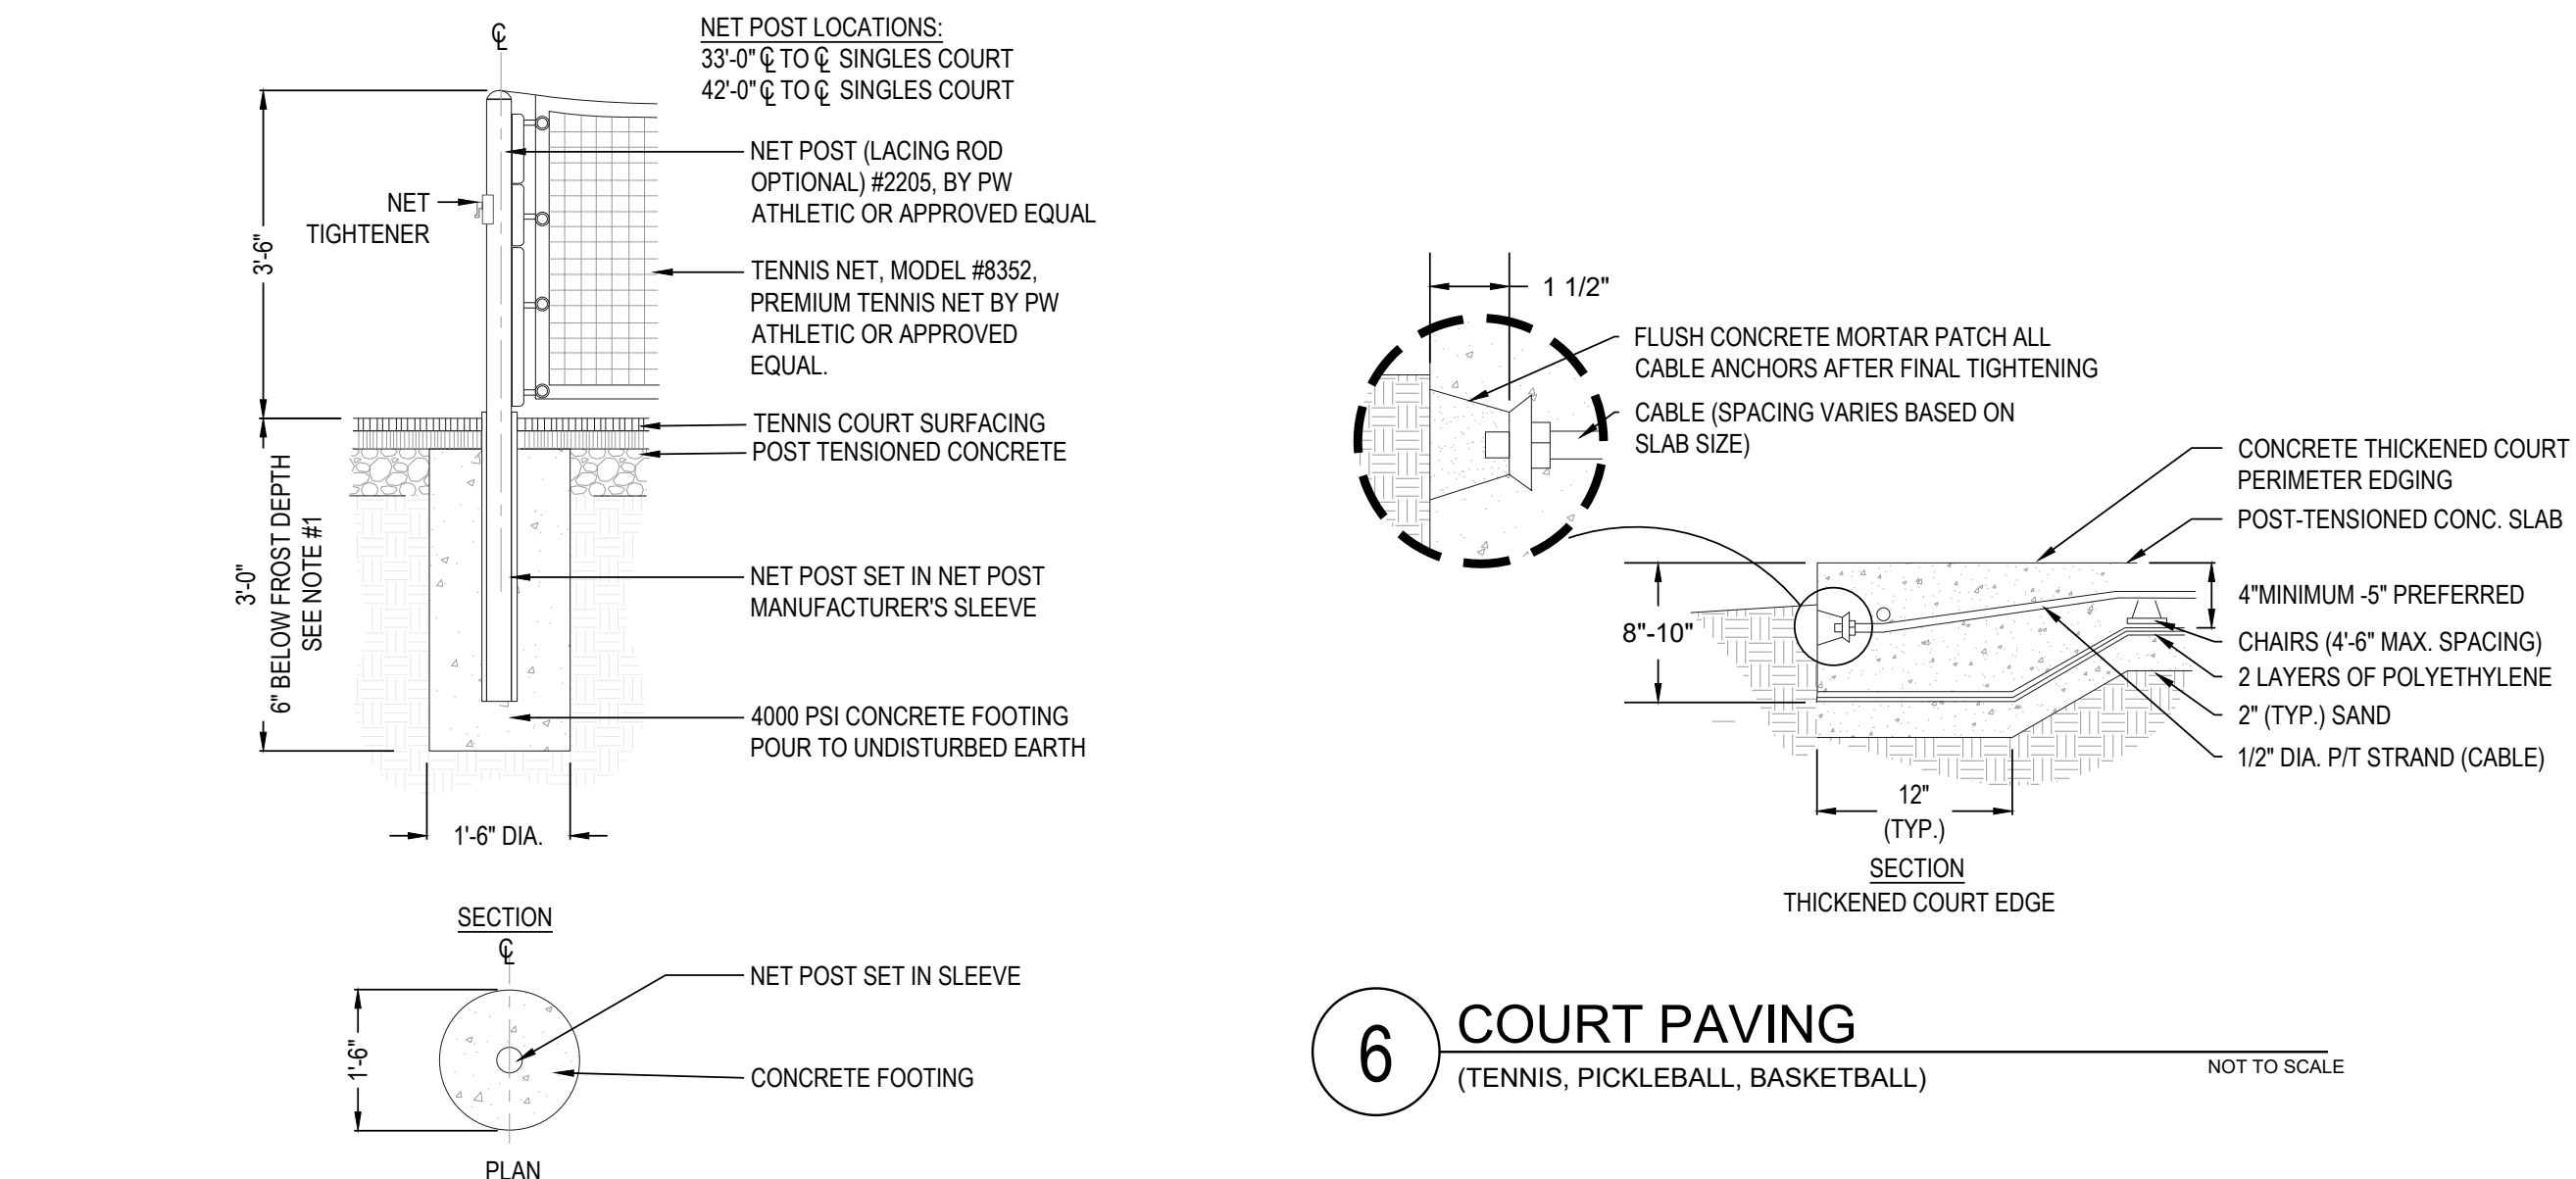


5 TENNIS/PICKLEBALL NET NOT TO SCALE

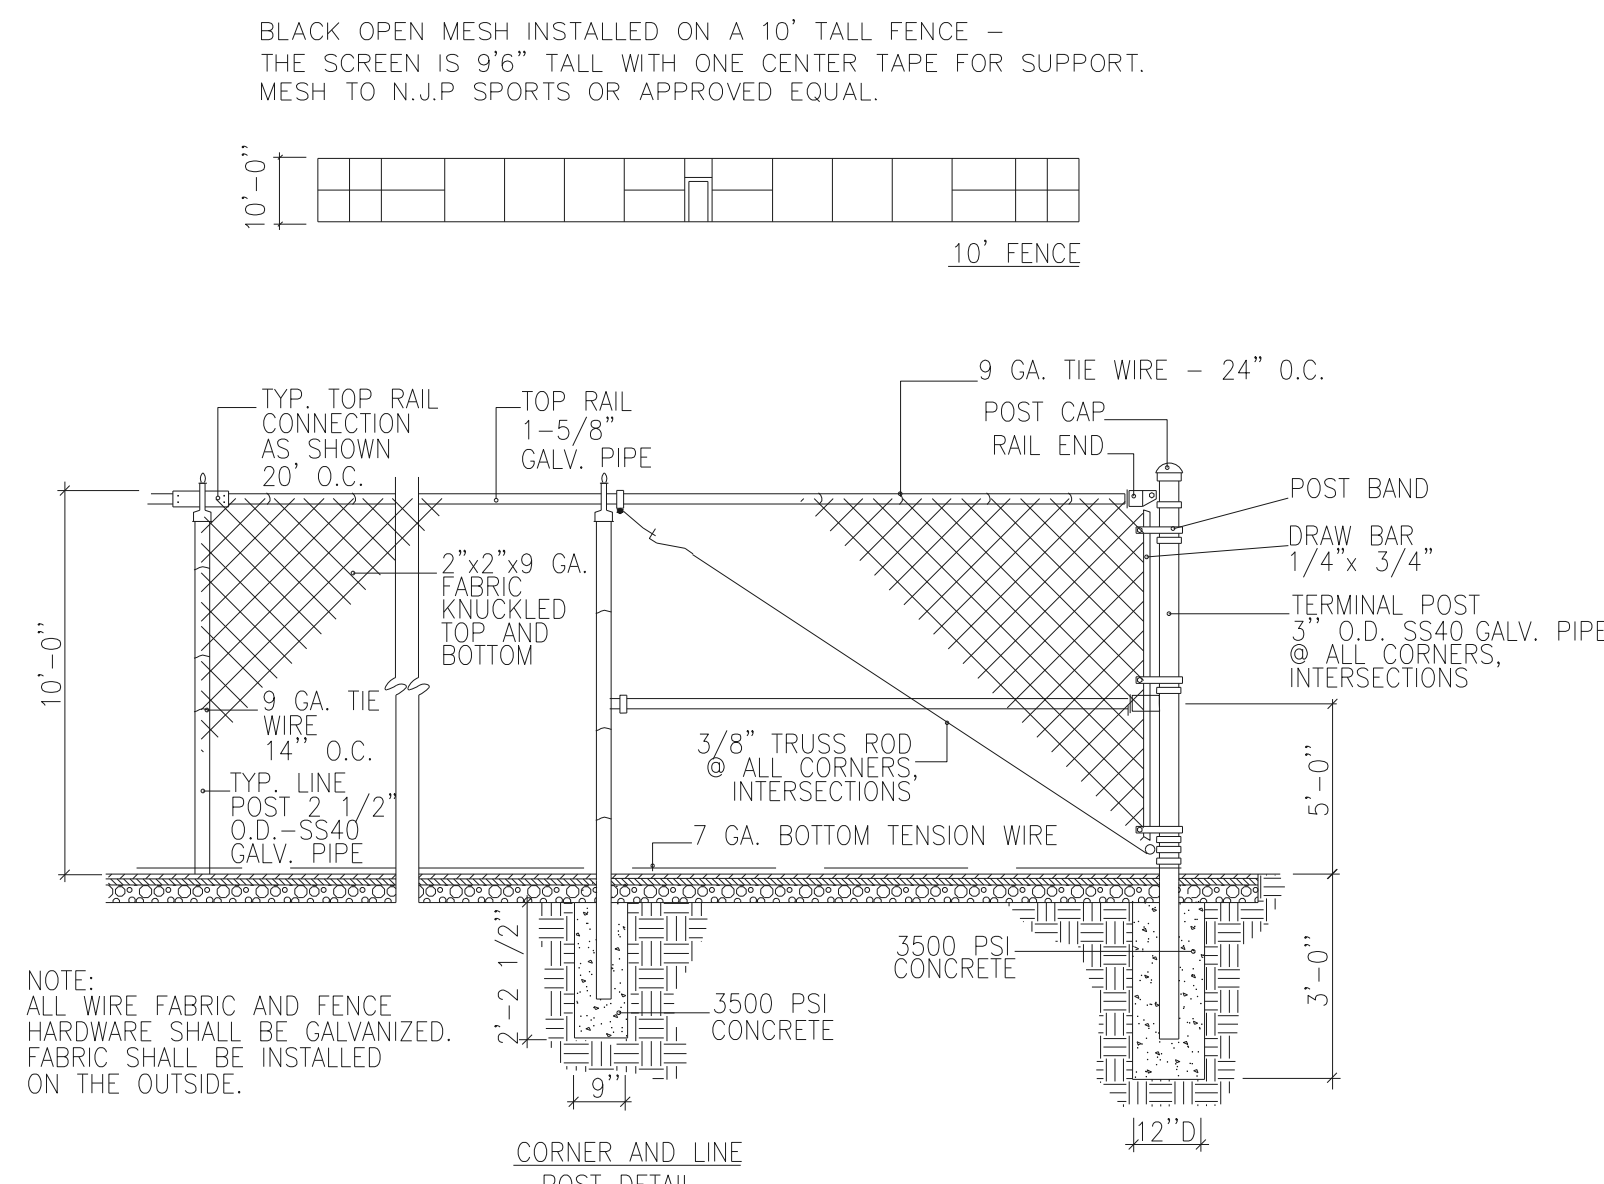

7 TENNIS/PICKLEBALL FENCING NOT TO SCALE

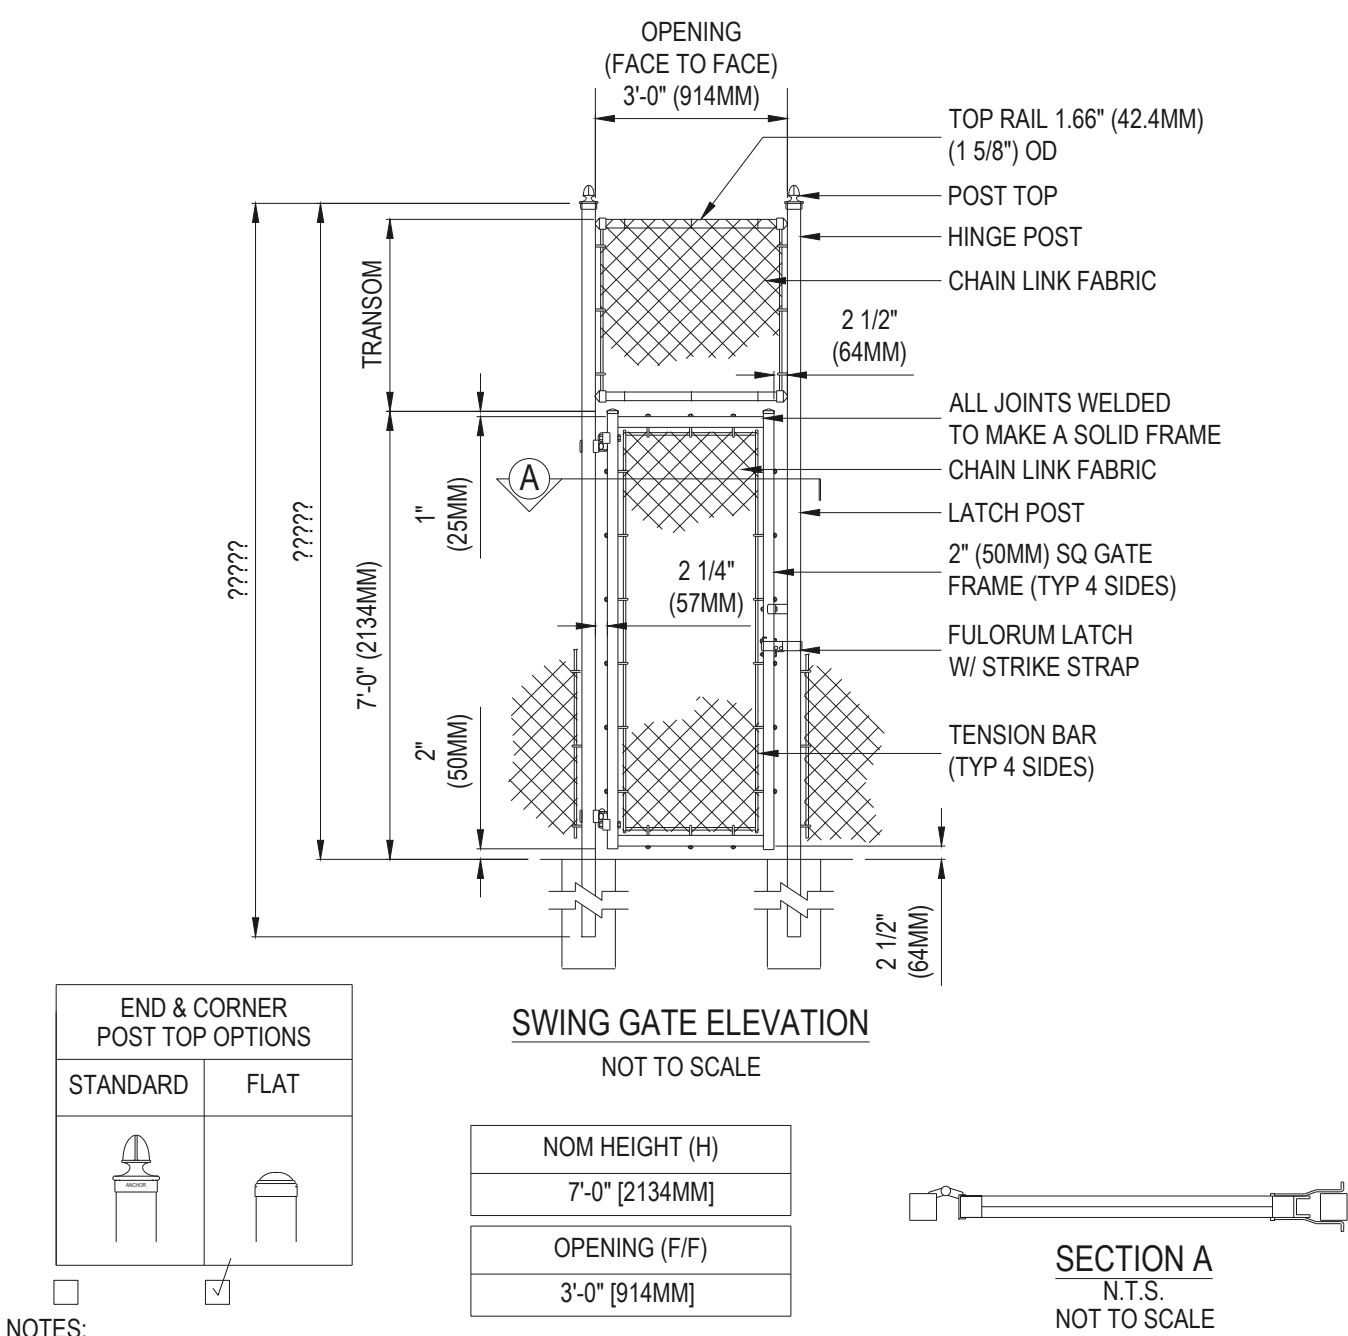

8 TENNIS/PICKLEBALL SWING GATE NOT TO SCALE

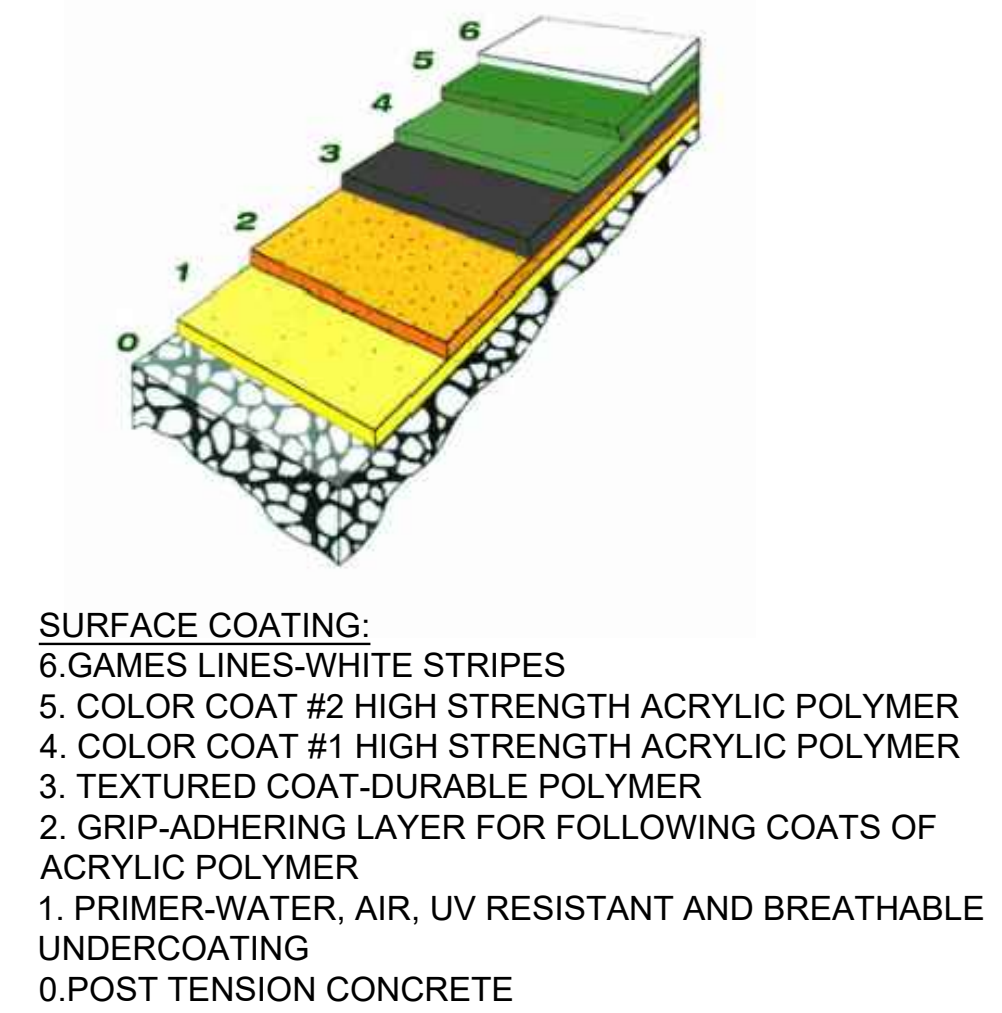

YINNESS RANCH LANDSCAPE ARCHITECTURE/RECURRENT DIVISIONS BUSINESS PARK PLANS DWG Thursday, July 20, 2017

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Engineering

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 CONSULTANTS

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TRAILS AT CROWFOOT
 PARK PLANS
 PARKER, COLORADO
 LANDSCAPE PLANS

Drawn by: BEM, GS
 Checked by: PCS STAFF
 Submittal Date: 08.01.2017
 Date: 02.27.2018
 08.20.2020
 10.19.2020
 11.23.2020
 03.16.2022

Sheet Name

LANDSCAPE DETAILS

Sheet Number

L3.5

DISCatcher

Disc Golf Target

PERMANENT TARGET GROUND TUBE INSTALLATION

Parts included per target location:

- Installation Tube


Installation tools and extras needed:

- One Target Pole & Locking Collar (see assembly Step 1 on page 2)
- One 1/2" x 3/4" padlock
- 60 pounds of concrete per target
- Post hole digger or auger
- Torpedo level or equivalent level

STOP WARNING: Before digging always contact your local utilities and property maintenance to locate any underground lines. (Water, Gas, Electrical, Sprinkler, etc.)

SETTING THE INSTALLATION TUBE (Diagram 1)

- Step 1 Dig a hole that is at least 6 inches in diameter and 24 inches deep. Most manual post hole diggers create a 6 inch diameter hole, but if you are installing an entire course it is maybe worth the money to rent a two man auger with a 6 inch bit.
- Step 2 Assemble one pole and locking collar according to Step 1 of Target. Assembly (see other page). Tape the bottom of the installation tube with duct tape or packing tape to prevent any concrete getting into the tube during installation. Place the installation tube in the hole with the tab pointing towards the toe or line of play; this will assure that the number on the target faces the tee. The tab should be at, or slightly below grade level to keep it away from lawn mower blades and to establish the correct height for the target. Slide the target pole with locking collar attached into the installation tube. This will keep center out of the installation tube while pouring. Just one pole with locking collar can be used to set up the installation tubes for your entire course.
- Step 3 Pour the concrete into the hole around the installation tube to no higher than two inches below grade level. This will allow room for a padlock (not included). Use a level to plumb the pole on at least two sides 90° from each other. A torpedo level works best. After leveling the pole, make sure the tab still points toward the toe or line of play, clean off any concrete on the locking tab and then carefully remove the pole from the tube.

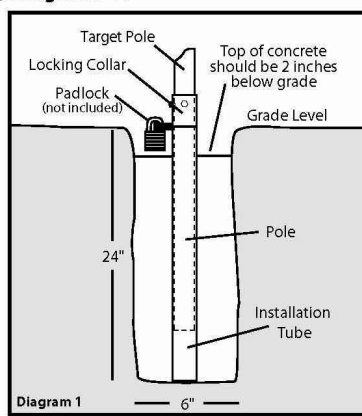

DISCatcher

The Soft Target

Parts (included per target):

- One Pole
- One Target Top (w/chains)
- One Basket
- One Locking Collar

Hardware (included per target):

- Three 1/4" x 3/8" hex bolts
- Two 1/4" x 3/8" one-way screws
- One 1/4" x 1/2" hex head bolt
- Three 1/4" lock nuts
- One 1/2" washer


Assembly Tools and Extras (not included):

- One padlock per target
- Two 1/2" and one 7/16" wrenches or sockets
- Flat head screwdriver (short)

STOP WAIT AT LEAST 24 HOURS AFTER POURING CONCRETE TO INSTALL ASSEMBLED TARGETS. You must be patient enough to let the concrete set thoroughly before putting the target in. This usually takes at least one day.

ASSEMBLING THE DISCATCHER® TARGET (Diagram 2)

The easier way to assemble the DISCatcher® Target is with the pole on the ground (the top of the main pole has mounting holes drilled within an inch of the end).

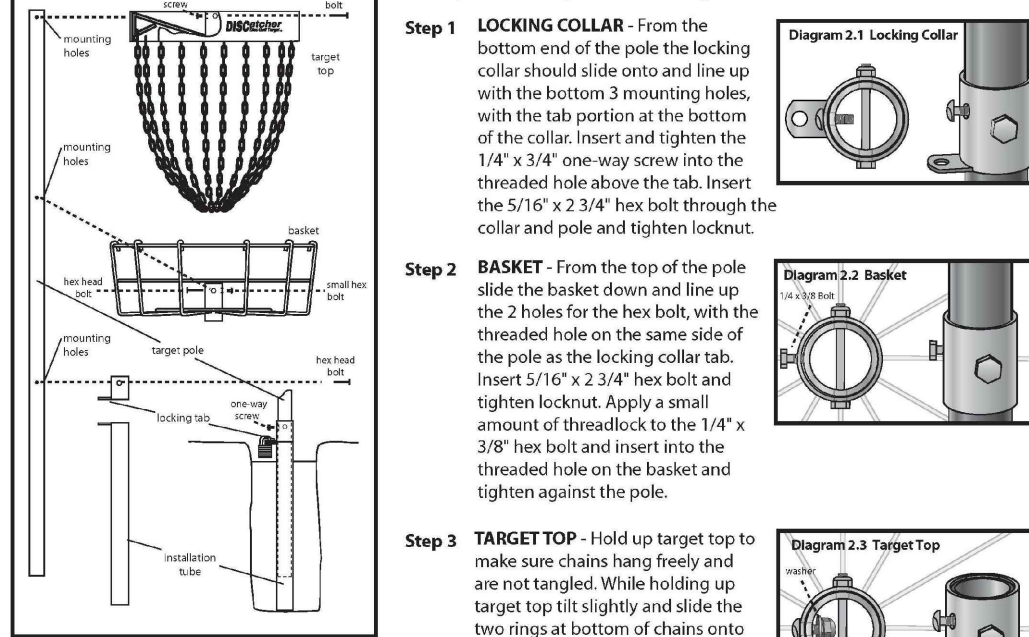

Step 1 LOCKING COLLAR: From the bottom end of the pole the locking collar should slide onto and line up with the bottom 3 mounting holes, with the tab portion at the bottom of the collar. Insert and tighten the 1/4" x 3/4" one-way screw into the threaded hole above the tab. Insert the 5/16" x 2 3/4" hex bolt through the collar and pole and tighten locknut.

Step 2 BASKET: From the top of the pole slide the basket down and line up the 2 holes for the hex bolt, with the threaded hole on the same side of the pole as the locking collar tab. Insert 5/16" x 2 3/4" hex bolt and tighten locknut. Apply a small amount of threadlock to the 1/4" x 3/8" hex bolt and insert into the threaded hole on the basket and tighten against the pole.

Step 3 TARGET TOP: Hold up target top to make sure chains hang freely and are not tangled. While holding up target top tilt slightly and slide the two rings at bottom of chains onto top of pole. Be careful not to let any chains cross between the top of the pole and the hole in the center of the target top, as you put the target top onto the pole. Line up the three holes on the target top with the top 3 holes on the pole. Insert and tighten 1/4" x 3/4" one-way screw into threaded hole on front of target top lining up with tab of locking collar. Start the 1/4" washer and locknut onto back of one-way screw. (Do not tighten) Insert 5/16" x 2 3/4" hex bolt through target top and pole. Tighten locknut. At this point tighten the 1/4" locknut onto one-way screw.



Still have questions? Give us a call.

West Coast Sales (800) 408-8449 900 S. Dupont Ave | Ontario, CA 91761
 East Coast Sales (800) 476-3968 2850 Commerce Drive | Rock Hill, SC 29730



Still have questions? Give us a call.


West Coast Sales (800) 408-8449 900 S. Dupont Ave | Ontario, CA 91761
 East Coast Sales (800) 476-3968 2850 Commerce Drive | Rock Hill, SC 29730

NOTES:
 1. DISC TARGET - DISCATCHER PRO 28 OR APPROVED EQUAL WITH NUMBER PLATE. DIRECT CONCRETE POLE MOUNT OPTION.

1 DISC GOLF TARGET


N.T.S.

NOTES:
 1. PATH EDGE TO BE FLUSH WITH OUTER GRADE
 2. CROWN PATH FOR DRAINAGE

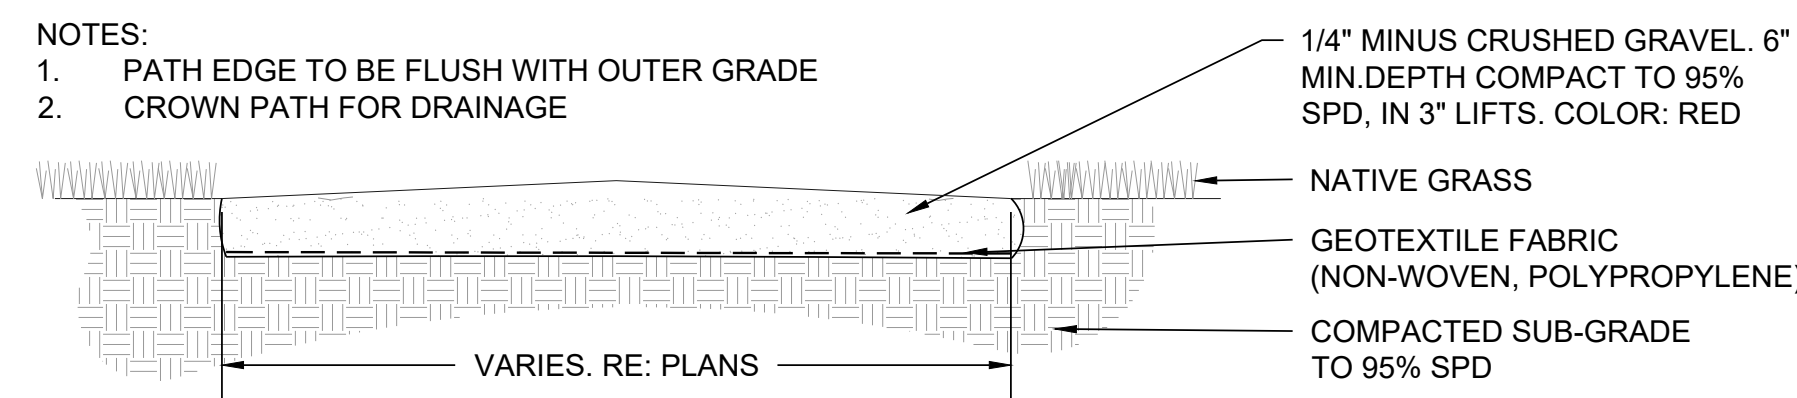


3 CRUSHER FINES PATH/PAD

N.T.S.

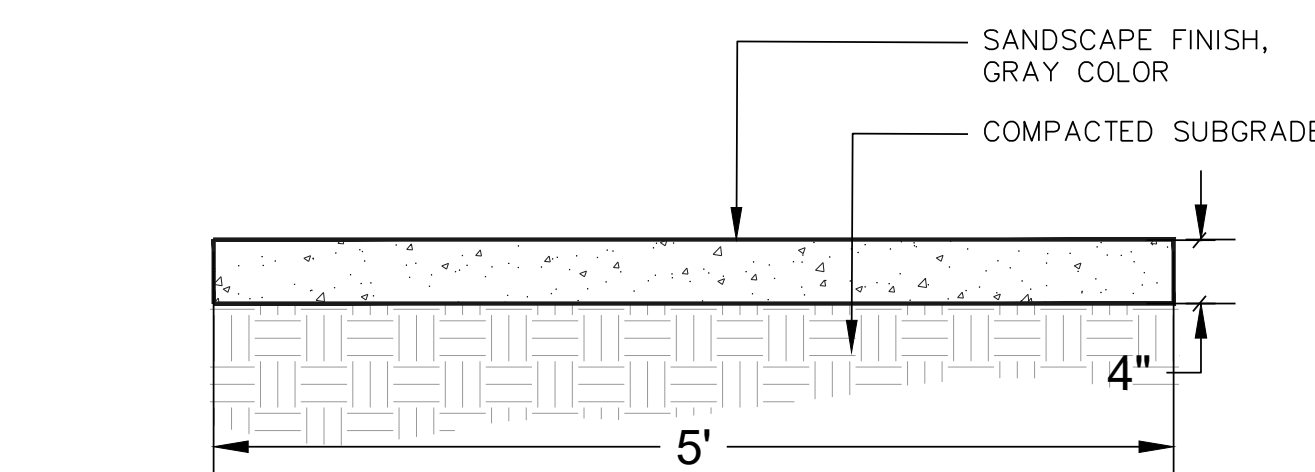

4 CONCRETE PAD

N.T.S.


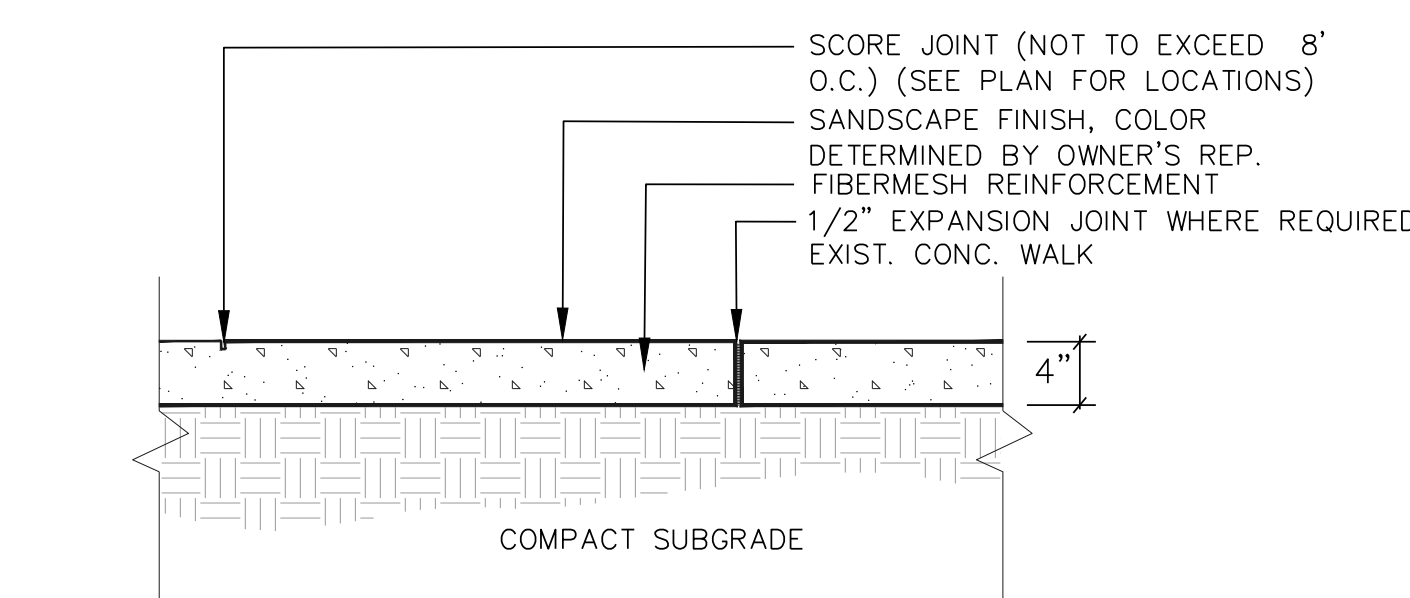


6 CONCRETE WALK

N.T.S.

6 SHADE STRUCTURE

N.T.S.

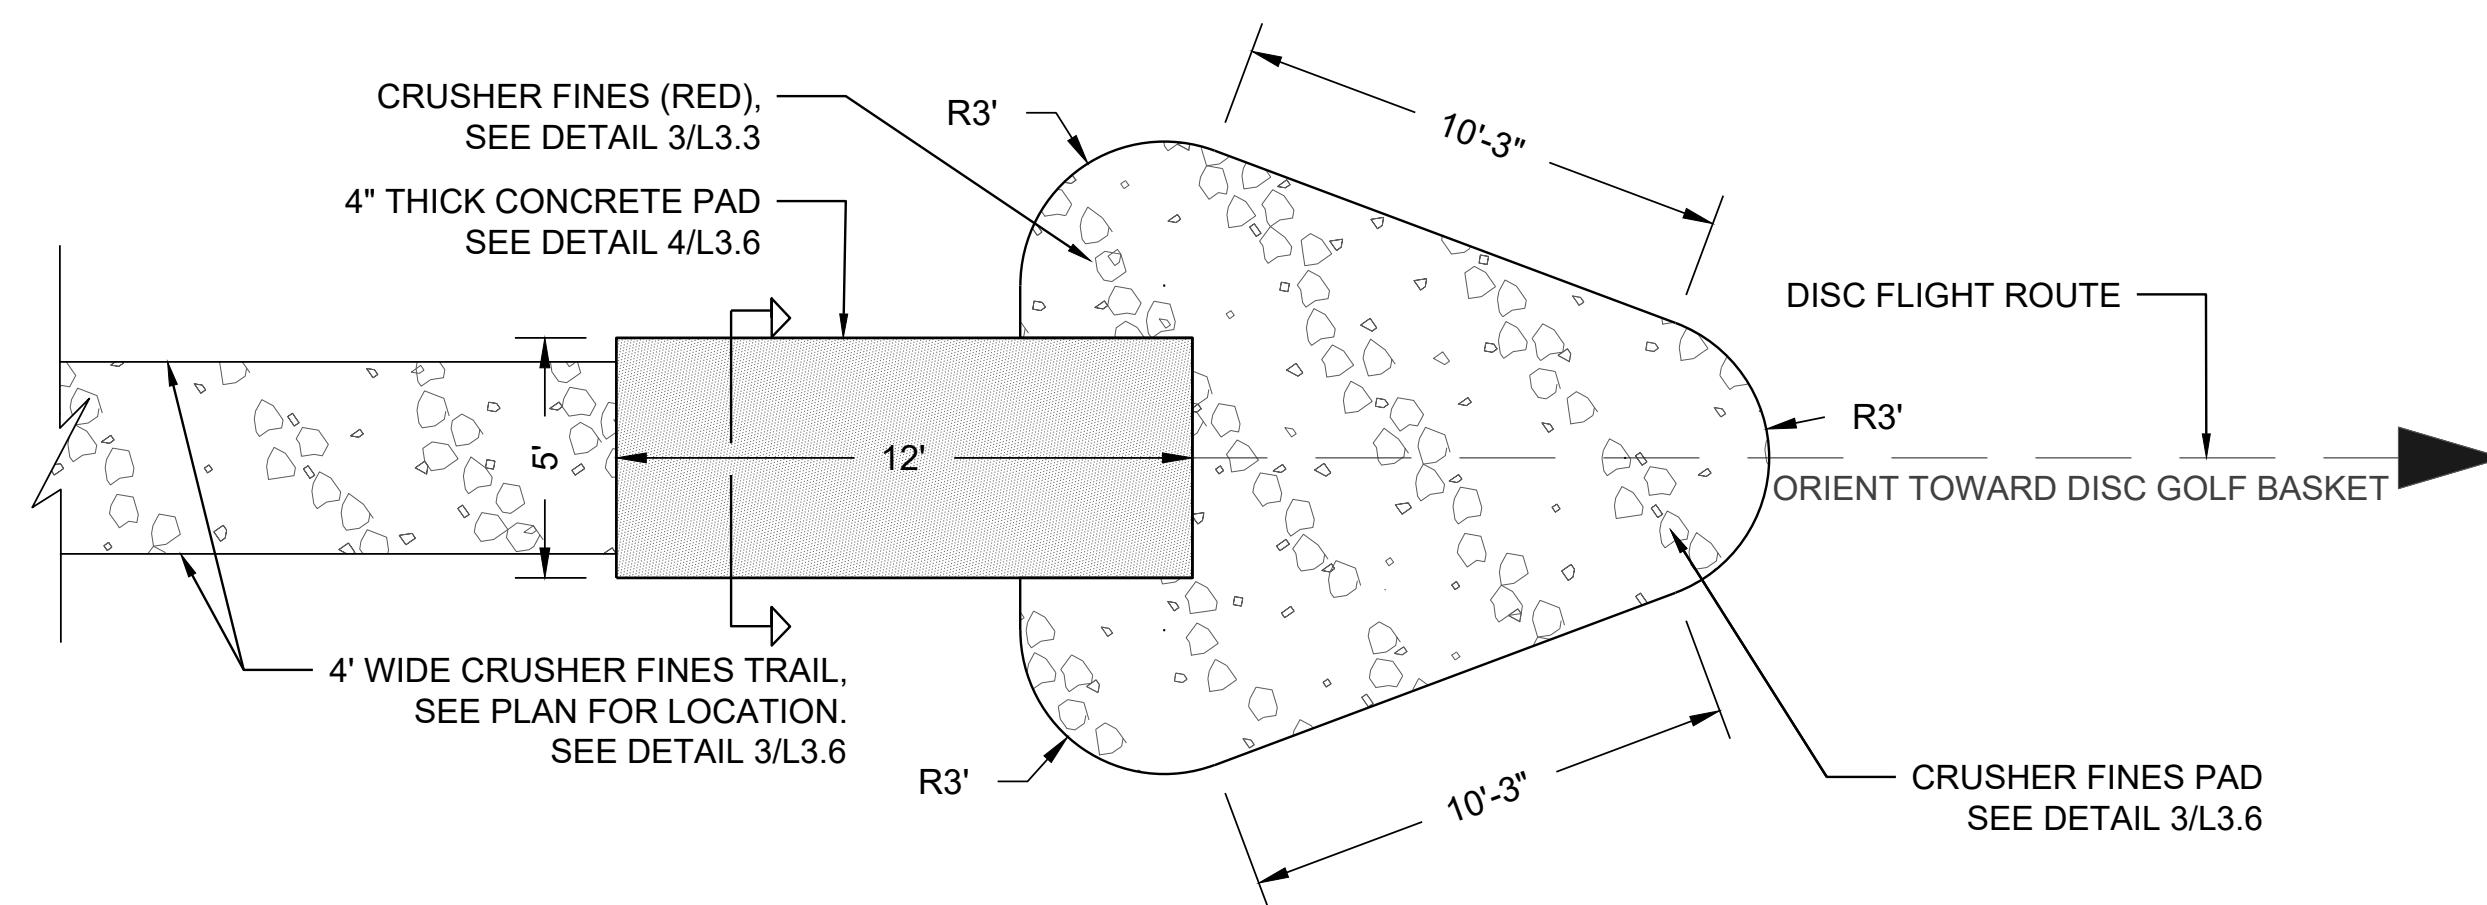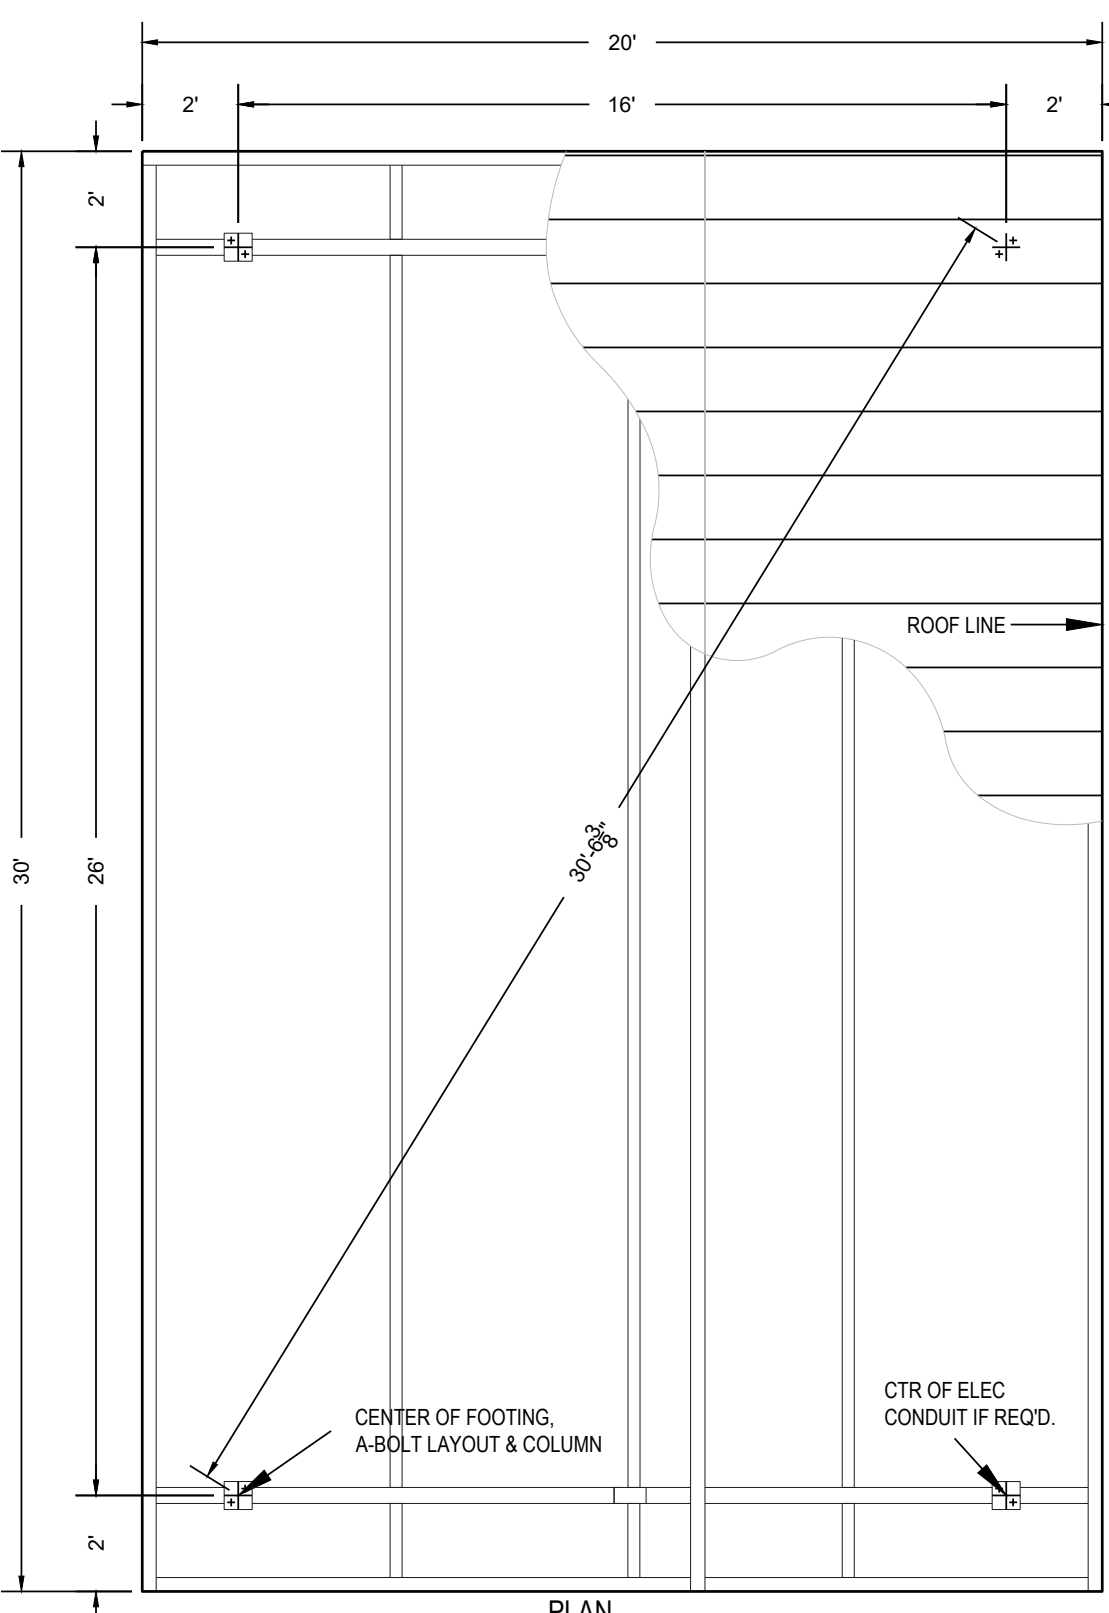


2 DISC GOLF TEE PAD

SCALE: 1/4" = 1'-0"

CRUSHER FINES TRAIL:
 • 6" THICKNESS
 • 1/4" MINUS CRUSHER FINES.
 • 6" MIN. DEPTH COMPACT TO 95% SPD, IN 3" LIFTS.
 • GEOTEXTILE FABRIC
 • GRAVEL TO BE FLUSH WITH TRAIL AND GRADE

CONCRETE TRAIL:
 • 6" THICKNESS
 • 4500 PSI CONCRETE.
 • MED. BROOM FINISH
 • NATURAL GRAY
 • MIN. 2% CROSS-SLOPE
 • MAX 5% LONGITUDINAL (MEET ADA STDS.)
 • SAW CUT JNTS. EQ. TO WALK WIDTH

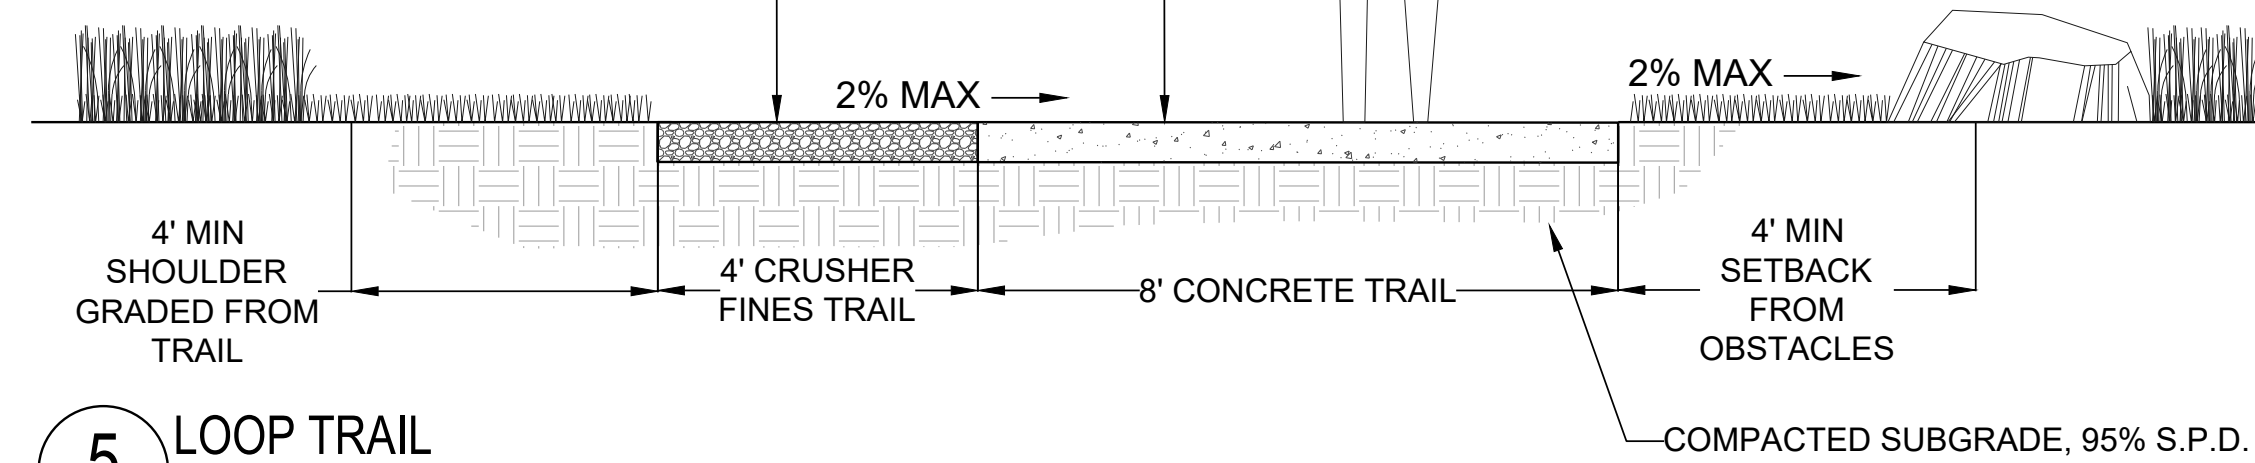

5 LOOP TRAIL



N.T.S.

TOWN OF PARKER ELECTRICAL NOTES:

1. SHELTER LIGHT FIXTURE TO BE: ARO PLUS TRANSIT, EVOLVE LED UNDERPASS FLOOD LIGHT - 2 REQUIRED IN STRUCTURE. INSTALL PER MANUFACTURERS SPECIFICATIONS. ALLOW 8 WEEK LEAD TIME.
2. CONTRACTOR SHALL COORDINATE WITH MANUFACTURER AND OWNER FOR INSTALLATION OF TWO EVOLVE LED UNDERPASS LIGHTS WITH A PHOTOVOLTIC SWITCH IN THE ROOF AND MINIMUM 2 OUTLET RECEPTACLES (4X4 GFI OUTLETS) MOUNTED ON EVERY OTHER POST.
3. ALL WIRES AND RACEWAYS TO BE HIDDEN WITHIN THE STRUCTURE. NO SURFACE MOUNTED INSTALLATIONS WILL BE ACCEPTED.
4. PROVIDE OPERATION AND MAINTENANCE MANUALS AND AS-BUILT DRAWINGS.
5. OUTLET BOXES SHALL BE NON-METALLIC.
6. ALL DEVICES SHALL BE 20 AMP SPECIFICATION GRADE WITH MATCHING COVER. BLACK IN COLOR. GFCI RECEPTACLES SHALL BE TERMINATION TYPE. WEATHERPROOF COVERS SHALL BE EQUAL TO HUBBELL #WP8M.
7. ALL DEVICES AND COVER PLATES SHALL BE FROM THE SAME MANUFACTURER
8. ALL WIRING SHALL BE RUN IN CONDUIT. DIRECT BURY CABLE SHALL NOT BE ALLOWED.

PAVILION

1. MANUF: CLASSIC RECREATION SYSTEMS MODEL(S): NORTHWEST, 30'X40'
2. COLORS: BEAMS/COLUMNS-MEDIUM BRONZE; METAL ROOF-Forest Green
3. ELECTRICAL: LIGHTING CONDUIT RACEWAY AND HANDHOLES WILL BE PROVIDED IN COLUMNS. CONTRACTOR TO COORDINATE WITH ELECTRICAL CONSULTANT AND SHELTER MANUFACTURER TO COORDINATE LIGHT FIXTURES WITHIN SHELTER, TOWN OF PARKER TO APPROVE FIXTURE LOCATION.
4. CONTRACTOR TO PROVIDE STRUCTURAL ENGINEERING AND SHALL SUBMIT ENGINEERS LETTER/DRAWINGS TO TOWN OF PARKER BUILDING DEPARTMENT FOR PAVILION PERMIT.
5. CONTRACTOR TO PROVIDE ENGINEERS LETTER OF CONSTRUCTION COMPLIANCE FOR IA TO TOWN OF PARKER.
6. CONTRACTOR TO PROVIDE ELECTRICAL AND SHOP DRAWINGS FOR REVIEW AND APPROVAL PRIOR TO INSTALLATION.
7. CONTRACTOR TO INSTALL STRUCTURE PER MANUFACTURER'S SPECIFICATIONS.

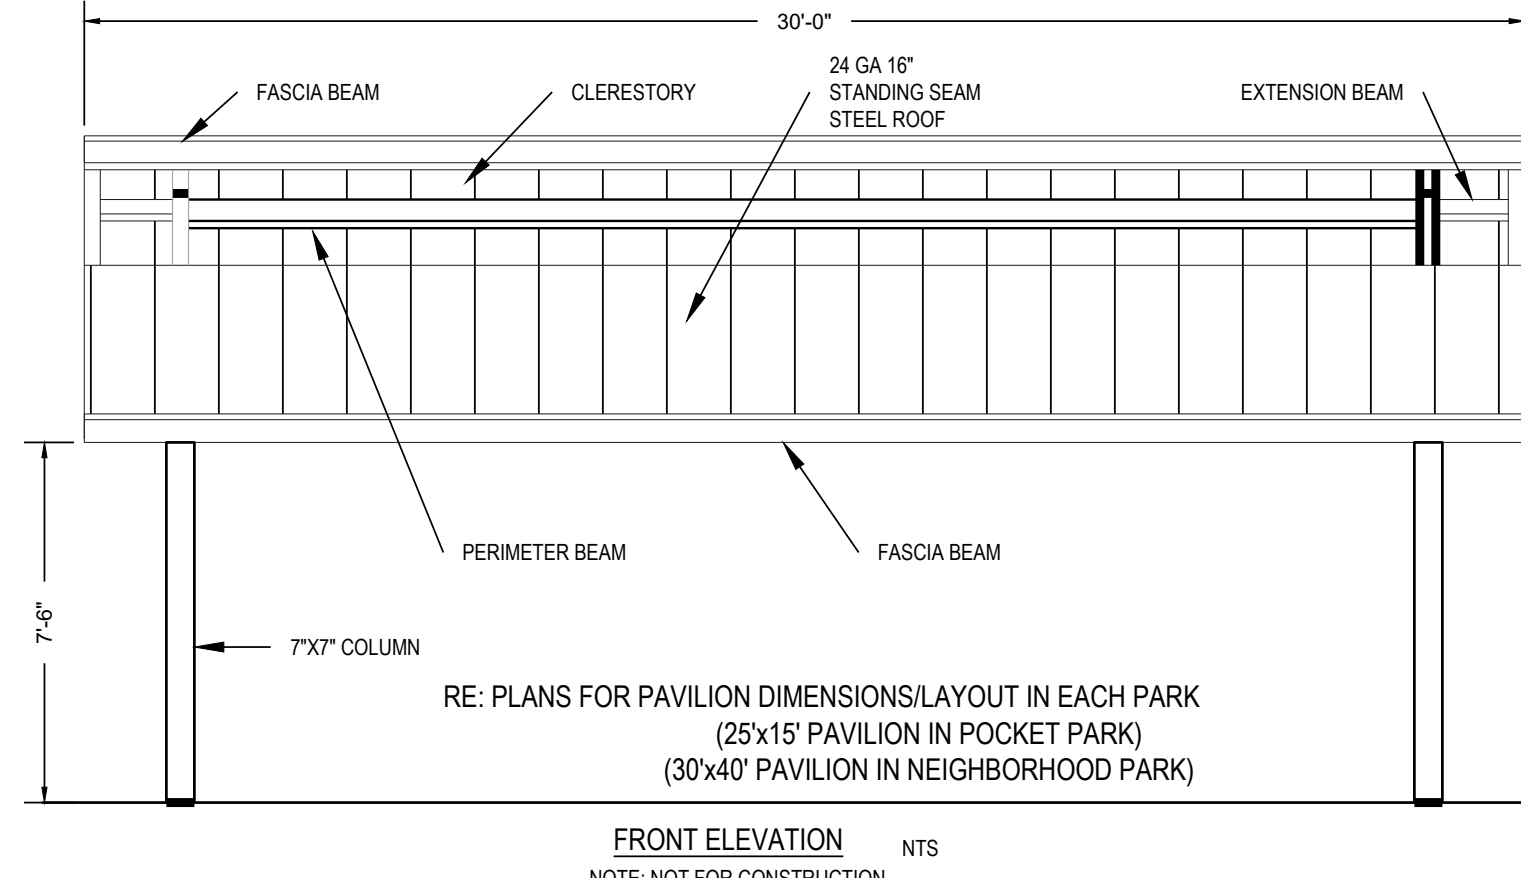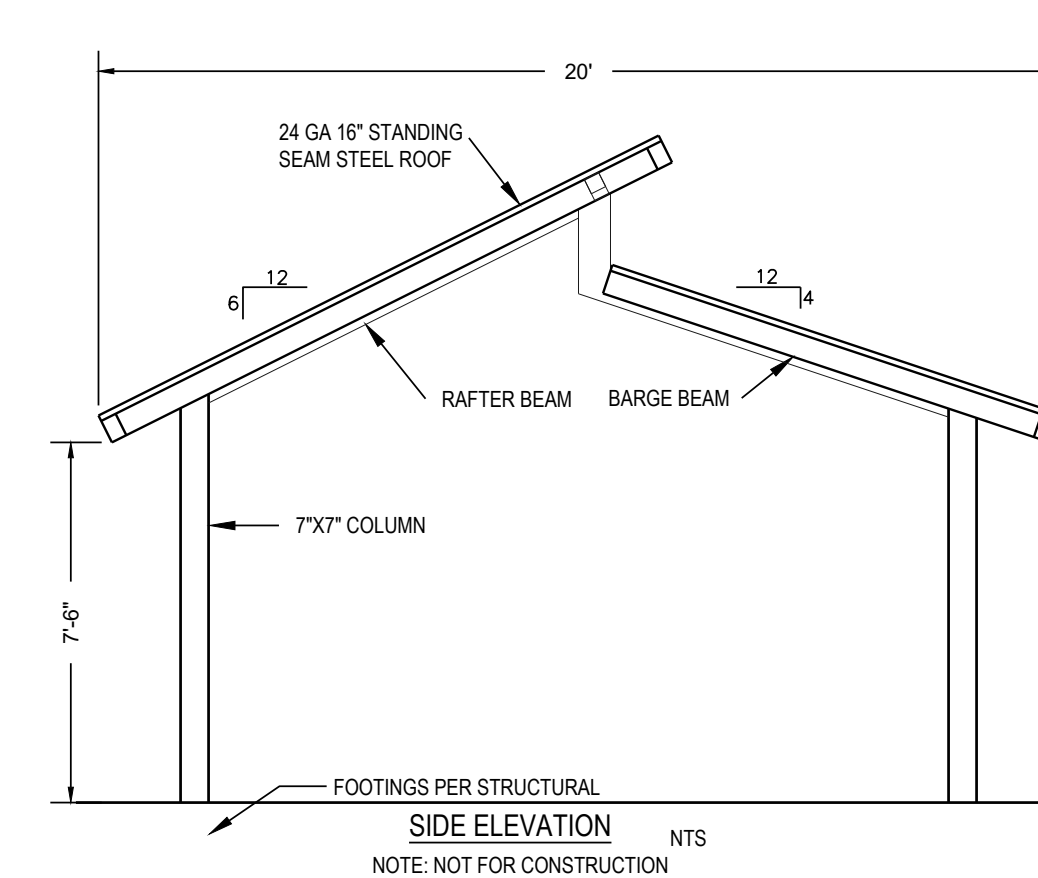

Prepared For

ESX MANAGEMENT
 7353 SOUTH ALTON WAY
 CENTENNIAL, CO 80112

Land Planning



pcs group inc. www.pcsgruopco.com
 #3, 8-180 Independence Plaza
 1007 14th Street - Denver, CO 80202
 1.303.531.4905 | 1.303.531.4908

Engineering



10333 E. DRY CREEK RD. #240
 ENGLEWOOD, CO 80112
 720-482-9526

TRAILS AT CROWFOOT
 PARK PLANS
 PARKER, COLORADO
 LANDSCAPE PLANS


Drawn by:	BEM, GS
Checked by:	PCS STAFF
Submittal Date:	08.01.2017
Date:	02.27.2018
Know what's below. Call before you dig.	08.20.2020
	10.19.2020
	11.23.2020
	03.16.2022

Sheet Name

LANDSCAPE DETAILS


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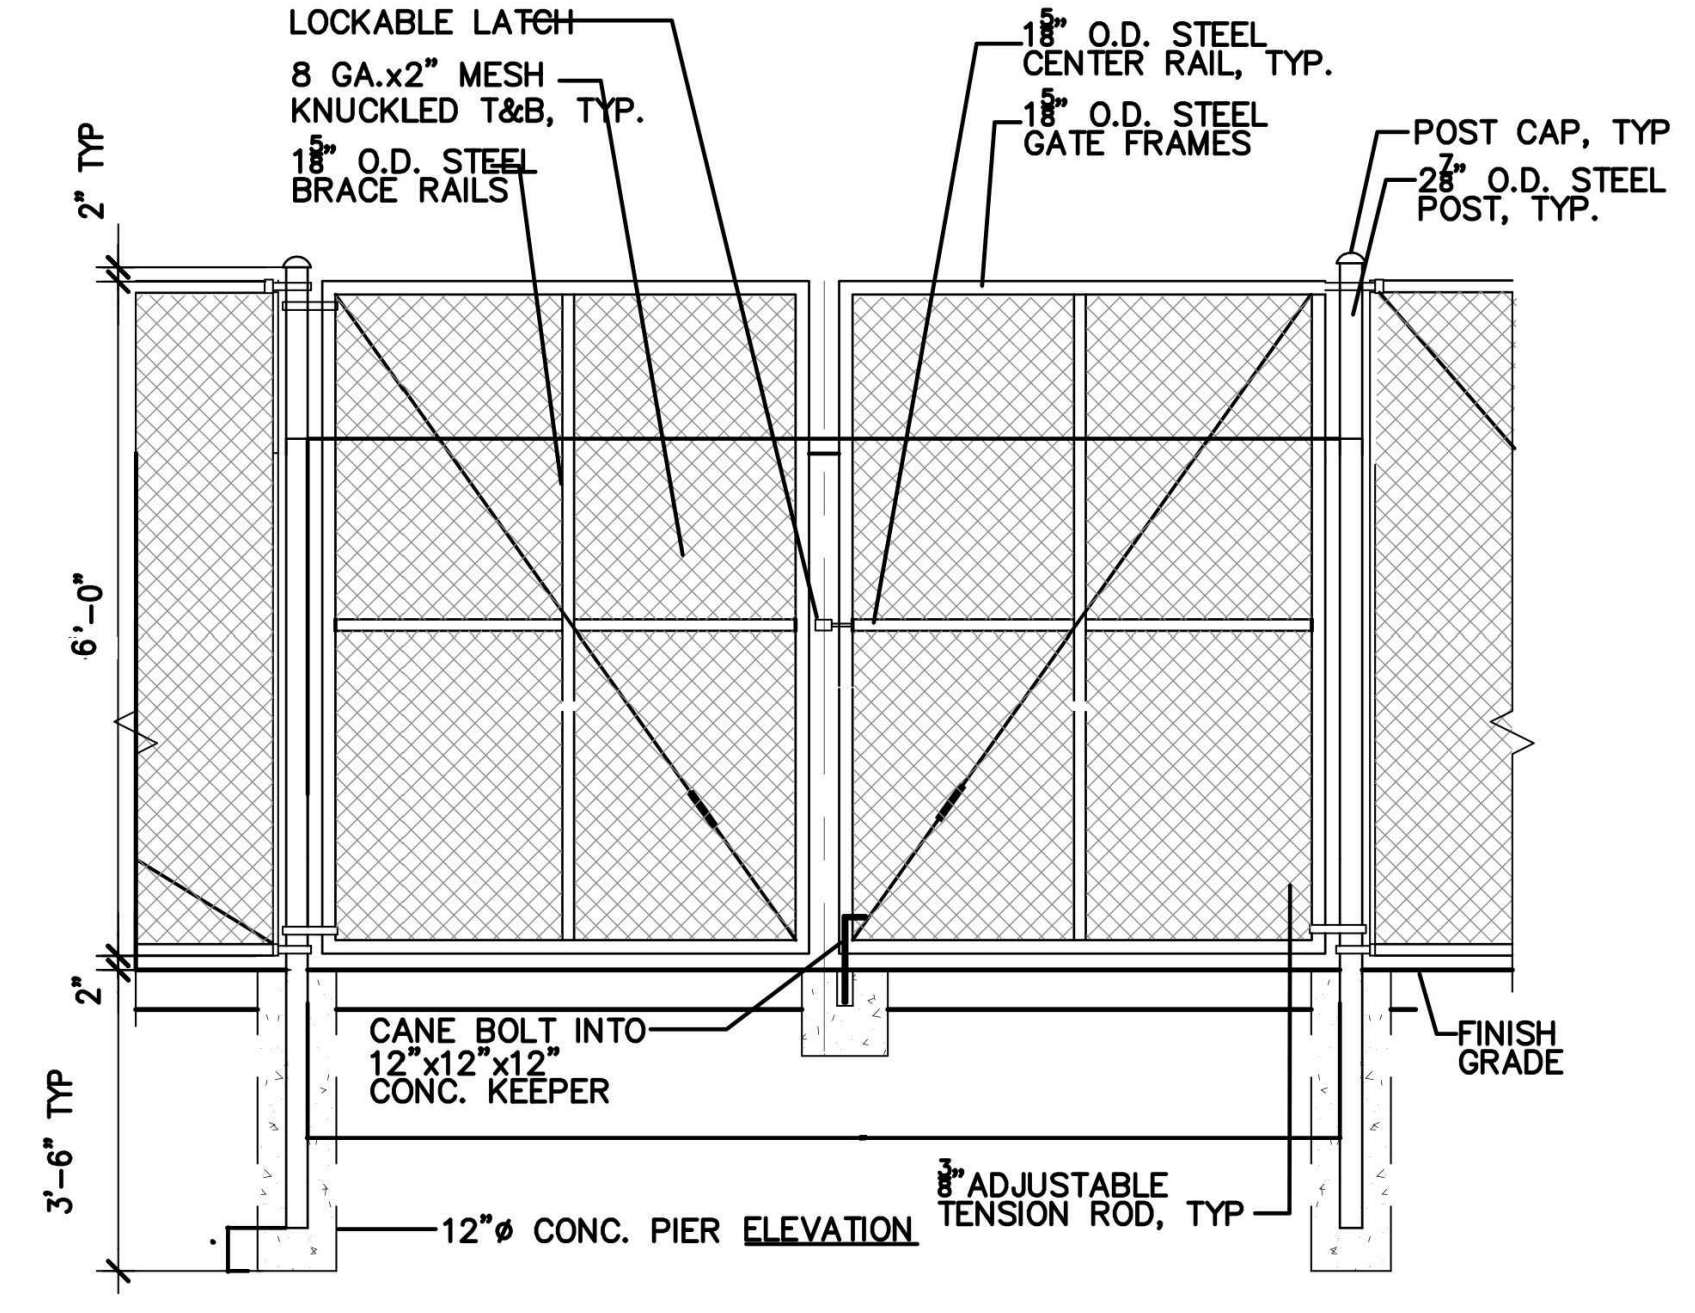
NOTES:
1. 125' OF YELLOW POLY CAP FENCE GUARD ON TOP RAIL (+ YELLOW FENCE TIES) BY BSN SPORTS OR APPROVED EQUIVALENT
2. FENCING TO BE A NON-PVC COATED FENCE

1 CHAINLINK FENCE NOT TO SCALE

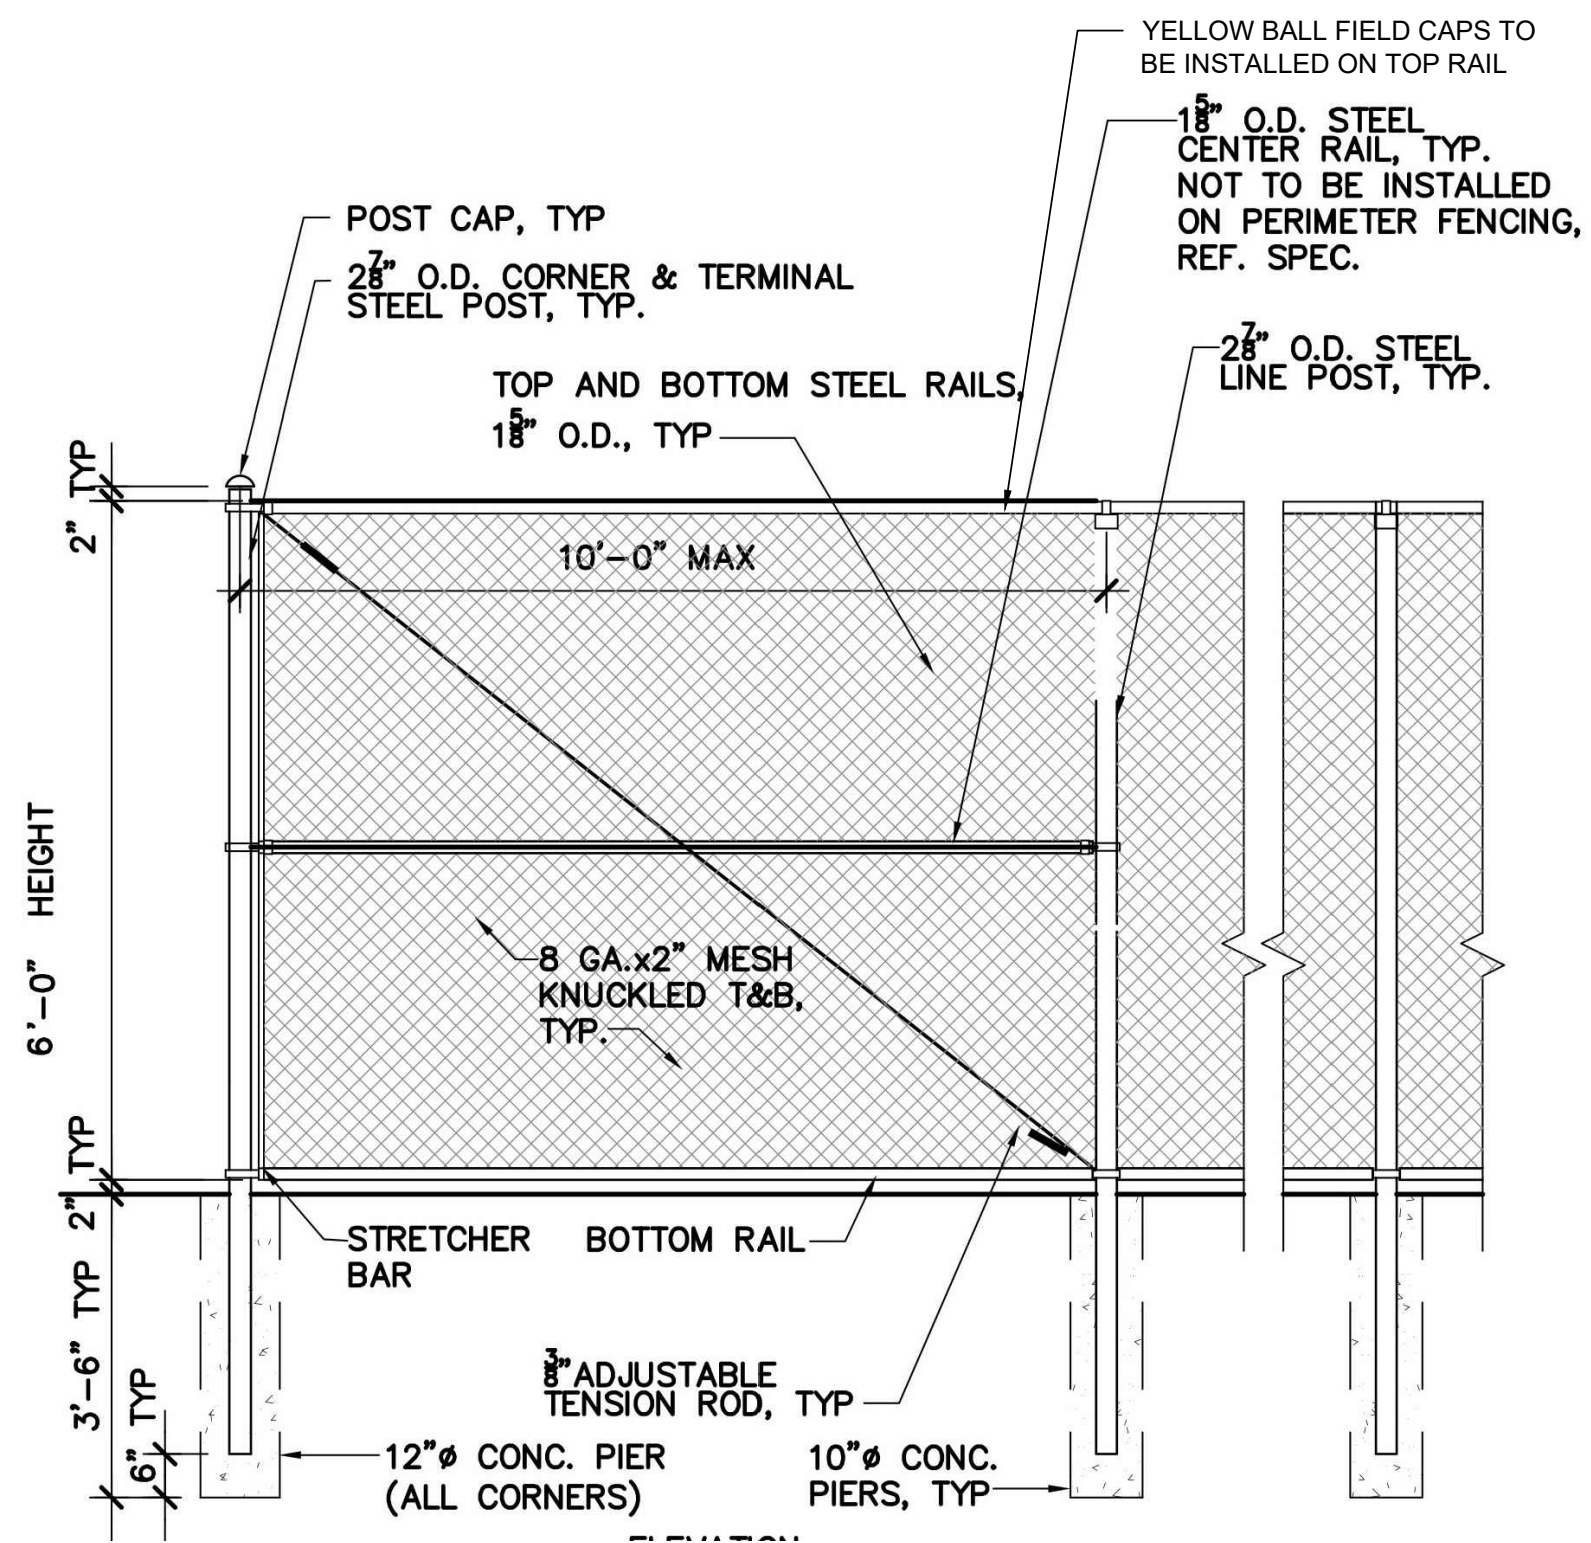

NOTES:
1. LOCK PROVIDED BY OWNER.

2 PEDESTRIAN GATE NOT TO SCALE

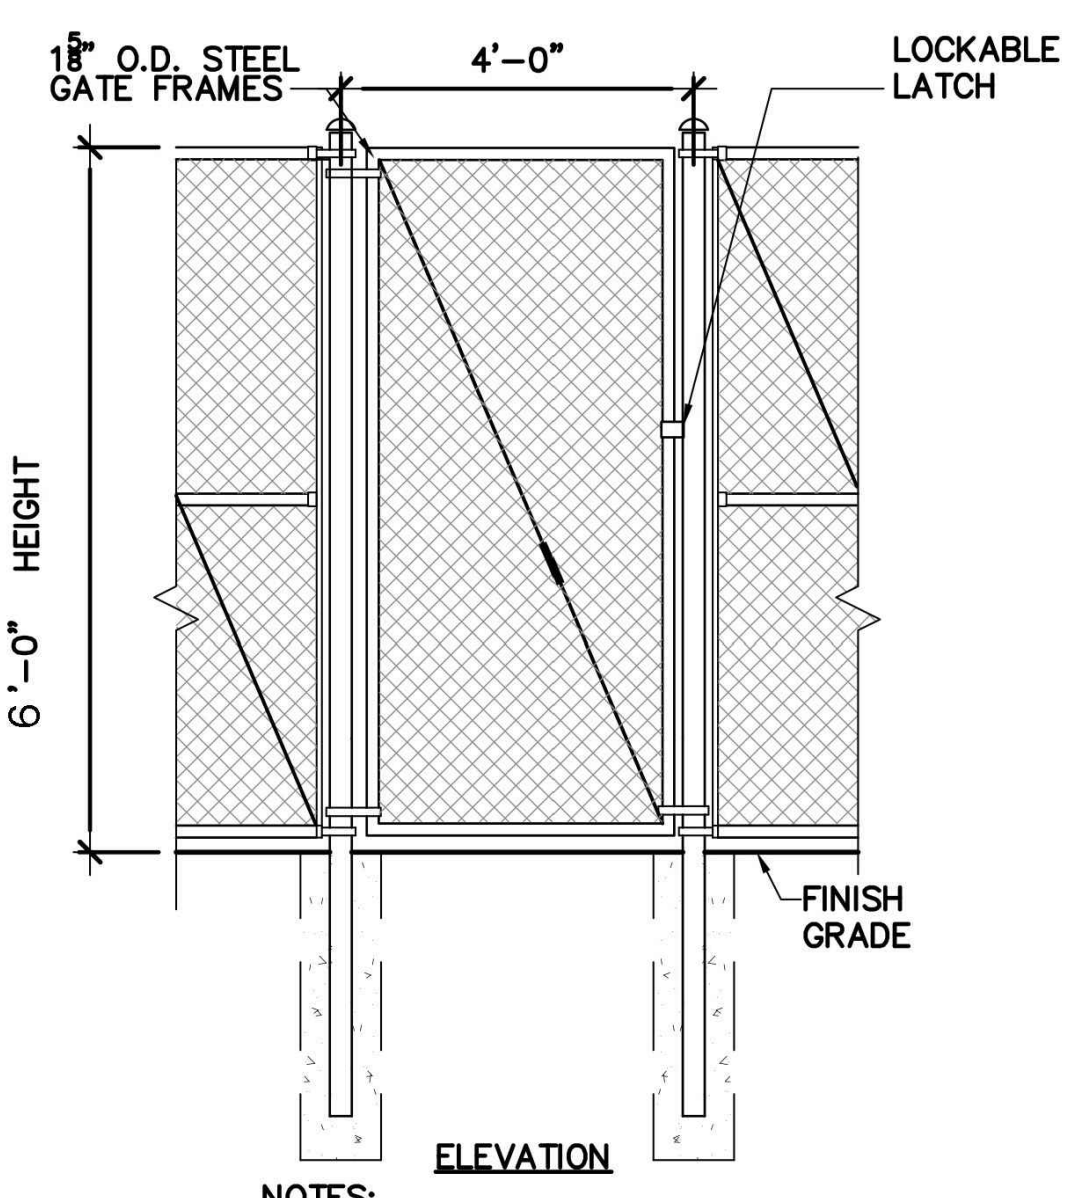


NOTES:
1. LOCK PROVIDED BY OWNER.

3 12' SERVICE GATE NOT TO SCALE

Permanent Hooded Backstop

MODEL #1230-00
FRONT HEIGHT: 17'-6" H; FRONT WIDTH: 34' WITH NO PLANKS (1475 LBS)

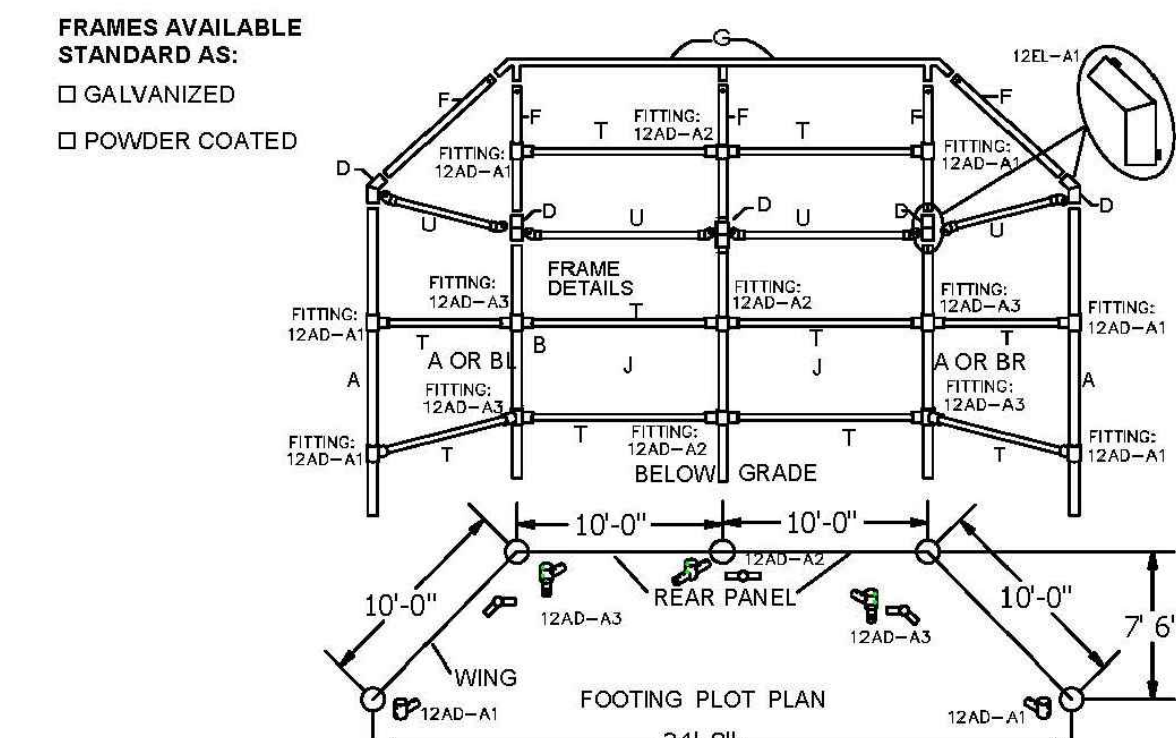

SPECIFICATIONS:

- Posts:** (A), (BL), (BR), and (F) are 2-3/8" O.D. galvanized steel.
- Rails:** (G) are 1-7/8" O.D. and (T) are 1-5/8" O.D. galvanized steel.
- Elbow Fittings:** Welded galvanized steel that fits 2-3/8" vertical and 2-3/8" hood supports.
- Chain Link Fabric:** 2" mesh galvanized after weaving; 9 ga on rear and side panels, 11 ga on hood.
- Hardware:** Tension bars and bands are galvanized steel. All fasteners are included.
- Finish:** All welds are ground smooth and treated with cold galvanizing compound. All fasteners are zinc plated for long rust-free service.
- Warranty:** 3 years

	Date: 11-06-07	SPECIFICATION/INSTALLATION INSTRUCTIONS
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MODEL NO. 1230-00		

GENERAL NOTES: Site must be level. Six 8" X 8" X 8" concrete blocks (half blocks) will be required in the bottom of holes to provide a means of post-height adjustment as well as to provide sufficient concrete footing below bottom of posts (See Page 3 & 4).

- Determine location of backstop so the rear panel is perpendicular to a line running from 2nd base through home plate and so the wings are parallel with the sides of the diamond.
- Dig holes according to footing plot plan and footing detail (See Page 3 & 4).
- Center a half concrete block (8" X 8" X 8") in the bottom of each of the holes per footing detail. Adjust height so the top of the block is 30" below finished grade (See Page 3).
- Start with an end post (Item A Page 4) and center the post in the hole so it rests on the block. Tops of posts for Model 1230 are to be 10' above finished grade. Adjust block height as necessary to achieve proper post height. Plumb and brace in position.
- Repeat the same procedure for the adjacent corner post (Item A, BL Or BR).
- Attach rail end caps to the horizontal rails (Item U). Insert 1-5/8" O.D. rails into rail end caps until fully seated. Drill through the end cap and the pipe with #25 drill bit provided. Hammer the #10 X 1/2" drive screws into holes until fully seated. Note: Keep rail end caps in line with each other.
- Attach two horizontal rails (Item T) between the two posts, one at the finished grade level and one midway up the posts. Attach with brace bands and carriage bolts provided (See Attachment Detail).
- Re-plumb posts and brace as necessary.
- Set the adjacent center post (Item A Or C) in the hole on the concrete block and brace or hold in place.
- Attach two horizontal rails (Item T) between the center post (Item A Or C) and the corner post (Item A or BL). Install as before one at finished grade level and one midway up the post with brace bands and carriage bolts provided.
- Re-plumb posts and brace as necessary.
- Repeat the same procedure for each adjacent post until all of the five vertical posts are installed. Attach horizontal rails between posts as before. Make sure the posts are plumb. Pour concrete into footing holes and let the concrete set for three days before removal of bracing and completion of installation.
- Slip the elbows for the upright posts (Item D) over the tops of the posts until seated. Using set screws, loosely tighten fitting in place.
- Insert the five hood supports (Item F) into the elbows.
- Align the hood supports by rotating the elbows. The hood supports on the corner and center posts (Items A Or BL, BR & C) should be rotated to face toward the infield and to be parallel to each other. The hood supports on the end posts (Item A) should be rotated so they are facing each other.
- Slip the top horizontal rail (Item G) into the hood supports. Adjust the hood supports as necessary and make sure welded sleeves on top rail are fully seated.
- Plumb frame and tighten all bolts.
- Attach the shorter horizontal rails (Item T) at the top of the vertical posts between the elbow fittings with the 2-7/8" brace bands and carriage bolts provided (See Attachment Detail).
- Install the horizontal rails (Item U) midway between the elbows and top rail. Tighten all bolts which secure all the horizontal rails.

Extremely Important
Dig footing holes according to layout & assemble post and rails with supplied pipe fittings. Do not pour concrete until entire frame is assembled.

	Date: 11-06-07	SPECIFICATION/INSTALLATION INSTRUCTIONS
	Rev: 022613	
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MODEL NO. 1230-00		


Mesh Installation: Separate the wire mesh as the heavier material (9 gauge) is to be used along the rear panel and the wings while the lighter material (11 gauge) is to be used on the hood. The mesh is cut to approximate size and shipped in rolls.

- Cut four pieces of (9-gauge X 10 ft mesh) 10 ft long to be installed between the vertical posts of the rear panel and the wings. Attach each piece of mesh using one 10 ft tension bar on each side of the mesh along with tension bands and bolts provided. Use tension bands on 18 to 20 inch centers. The mesh must be tight, remove one or two strands as necessary to achieve proper tension (See Attachment Detail).
- Secure the mesh to the top, center and bottom horizontal rails with tie wires every 12 inches (See Attachment Detail).
- The mesh will overlap the top planks. Install the drilled tension bar in the mesh about 3" to 6" from the top edge of the highest plank. Pull tight and drill 5/16" diameter holes through the planks using the holes in the tension bar for drilling location. Secure with 5/16" x 2-1/2" carriage bolts, flat washers, lock washers and nuts. Note: This will keep the baseballs from falling behind planks.
- Cut one piece of (11ga X 10 ft mesh) 20 ft long. Attach the mesh to the rear panel using one tension bar on each end of the piece along with tension bands and hardware provided. Tension bands should be used on 18 to 20 inch centers. The mesh must be tight, remove strands as necessary to achieve proper tension.
- Secure the mesh to the top, center and bottom horizontal rails of the hood supports with 7-inch tie wires every 12 inches (See Attachment Detail).
- Cut a 10 ft long piece of 11ga mesh into a triangle to cover the remainder of the hooded area. Use the hood as a template.
- Install two 10 ft. tension bars in each triangular mesh piece along the two edges where the wire ends are NOT twisted together (knuckled salvage edge). Attach the mesh in the corners of the hood so the edge of mesh without tension bar is along the horizontal rail. Use tension bands on 18 to 20 inch centers to secure to the hood supports (Item F). The mesh must be tight; remove one or two strands as necessary to achieve proper tension.
- Pull the bottoms of each triangular mesh piece tight and secure with 7-inch lengths of tie wire every 8 inches to the horizontal rails.
- Inspect for loose hardware and tighten as necessary. Also look for sharp wires and either cut or turn back into the fabric as necessary.
- At every mating location (Elbows & Top Rail) drill through with 7/32" drill bit and hammer 1/4" x 1" drive screws into holes until seated.
- Replace turf to cover exposed tops of footings (See Typical Footing Detail).

NOTE:
Footing: Footing sizes are based on average soil conditions. Loose and/or sandy soil is not average and footing sizes must be increased accordingly to meet local soil conditions.



	Date: 11-06-07	SPECIFICATION/INSTALLATION INSTRUCTIONS
	Rev: A121412	
	Drawn: AMC	
	Sheet: 3 of 4	
MODEL NO. 1230-00		

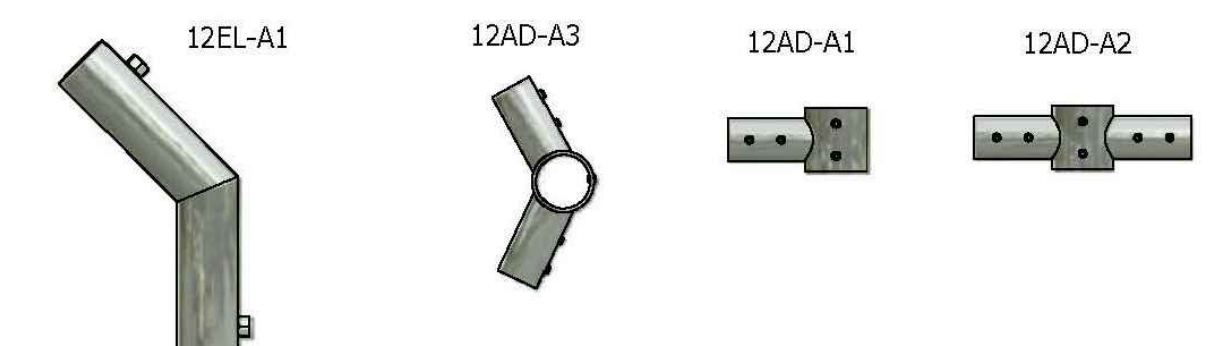




Description	Qty
Upright Post (A,B) 2-3/8" x 12' 8"	5
Hood Support (F) 2-3/8" x 8' 7"	5
Top Horiz. Rail Assembly 1-7/8" (G)	1
Horizontal Rails 1-5/8" x 9' 7" (T)	10
Horizontal Rails 1-5/8" x 9' 4" (U)	4
2" X 11 Gauge X 10' Wire Mesh (H)	40
2" X 9 Gauge X 10' Wire Mesh (I)	40
Tension Bar - 10'	14
Hardware Kit	1
INSTALLS	1
FITTING 12AD-A1 (2-7/8" O.D.)	6
FITTING 12AD-A2 (2-7/8" O.D.)	3
FITTING 12AD-A3 (2-7/8" O.D.)	4
ELBOW 12EL-A1 (2-7/8" O.D.)	5

Component Description	Qty
Tension Band (2-3/8")	90
Brace Band (2-7/8")	8
Brace Band (2-3/8")	20
Rail End (1-5/8")	9
5/16" x 1" Carriage Bolt	124
5/16"-18 Hex Nut	124
5/16"-18 Flat Washer	124
#10 X 1/2" Rd. Hd. Drive Screw	30
#25 drill bit	2
1/4" X 1" Rd. Hd. Drive Screw	40
7/32" Drill Bit	2
1/2" Gauge Tie Wire (lbs)	3
3/8"-16 x 3/8" Set Screws	60
5/8" x 3/4" Set Screws	10

	Date: 11-06-07	SPECIFICATION/INSTALLATION INSTRUCTIONS
	Rev: 022613	
	Drawn: AMC	
	Sheet: 4 of 4	
MODEL NO. 1230-00		

NOTE: BACKSTOP BOARDS TO BE INSTALLED ON FRONT SIDE OF BACKSTOP. BACKSTOP BOARDS TO BE PROVIDED BY AMERICAN-PLASTILUMBER OR APPROVED EQUIVALENT. 2"X12"X120'. 3 ROWS. PREMIUM RECYCLED LUMBER COLOR:TAN

4 BACKSTOP NOT TO SCALE

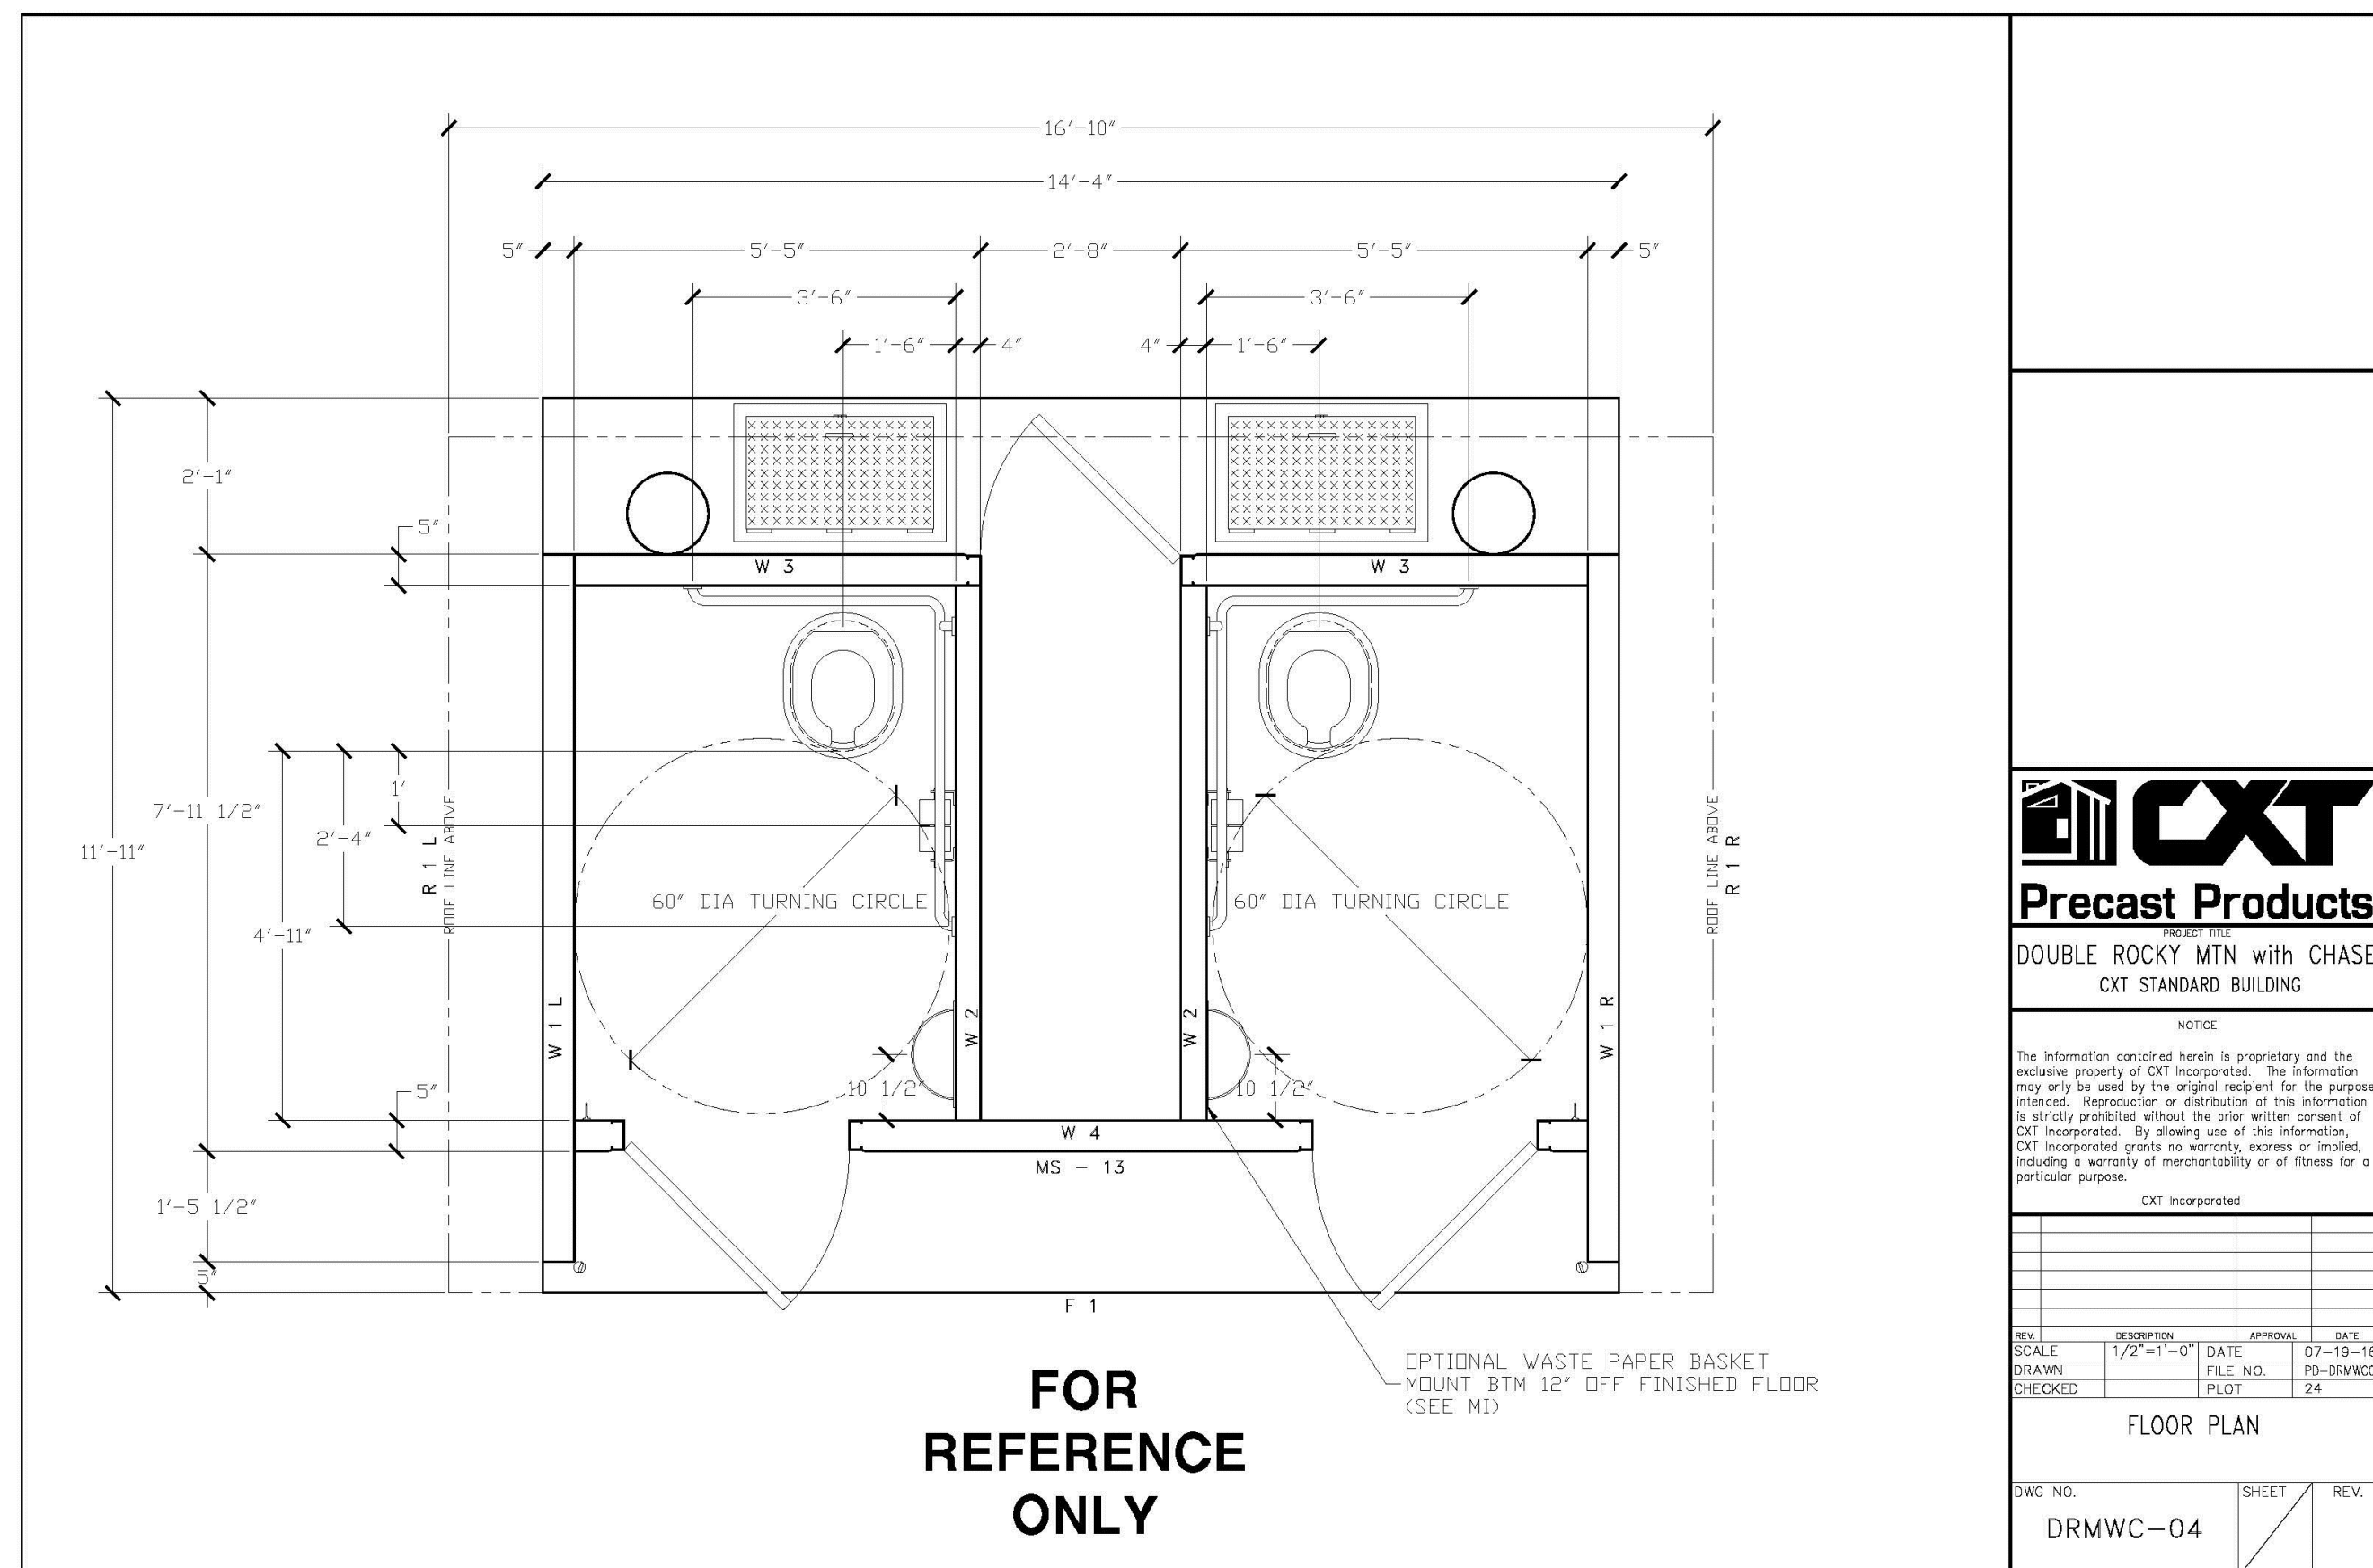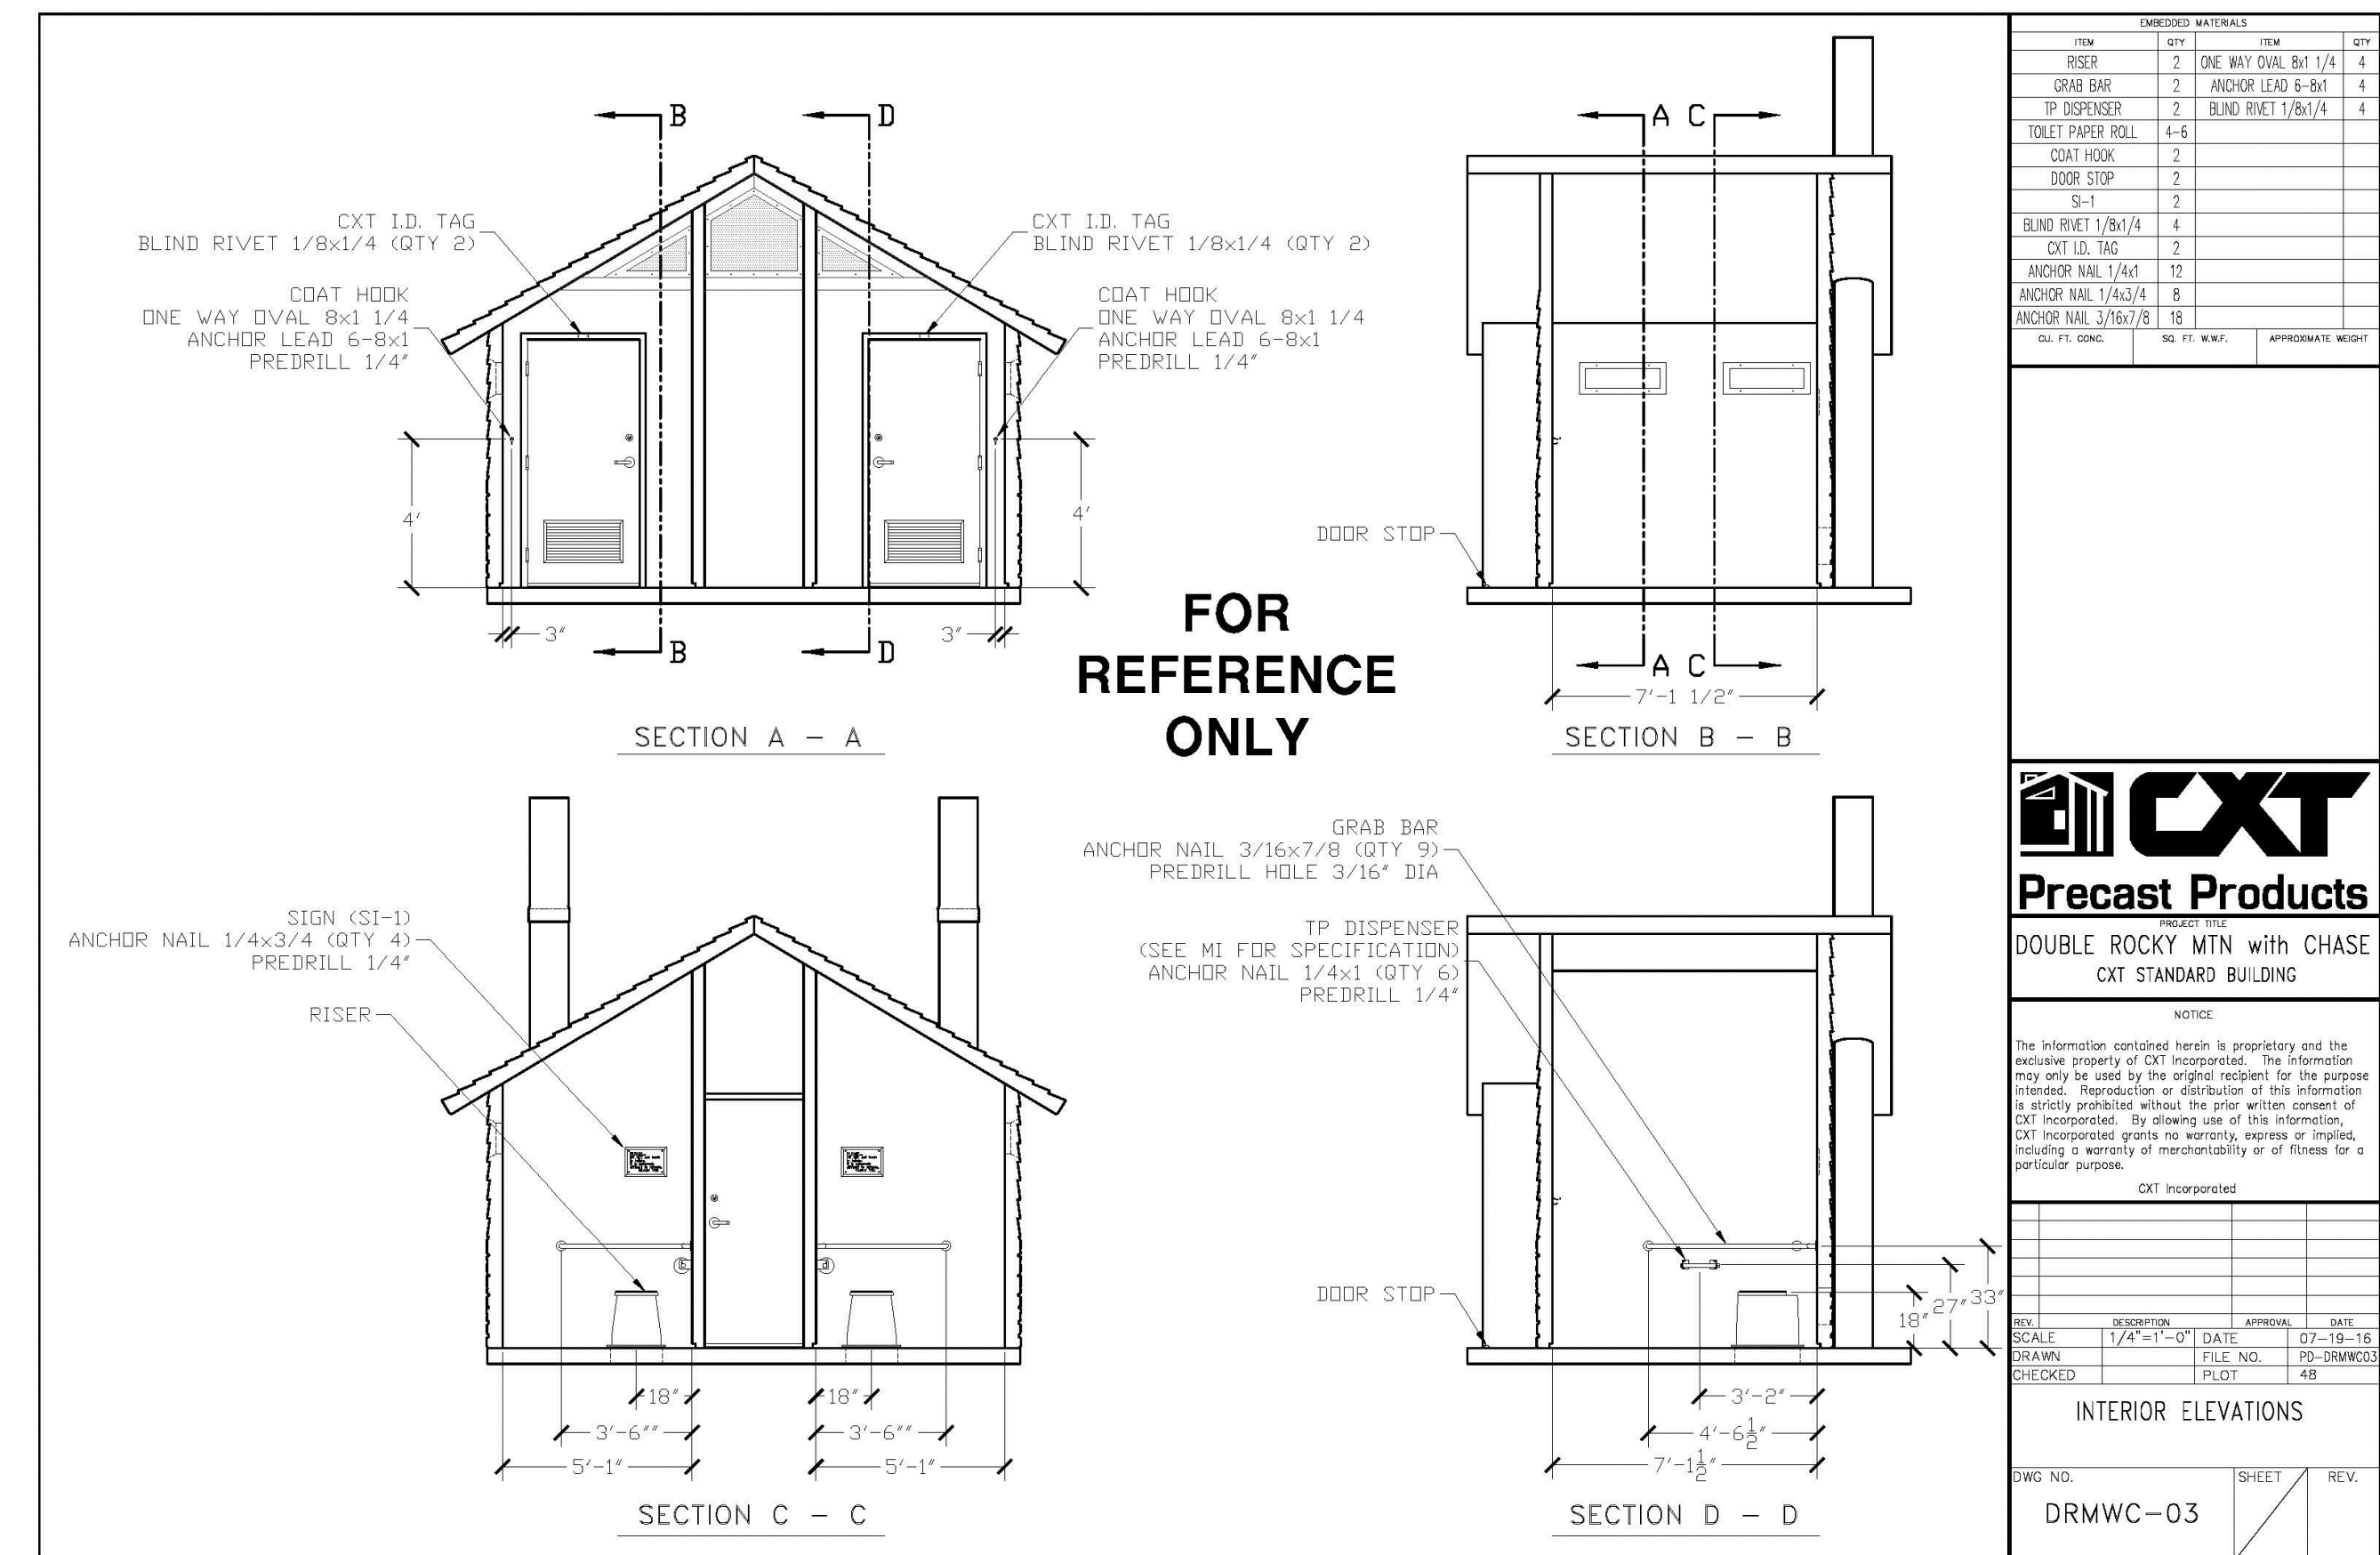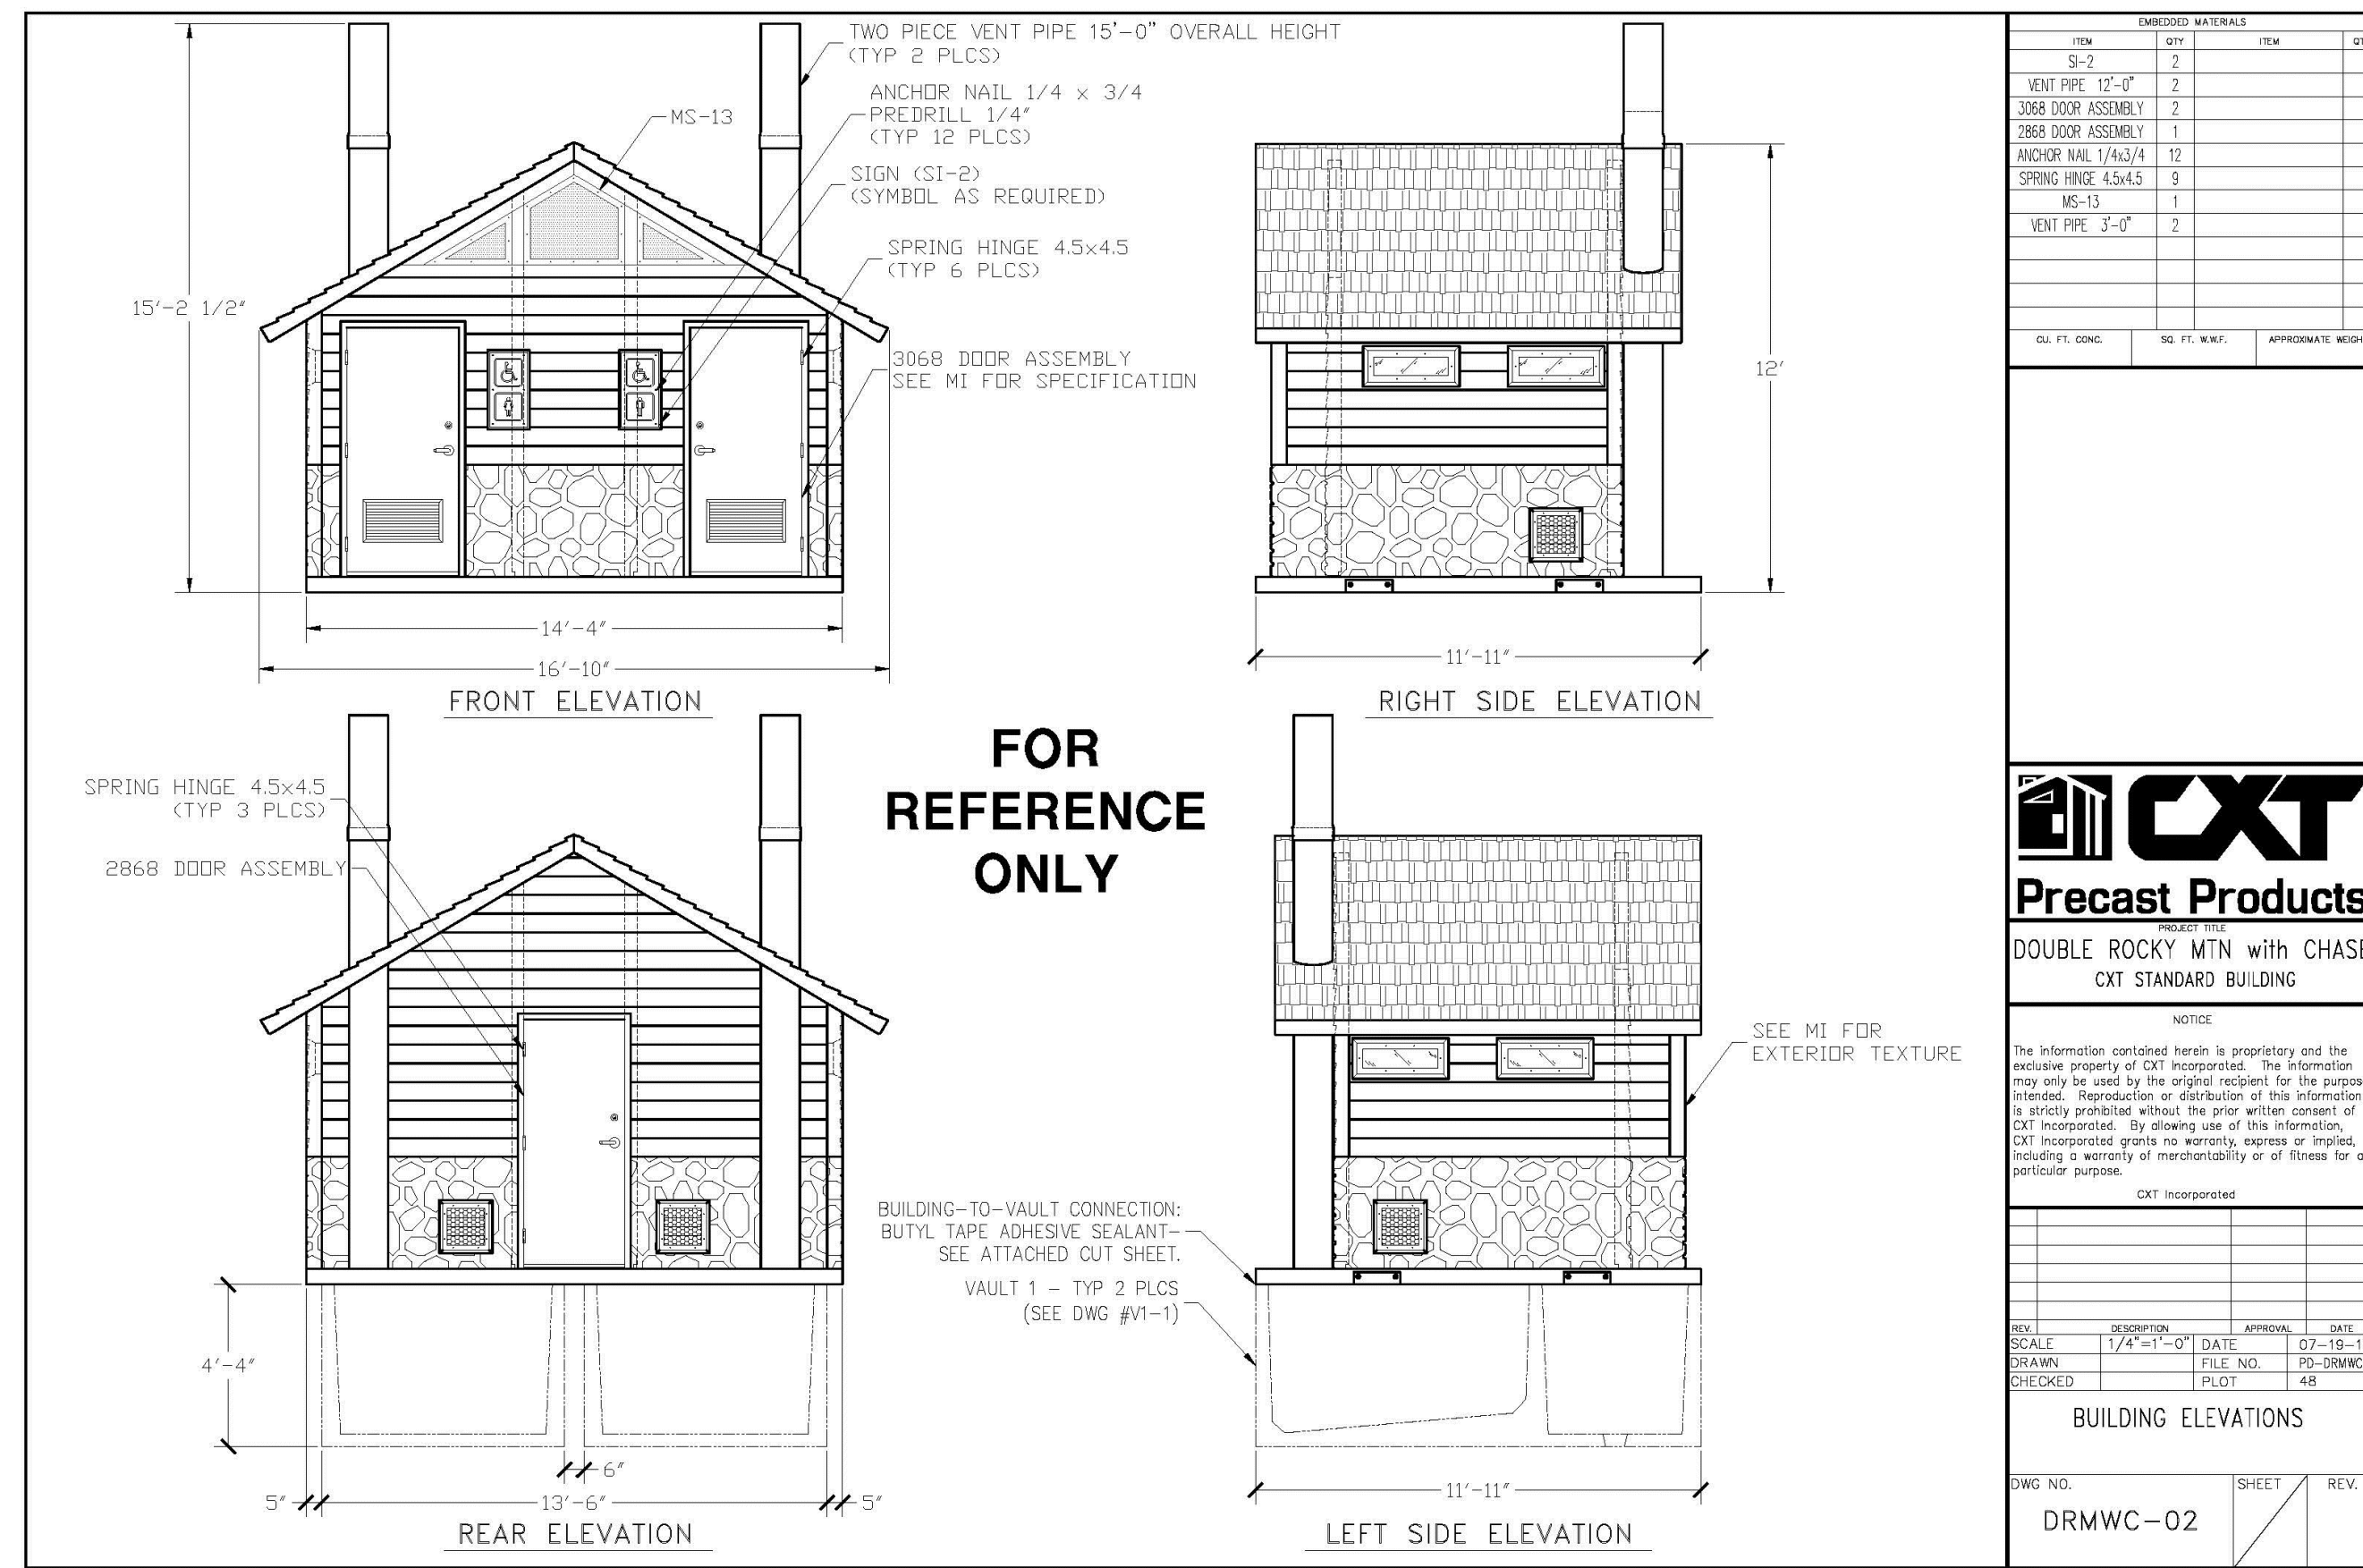

CXT-PRECAST DOUBLE VAULT RESTROOM
DOUBLE ROCKY MOUNTAIN RESTROOM WITH CHASE, TWO 1,000 GALLON WASTE VAULTS
BOARD & BAT CHARCOL GRAY ON UPPER HALF AND NAP VALLEY NATURAL GREY STONE WALL ON LOWER HALF
CONTACT NUMBER:(541) 496-3541
INSTALL PER MANUFACTURERS RECOMMENDATIONS


MANUFACTURER: BEACON ATHLETICS
ITEM #: 120-405-029
ROOF FRAME: PAINTED NAVY BLUE
SIZE: 20' LENGTH X 10' DEPTH
CONTACT NUMBER:(800) 747-5985
INSTALL PER MANUFACTURERS RECOMMENDATIONS



MANUFACTURER: BEACON ATHLETICS
ITEM #: 115-765-139
FINISH: PAINTED NAVY BLUE
SIZE: 15' LENGTH X 10" DEPTH
MOUNT: SURFACE
CONTACT NUMBER:(800) 747-5985
INSTALL PER MANUFACTURERS RECOMMENDATIONS

1 DOUBLE VAULTED TOILET NOT TO SCALE

2 DUGOUT & BENCHES NOT TO SCALE

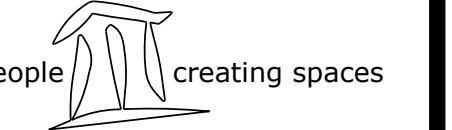

TRAILS AT CROWFOOT
PARK PLANS
PARKER, COLORADO
LANDSCAPE PLANS

Drawn by:	BEM, GS
Checked by:	PCS STAFF
Submittal Date:	08.01.2017
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IRRIGATION SCHEDULE


SYMBOL	MANUFACTURER/MODEL/DESCRIPTION	PSI
	RAIN BIRD 1806-SAM-PR5 15 STRIP SERIES TURF SPRAY 6.0" POP-UP SPRINKLER WITH CO-MOLDED WIPER SEAL. 1/2" NPT FEMALE THREADED INLET. WITH SEAL-A-MATIC CHECK VALVE, AND PRESSURE REGULATING.	30
	RAIN BIRD 1806-SAM-PR5 8 SERIES MPR TURF SPRAY 6.0" POP-UP SPRINKLER WITH CO-MOLDED WIPER SEAL. 1/2" NPT FEMALE THREADED INLET. WITH SEAL-A-MATIC CHECK VALVE, AND PRESSURE REGULATING.	30
	RAIN BIRD 1806-SAM-PR5 10 SERIES MPR TURF SPRAY 6.0" POP-UP SPRINKLER WITH CO-MOLDED WIPER SEAL. 1/2" NPT FEMALE THREADED INLET. WITH SEAL-A-MATIC CHECK VALVE, AND PRESSURE REGULATING.	30
	RAIN BIRD 1806-SAM-PR5 12 SERIES MPR TURF SPRAY 6.0" POP-UP SPRINKLER WITH CO-MOLDED WIPER SEAL. 1/2" NPT FEMALE THREADED INLET. WITH SEAL-A-MATIC CHECK VALVE, AND PRESSURE REGULATING.	30
	RAIN BIRD 1806-SAM-PR5 15 SERIES MPR TURF SPRAY 6.0" POP-UP SPRINKLER WITH CO-MOLDED WIPER SEAL. 1/2" NPT FEMALE THREADED INLET. WITH SEAL-A-MATIC CHECK VALVE, AND PRESSURE REGULATING.	30
	HUNTER MP1000 WRAINBIRD 1806-SAM-P45 BODY TURF SPRAY 6.0" POP-UP SPRINKLER WITH CO-MOLDED WIPER SEAL. 1/2" NPT FEMALE THREADED INLET. WITH SEAL-A-MATIC CHECK VALVE, AND PRESSURE REGULATING. HUNTER MP ROTATOR NOZZLE ON RB 1806-SAM-PR45 BODY (REGULATED TO 45 PSI). M=MAROON ADJ ARC 90 TO 210, L=LIGHT BLUE 210 TO 270 ARC, O=OLIVE 360 ARC.	40
	HUNTER MP2000 WRAINBIRD 1806-SAM-P45 BODY TURF SPRAY 6.0" POP-UP SPRINKLER WITH CO-MOLDED WIPER SEAL. 1/2" NPT FEMALE THREADED INLET. WITH SEAL-A-MATIC CHECK VALVE, AND PRESSURE REGULATING. HUNTER MP ROTATOR NOZZLE ON RB 1806-SAM-PR45 BODY (REGULATED TO 45 PSI). K=BLACK ADJ ARC 90-210, G=GREEN ADJ ARC 210-270, R=RED 360 ARC.	40
	HUNTER MP3000 WRAINBIRD 1806-SAM-P45 BODY TURF SPRAY 6.0" POP-UP SPRINKLER WITH CO-MOLDED WIPER SEAL. 1/2" NPT FEMALE THREADED INLET. WITH SEAL-A-MATIC CHECK VALVE, AND PRESSURE REGULATING. HUNTER MP ROTATOR NOZZLE ON RB 1806-SAM-PR45 BODY (REGULATED TO 45 PSI). B=BLUE ADJ ARC 90-210, Y=YELLOW ADJ ARC 210-270, A=GRAY 360 ARC.	40
	HUNTER MP3500 WRAINBIRD 1806-SAM-P45 BODY TURF SPRAY 6.0" POP-UP SPRINKLER WITH CO-MOLDED WIPER SEAL. 1/2" NPT FEMALE THREADED INLET. WITH SEAL-A-MATIC CHECK VALVE, AND PRESSURE REGULATING. HUNTER MP ROTATOR NOZZLE ON RB 1806-SAM-PR45 BODY (REGULATED TO 45 PSI). LB=LIGHT BROWN ADJUSTABLE ARC, 90-210.	40
	HUNTER MP800SR WRAINBIRD 1806-SAM-P45 BODY TURF SPRAY 6.0" POP-UP SPRINKLER WITH CO-MOLDED WIPER SEAL. 1/2" NPT FEMALE THREADED INLET. WITH SEAL-A-MATIC CHECK VALVE, AND PRESSURE REGULATING. HUNTER MP ROTATOR NOZZLE ON RB 1806-SAM-PR45 BODY (REGULATED TO 45 PSI). ADJ=ORANGE AND GRAY (ARC 90-210), 360=LIME GREEN AND GRAY (ARC 360)	40
	HUNTER MP CORNER W/ RAIN BIRD 1806-SAM-P45 BODY TURF SPRAY 6.0" POP-UP SPRINKLER WITH CO-MOLDED WIPER SEAL. 1/2" NPT FEMALE THREADED INLET. WITH SEAL-A-MATIC CHECK VALVE, AND PRESSURE REGULATING. HUNTER MP ROTATOR NOZZLE ON RB 1806-SAM-PR45 BODY (REGULATED TO 45 PSI). T=TURQUOISE ADJ ARC 45-105.	40
	HUNTER MP STRIP W/ RAIN BIRD 1806-SAM-P45 BODY TURF SPRAY 6.0" POP-UP SPRINKLER WITH CO-MOLDED WIPER SEAL. 1/2" NPT FEMALE THREADED INLET. WITH SEAL-A-MATIC CHECK VALVE, AND PRESSURE REGULATING. HUNTER MP ROTATOR NOZZLE ON RB 1806-SAM-PR45 BODY (REGULATED TO 45 PSI). LST=IVORY LEFT STRIP, SST=BROWN SIDE STRIP, RST=COPPER RIGHT STRIP.	40

IRRIGATION SCHEDULE

SYMBOL	MANUFACTURER/MODEL/DESCRIPTION	PSI	GPM	RADIUS
	HUNTER I-20-06-55 TURF ROTOR, 6.0" POP-UP. ADJUSTABLE AND FULL CIRCLE. STAINLESS STEEL RISER. DRAIN CHECK VALVE. STANDARD NOZZLE.	45	1.50	31'
	HUNTER I-20-06-55 TURF ROTOR, 6.0" POP-UP. ADJUSTABLE AND FULL CIRCLE. STAINLESS STEEL RISER. DRAIN CHECK VALVE. STANDARD NOZZLE.	45	2.00	34'
	HUNTER I-20-06-55 TURF ROTOR, 6.0" POP-UP. ADJUSTABLE AND FULL CIRCLE. STAINLESS STEEL RISER. DRAIN CHECK VALVE. STANDARD NOZZLE.	45	3.00	38'
	HUNTER I-20-06-55 TURF ROTOR, 6.0" POP-UP. ADJUSTABLE AND FULL CIRCLE. STAINLESS STEEL RISER. DRAIN CHECK VALVE. STANDARD NOZZLE.	45	4.00	40'
	HUNTER I-20-06-55 TURF ROTOR, 6.0" POP-UP. ADJUSTABLE AND FULL CIRCLE. STAINLESS STEEL RISER. DRAIN CHECK VALVE. STANDARD NOZZLE.	45	6.00	43'
	HUNTER I-40-06-55 TURF ROTOR, 6.0" POP-UP. ADJUSTABLE TO FULL CIRCLE. DRAIN CHECK VALVE, STAINLESS STEEL RISER, 1" FEMALE NPT INLET THREADS, STANDARD NOZZLE.	50	8.40	45'
	HUNTER I-40-06-55 TURF ROTOR, 6.0" POP-UP. ADJUSTABLE TO FULL CIRCLE. DRAIN CHECK VALVE, STAINLESS STEEL RISER, 1" FEMALE NPT INLET THREADS, STANDARD NOZZLE.	50	10.3	49'
	HUNTER I-40-06-55 TURF ROTOR, 6.0" POP-UP. ADJUSTABLE TO FULL CIRCLE. DRAIN CHECK VALVE, STAINLESS STEEL RISER, 1" FEMALE NPT INLET THREADS, STANDARD NOZZLE.	50	11.1	50'
	HUNTER I-40-06-55 TURF ROTOR, 6.0" POP-UP. ADJUSTABLE TO FULL CIRCLE. DRAIN CHECK VALVE, STAINLESS STEEL RISER, 1" FEMALE NPT INLET THREADS, STANDARD NOZZLE.	50	13.8	54'
	HUNTER I-40-04-55-ON TURF ROTOR, 4.0" POP-UP, FULL CIRCLE, DRAIN CHECK VALVE, STAINLESS STEEL RISER, 1" FEMALE NPT INLET THREADS, DUAL OPPOSING NOZZLE.	50	13.0	52'



TEMPORARY IRRIGATION SCHEDULE

SYMBOL	MANUFACTURER/MODEL/DESCRIPTION	PSI	GPM	RADIUS
	HUNTER I-40-04-55-ON TURF ROTOR, 4.0" POP-UP, FULL CIRCLE. DRAIN CHECK VALVE, STAINLESS STEEL RISER, 1" FEMALE NPT INLET THREADS, DUAL OPPOSING NOZZLE.	50	13.0	52'
	TEMPORARY IRRIGATION LATERAL LINE: TO BE INSTALLED ABOVE GRADE PVC CLASS 200 IRRIGATION PIPE. ONLY LATERAL TRANSITION PIPE SIZES 1 1/4" AND ABOVE ARE INDICATED ON THE PLAN, WITH ALL OTHERS BEING 1" IN SIZE.			
	TEMPORARY IRRIGATION MAINLINE: TO BE INSTALLED ABOVE GRADE PVC CLASS 200 SDR 21. 2.5-INCH UNLESS OTHERWISE NOTED.			
	PIPE SLEEVE: PVC SCHEDULE 40 INSTALL AS SHOWN ON DESIGN OR TWICE THE SIZE OF THE PIPE OR WIRE RUNNING THRU IT. NO TWO PIPES OR WIRE BUNDLES SHALL SHARE THE SAME SLEEVE.			

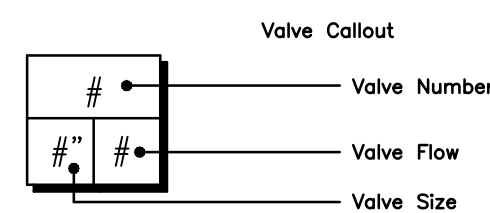

IRRIGATION SCHEDULE

SYMBOL	MANUFACTURER/MODEL/DESCRIPTION
	DRIP VALVE ASSEMBLY HIGH FLOW VALVE NETAFIM MODEL LVCZ58010075-HF, PRE-ASSEMBLED CONTROL ZONE KIT, WITH 1" SERIES 80 CONTROL VALVE, 3/4" DISC FILTER, AND HIGH FLOW PRESSURE REGULATOR 4.5GPM TO 17.6GPM.
	DRIP VALVE ASSEMBLY LOW FLOW VALVE NETAFIM MODEL LVCZ58010075-LF PRE-ASSEMBLED CONTROL ZONE KIT, WITH 1" SERIES 80 CONTROL VALVE, 3/4" DISC FILTER, AND LOW FLOW PRESSURE REGULATOR 0.25GPM TO 4.4GPM.
	PIPE TRANSITION POINT IN DRIP BOX PIPE TRANSITION POINT FROM PVC LATERAL TO DRIP TUBING WITH RISER IN 6" BOX.
	DRIFLINE FLUSH CAP AGRIFIM FLUSH CAP. 3/4" DRIFLINE COMPRESSION END CAP WITH SCREW ON END.
	INLINE DRIP INDICATOR HEAD NETAFIM TLAVRV: AIR/VACUUM RELIEF VALVE, 1/2" MALE PIPE THREAD. INSTALL ON RAINBIRD 1806 SPRINKLER BODY PER DETAILS.
	AREA TO RECEIVE DRIFLINE NETAFIM TLHCVR3-12 (18): TECHLINE HCVR PRESSURE COMPENSATING LANDSCAPE DRIFLINE WITH CHECK VALVE AND ANTI-SIPHON FEATURE. 0.33GPH EMITTERS AT 12.0" O.C. DRIFLINE LATERALS SPACED AT 18.0" APART, WITH EMITTERS OFFSET FOR TRIANGULAR PATTERN. 17MM.
	REMOTE CONTROL VALVE ASSEMBLY RAIN BIRD EFB-CP-PR5-D: 1", 1-1/2", 2" BRASS REMOTE CONTROL VALVE, THAT IS CONTAMINATION PROOF W/SELF-FLUSHING FILTER SCREEN. GLOBE CONFIGURATION, RECLAIMED WATER COMPATIBLE
	RAIN BIRD 44-RC 1" BRASS QUICK-COUPLING VALVE, WITH CORROSION-RESISTANT STAINLESS STEEL SPRING, THERMOPLASTIC RUBBER COVER, AND 2-PIECE BODY.
	ISOLATION GATE VALVE ASSEMBLY MATCO-NORCA 514TX: 1/2"-4" BRASS GATE VALVE, FULL PORT, WITH SOLID WEDGE. IPS. CROSS HANDLE. SAME SIZE AS MAINLINE PIPE.
	MASTER VALVE ASSEMBLY RAIN BIRD EFB-CP-PR5-D MASTER VALVE: 2" BRASS MASTER VALVE, THAT IS CONTAMINATION PROOF W/SELF-FLUSHING FILTER SCREEN. GLOBE CONFIGURATION, RECLAIMED WATER COMPATIBLE, AND PURPLE HANDLE COVER DESIGNATES NON-POTABLE WATER USE. WITH PRESSURE REGULATOR.
	FLOW SENSOR ASSEMBLY 2-INCH PVC TEE TYPE FLOW SENSOR W/SOCKET ENDS, CUSTOM MOUNTING TEE AND ULTRA-LIGHTWEIGHT IMPELLER ENHANCES LOW FLOW MEASUREMENT. 2 WIRE DIGITAL OUTPUT. FLOW RANGE 2.8-170 GPM.
	REDUCED PRESSURE BACKFLOW PREVENTER WILKINS 375B: BACKFLOW PREVENTER WITH BLOW OUT/FLUSH FITTING. REINFORCED NYLON HOUSING AND CAST BRONZE BALL VALVES. SIZED TO MATCH TAP & METER (RE: POC NOTE).
	PEDESTAL MOUNT IRRIGATION CONTROLLER TORO 5BW3GPS1 U-XTNDRAD: 3G-STATION MODULAR SENTINEL FIELD SATELLITE CONTROLLER. REMOTE AND FLOW SENSOR READY, WITH ET-BASED RUN TIMES. ENCLOSURE: STAINLESS STEEL PEDESTAL MOUNT. INSTALL IN COORDINATION WITH TOWN OF PARKER IRRIGATION STAFF. CONTACT DENNIS LYNCH AT CPS
	PEDESTAL MOUNT IRRIGATION CONTROLLER (OUTPUT BOARD) TORO 5BW12PS1-WORM: 12-STATION MODULAR SENTINEL FIELD SATELLITE CONTROLLER. REMOTE AND FLOW SENSOR READY, WITH ET-BASED RUN TIMES. ENCLOSURE: STAINLESS STEEL PEDESTAL MOUNT. INSTALL IN COORDINATION WITH TOWN OF PARKER IRRIGATION STAFF. CONTACT DENNIS LYNCH AT CPS
	'K' CONTROLLER IS A TORO 5BW3GPS1-WORM MODEL.
	IRRIGATION LATERAL LINE: PVC CLASS 200 SDR 21 PVC CLASS 200 IRRIGATION PIPE. ONLY LATERAL TRANSITION PIPE SIZES 1 1/4" AND ABOVE ARE INDICATED ON THE PLAN, WITH ALL OTHERS BEING 1" IN SIZE.
	IRRIGATION LATERAL LINE TO DRIP TRANSITION PIPE: PVC CLASS 200 SDR 21 1-INCH IN SIZE UNLESS OTHERWISE NOTED.
	DRIP IRRIGATION LATERAL LINE TO EMITTERS IN NATIVE SEED: 3/4-INCH UV RADIATION RESISTANT POLYETHYLENE PIPE TO NETAFIM INLINE DRIP TUBING TREE RINGS (RE: DETAILS).
	IRRIGATION MAINLINE: PVC CLASS 200 SDR 21 2.5-INCH UNLESS OTHERWISE NOTED.
	DRINKING FOUNTAIN WATER LINE: TYPE K COPPER, 3/4-INCH SIZE. REFER TO LANDSCAPE PLANS FOR DETAILS. INSTALL AT FROST FREE DEPTH.
	PIPE SLEEVE: PVC SCHEDULE 40 INSTALL AS SHOWN ON DESIGN OR TWICE THE SIZE OF THE PIPE OR WIRE RUNNING THRU IT. NO TWO PIPES OR WIRE BUNDLES SHALL SHARE THE SAME SLEEVE.

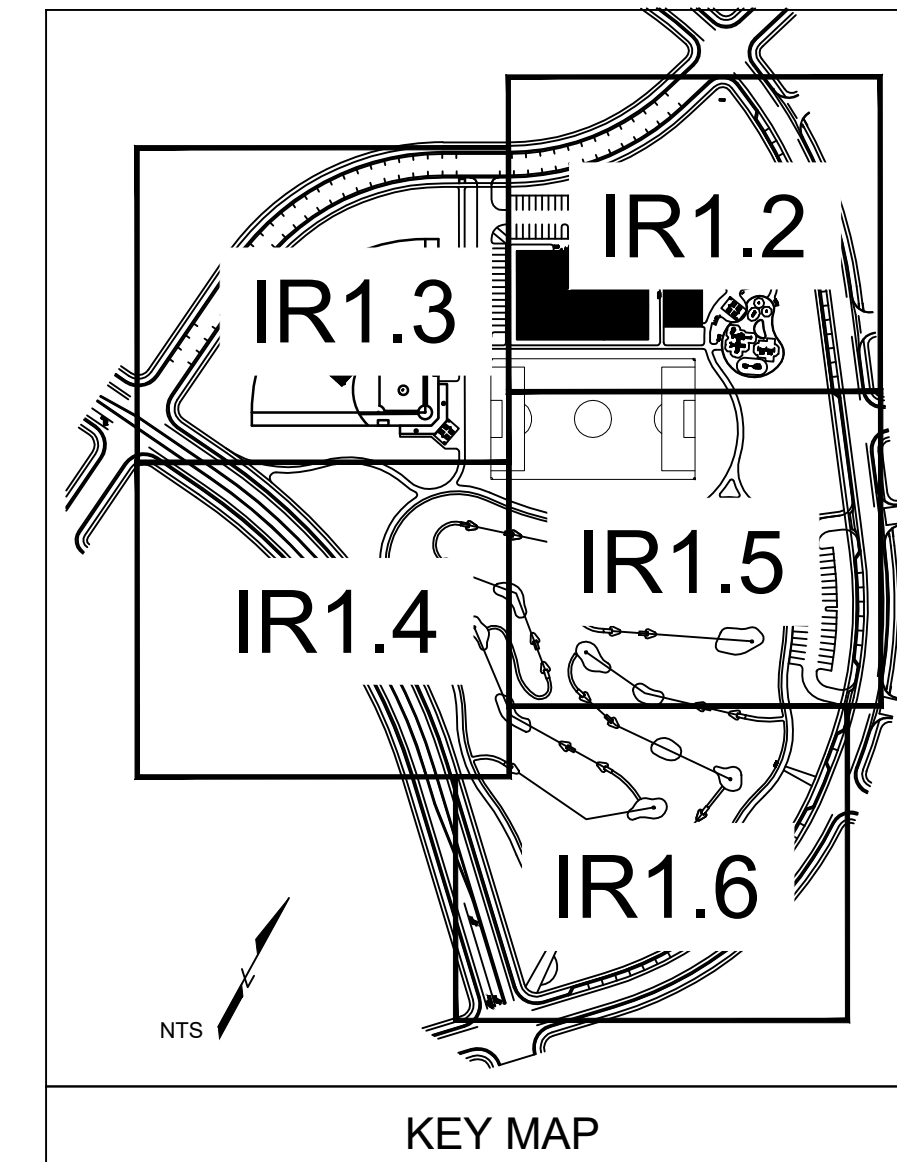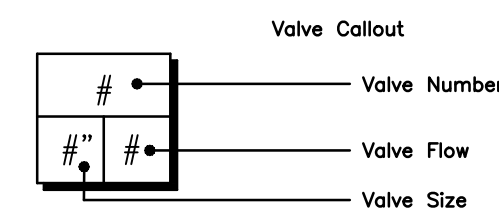

REFERENCE NOTES SCHEDULE

SYMBOL	DESCRIPTION
	THE IRRIGATION SYSTEM POINT-OF-CONNECTION (POC) SHALL BE DOWNSTREAM OF THE EXISTING IRRIGATION WATER TAP AND METER, AT THE APPROXIMATE LOCATION SHOWN. INSTALL BACKFLOW PREVENTION UNIT, MASTER VALVE ASSEMBLY, AND FLOW SENSOR AS INDICATED. VERIFY EXACT LOCATION OF POC WITH OWNER'S REPRESENTATIVE. VERIFY PRESSURE AND FLOW ON SITE PRIOR TO CONSTRUCTION.
	PEDESTAL MOUNT THE IRRIGATION CONTROLLER AT THE APPROXIMATE LOCATION SHOWN. COORDINATE ELECTRICAL POWER TO THE CONTROLLER WITH THE OWNER'S REPRESENTATIVE. CARE SHOULD BE TAKEN TO INSTALL THE IRRIGATION CONTROLLER IN A LOCATION THAT IS ACCESSIBLE FOR MAINTENANCE, AND SCREENED FROM VIEW EITHER BEHIND ENTRY WALLS, NEXT TO BUILDINGS, OR BEHIND PLANT MATERIAL. FINAL LOCATION TO BE APPROVED BY OWNER'S REPRESENTATIVE. INSTALL PER NATIONAL ELECTRIC CODE (NEC).
	IRRIGATION SHOWN IN HARDSCAPE FOR CLARITY ONLY. ALL IRRIGATION SHALL BE INSTALLED IN LANDSCAPED AREA. ANY IRRIGATION TO BE INSTALLED UNDER HARDSCAPE SHALL BE SLEEVED.
	INSTALL HYDRANT METER PER PWSO REQUIREMENTS: INSTALL PRESSURE REGULATING VALVE, 2" BACKFLOW, AND 2"x2" CAM LOCK FOR FIRE DEPARTMENT REMOVAL. UTILIZE TWO (2) SUPPORTS FOR ASSEMBLY. INSTALL MAINLINE ABOVE GRADE AND STAKE IN PLACE.
	CONTRACTOR SHALL INSTALL APPOSING-NOZZLE ROTOR IN 6-INCH ROUND VALVE BOX PER TOWN PARKS STANDARDS. COORDINATE INSTALLATION WITH TOWN PARKS IRRIGATION STAFF.
	CONTRACTOR SHALL INSTALL TYPE K COPPER LINE AT FROST FREE DEPTH TO DRINKING FOUNTAIN. INSTALL PER TOWN OF PARKER STANDARDS AND LOCAL PLUMBING CODES. REFER TO LANDSCAPE PLANS FOR DRINKING FOUNTAIN INSTALLATION AND CONNECTION DETAILS. COORDINATE INSTALLATION WITH GENERAL CONTRACTOR AND TOWN OF PARKER.


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Sheet Name
IRRIGATION LEGEND AND NOTES

Sheet Number
IR1.0



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LANDSCAPE/IRRIGATION WORKSHEET

Tap sizing for dedicated irrigation taps

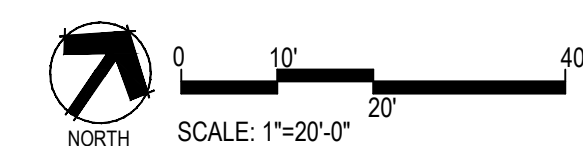Yellow fields require user input

$$\text{Irrigation Water Requirement} = (ETo \times PF \times LA) / IE$$

Define Landscape & Irrigation System:

High Water Use Plant Material	
*Cool season turfgrass (Kentucky bluegrass)	
Plant Factor (PF, %)	High 0.9
Landscape Area (LA, sq ft)	50910
Irrigation Efficiency (IE, %)	Overhead 0.65

High-Moderate Water Use Plant Material	
*Hybrid grass types (Texas hybrids, fescue, etc.)	
Plant Factor (PF, %)	High-Med 0.8
Landscape Area (LA, sq ft)	
Irrigation Efficiency (IE, %)	Overhead 0.65

Moderate Water Use Plant Material	
*Traditional trees/shrubs/perennials, alternative grass types (buffalograss, blue grama, etc.)	
Plant Factor (PF, %)	Med 0.5
Landscape Area (LA, sq ft)	19361
Irrigation Efficiency (IE, %)	Drip 0.9

Low Water Use Plant Material	
*Xeric trees/shrubs/perennials, native grass mixes	
Plant Factor (PF, %)	Low 0.25
Landscape Area (LA, sq ft)	112855
Irrigation Efficiency (IE, %)	Overhead 0.65

*PWSD holds final discretion for determining appropriate plant factor designations based on landscape plan submission

[Visit Appendix B of the SMWSA Model Ordinance for Plant Factor Guidelines](#)

Site Summary:	
Total Irrigated Area (sq ft)	183126
Avg Plant Factor (%)	0.46
Avg Irrigation Efficiency (%)	0.68

Peak monthly ET, Parker, CO:	
Peak monthly ET (July):	7.56 in

Irrigation Water Requirement (IWR):	
Peak monthly IWR:	584272 gal
Maximum flow requirement	61.1 GPM

*Max. flow requirements are based on peak monthly irrigation demands and follow PWSD's watering guidelines

Hydraulic Requirements:		
Tap Size (in)	Max GPM	v = 7.5 fps
3/4"	10	
1"	18	
1 1/2"	40	
2"	71	
3"	189	
4"	380	

*2" and smaller assumes Seamless K Copper Tube
3" and larger assumes Ductile Iron Pipe Class 350

Tap Size Requirement	
	2"

System Design Pressure: N/A PSI

Design pressure has been field tested & verified

This form has been completed in compliance with PWSD's Engineering Standards & Specifications Manual regarding irrigation design specifications

POC #8



LANDSCAPE/IRRIGATION WORKSHEET

Tap sizing for dedicated irrigation taps

Yellow fields require user input

$$\text{Irrigation Water Requirement} = (ETo \times PF \times LA) / IE$$

Define Landscape & Irrigation System:

High Water Use Plant Material	
*Cool season turfgrass (Kentucky bluegrass)	
Plant Factor (PF, %)	High 0.9
Landscape Area (LA, sq ft)	83617
Irrigation Efficiency (IE, %)	Overhead 0.65

High-Moderate Water Use Plant Material	
*Hybrid grass types (Texas hybrids, fescue, etc.)	
Plant Factor (PF, %)	High-Med 0.8
Landscape Area (LA, sq ft)	
Irrigation Efficiency (IE, %)	Overhead 0.65

Moderate Water Use Plant Material	
*Traditional trees/shrubs/perennials, alternative grass types (buffalograss, blue grama, etc.)	
Plant Factor (PF, %)	Med 0.5
Landscape Area (LA, sq ft)	13823
Irrigation Efficiency (IE, %)	Overhead 0.65

Low Water Use Plant Material	
*Xeric trees/shrubs/perennials, native grass mixes	
Plant Factor (PF, %)	Low 0.25
Landscape Area (LA, sq ft)	55399
Irrigation Efficiency (IE, %)	Drip 0.9

*PWSD holds final discretion for determining appropriate plant factor designations based on landscape plan submission

[Visit Appendix B of the SMWSA Model Ordinance for Plant Factor Guidelines](#)

Site Summary:	
Total Irrigated Area (sq ft)	152839
Avg Plant Factor (%)	0.63
Avg Irrigation Efficiency (%)	0.74

Peak monthly ET, Parker, CO:	
Peak monthly ET (July):	7.56 in

Irrigation Water Requirement (IWR):	
Peak monthly IWR:	664641 gal
Maximum flow requirement	69.5 GPM

*Max. flow requirements are based on peak monthly irrigation demands and follow PWSD's watering guidelines

Hydraulic Requirements:		
Tap Size (in)	Max GPM	v = 7.5 fps
3/4"	10	
1"	18	
1 1/2"	40	
2"	71	
3"	189	
4"	380	

*2" and smaller assumes Seamless K Copper Tube
3" and larger assumes Ductile Iron Pipe Class 350

Tap Size Requirement	
	2"

System Design Pressure: N/A PSI

Design pressure has been field tested & verified

This form has been completed in compliance with PWSD's Engineering Standards & Specifications Manual regarding irrigation design specifications

POC #11

INSTALLATION GENERAL NOTES

- DESIGN ASSUMES A MINIMUM DYNAMIC PRESSURE FOR THE IRRIGATION SYSTEM (PER CITY OR ENGINEER) OF UP TO 90 PSI, AT A MINIMUM FLOW OF 70 GPM AT EACH 2-INCH POINT-OF-CONNECTION (POC). VERIFY PRESSURE AND FLOW ON SITE PRIOR TO CONSTRUCTION. CONTACT GENERAL CONTRACTOR OR OWNER'S REPRESENTATIVE IMMEDIATELY IF FLOW OR PRESSURE ARE LOWER THAN LISTED ABOVE. BOOSTER PUMP MAY BE REQUIRED.
 - NEITHER HISTORICAL NOR CIVIL SITE HYDRAULICS WERE AVAILABLE AT THE TIME OF DESIGN.
- CONTRACTOR SHALL BECOME FAMILIAR WITH THE SPECIFICATIONS AND INSTALLATION DETAILS FOR THIS AND RELATED WORK PRIOR TO CONSTRUCTION. FOR CLARIFICATION, CONTACT IRRIGATION DESIGNER PRIOR TO CONSTRUCTION.
 - UPON FINAL ACCEPTANCE, CONTRACTOR SHALL TURN OVER REQUIRED ADJUSTMENT KEYS INCLUDING BUT NOT LIMITED TO CONTROLLER ENCLOSURE AND BACKFLOW ENCLOSURE KEY, LOCKING VALVE BOX KEYS, QUICK COUPLER KEYS, GATE VALVE KEY, SPRINKLER HEAD AND NOZZLE ADJUSTMENT KEYS.
 - UPON FINAL ACCEPTANCE, CONTRACTOR SHALL TURN OVER SPARE PARTS PERTAINING TO INSTALLED SYSTEM: BACKFLOW WINTERIZATION INSERT, TWO OF EVERY HEAD AND NOZZLE (ROTOR NOZZLE TREE INCLUDED), ONE RCV DIAPHRAGM, ETC.
- COORDINATE UTILITY LOCATES OF UNDERGROUND UTILITIES PRIOR TO CONSTRUCTION ("811-CALL BEFORE YOU DIG").
- IF DISCREPANCIES ARE NOTED IN THE FIELD BETWEEN SITE CONDITIONS AND PROVIDED DESIGNS, CONTRACTOR SHALL NOTIFY OWNER'S REPRESENTATIVE OR GENERAL CONTRACTOR IMMEDIATELY. DO NOT PROCEED WITH THE INSTALLATION OF THE IRRIGATION SYSTEM IF SUCH DISCREPANCIES IN THE FIELD AFFECT THE PROVIDED DESIGN, DETAILS, OR SPECIFICATIONS.

- ALL IRRIGATION COMPONENTS (MAINLINE, WIRES, LATERAL LINES, ETC.) SHALL BE INSTALLED IN LANDSCAPED AREAS WHENEVER POSSIBLE, EVEN THOUGH SAID IRRIGATION COMPONENTS MAY BE SHOWN OUTSIDE PLANTING AREAS FOR CLARITY.
- AVOID CONFLICTS BETWEEN THE IRRIGATION SYSTEM, PLANTING MATERIALS, AND ARCHITECTURAL FEATURES WHENEVER POSSIBLE. COORDINATE POTENTIAL RELOCATION OF BOULDERS AND TREES IN TURF AREAS WITH LANDSCAPE ARCHITECT PRIOR TO SPRINKLER LAYOUT. IF LANDSCAPE MATERIAL CANNOT BE RELOCATED, ADDITIONAL SPRINKLERS MAY BE REQUIRED.
- CROSS FITTINGS ARE NOT ALLOWED, ONLY STANDARD TEES AND ELBOWS.
- CONTRACTOR SHALL INSTALL NOZZLES PER PLAN, UNLESS IRRIGATED AREA CHANGED IN SIZE OR PLANT MATERIAL TYPE CHANGES. IF NOZZLE CHANGES ARE REQUIRED AND ARE SIGNIFICANT IN SIZE, CONTRACTOR SHALL CONTACT IRRIGATION DESIGNER FOR APPROVAL.
- CONTRACTOR SHALL FIELD LOCATE ANY EXISTING SLEEVES ON SITE PRIOR TO CONSTRUCTION WITH THE AID OF THE GENERAL CONTRACTOR. MISSING SLEEVES SHALL BE REPORTED IMMEDIATELY. NEW SLEEVES SHOWN ON PLANS ARE REQUIRED FOR BOTH PIPING AND ELECTRICAL WIRING AT EACH HARDSCAPE CROSSING. COORDINATE INSTALLATION OF SLEEVING WITH OTHER TRADES. ANY PIPE OR WIRE WHICH PASSES BENEATH EXISTING HARDSCAPE WHERE SLEEVING WAS NOT INSTALLED WILL REQUIRE HORIZONTAL BORING BY THE IRRIGATION CONTRACTOR.
- INSTALL ALL ELECTRICAL POWER TO THE IRRIGATION CONTROL SYSTEM IN ACCORDANCE WITH THE NATIONAL ELECTRIC CODE AND ALL APPLICABLE LOCAL ELECTRIC UTILITY CODES.


- THE FOLLOWING SHOULD BE NOTED REGARDING PIPE SIZING: IF A SECTION OF UNSIZED PIPE IS LOCATED BETWEEN THE IDENTICALLY SIZED SECTIONS, THE UNSIZED PIPE IS THE SAME NOMINAL SIZE AS THE TWO SIZED SECTIONS. THE UNSIZED PIPE SHOULD NOT BE CONFUSED WITH THE DEFAULT PIPE SIZE NOTED IN THE LEGEND.
 - MAINLINE PIPE SIZES MAY VARY THROUGHOUT PROJECT. EACH MAINLINE LEG IS SIZED TO ACCOMMODATE LARGEST VALVE ON THAT LEG. STATED SIZE IN LEGEND MAY NOT BE THE LARGEST SIZE ON PLANS.
 - INSTALL THREE (3) #14 AWG CONTROL WIRES FROM CONTROLLER LOCATION TO EACH DEAD-END OF MAINLINE FOR USE AS SPARES IN CASE OF CONTROL WIRE FAILURE. COIL 3 FEET OF WIRE IN VALVE BOX.
 - TREES IN TURF ARE NOT IRRIGATED BY DRIP SYSTEM. DRIP LATERAL ROUTED NEAR TREES IN TURF ARE NOT TO RECEIVE DRIP IRRIGATION. TREES IN UNDISTURBED NATIVE SEEDING AREAS ARE IRRIGATED ON DRIP SYSTEM.
 - NO IRRIGATION EQUIPMENT, INCLUDING BUT NOT LIMITED TO, MAINLINE, VALVES, AND SPRINKLERS, SHALL BE INSTALLED WITHIN 3' OF NEW BUILDING FOUNDATION.
 - SPRINKLER ZONES CAN ONLY COVER AN ELEVATION RANGE OF 1', THUS THE SMALLER VALVE SIZES. ZONES CAN OPERATE SIMULTANEOUSLY WHERE APPLICABLE.
 - MAINLINE LOOPS ARE SIZED TO UTILIZE TAP SUPPLY OF 70 GPM.
 - DEAD END MAINLINE RUNS ARE SIZED TO ACCOMMODATE THE LARGEST VALVE ON THE RUN.



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PARKER, COLORADO
IRRIGATION PLANS



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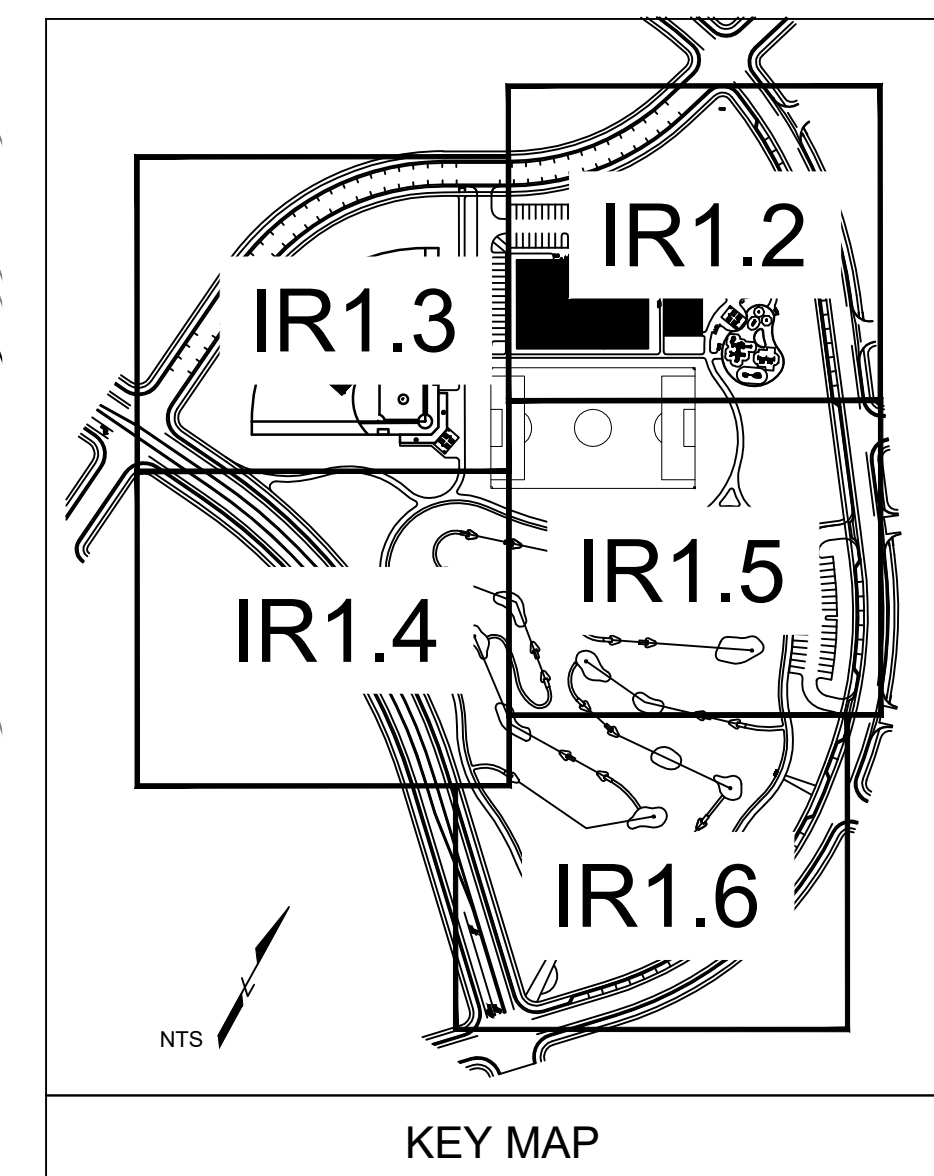
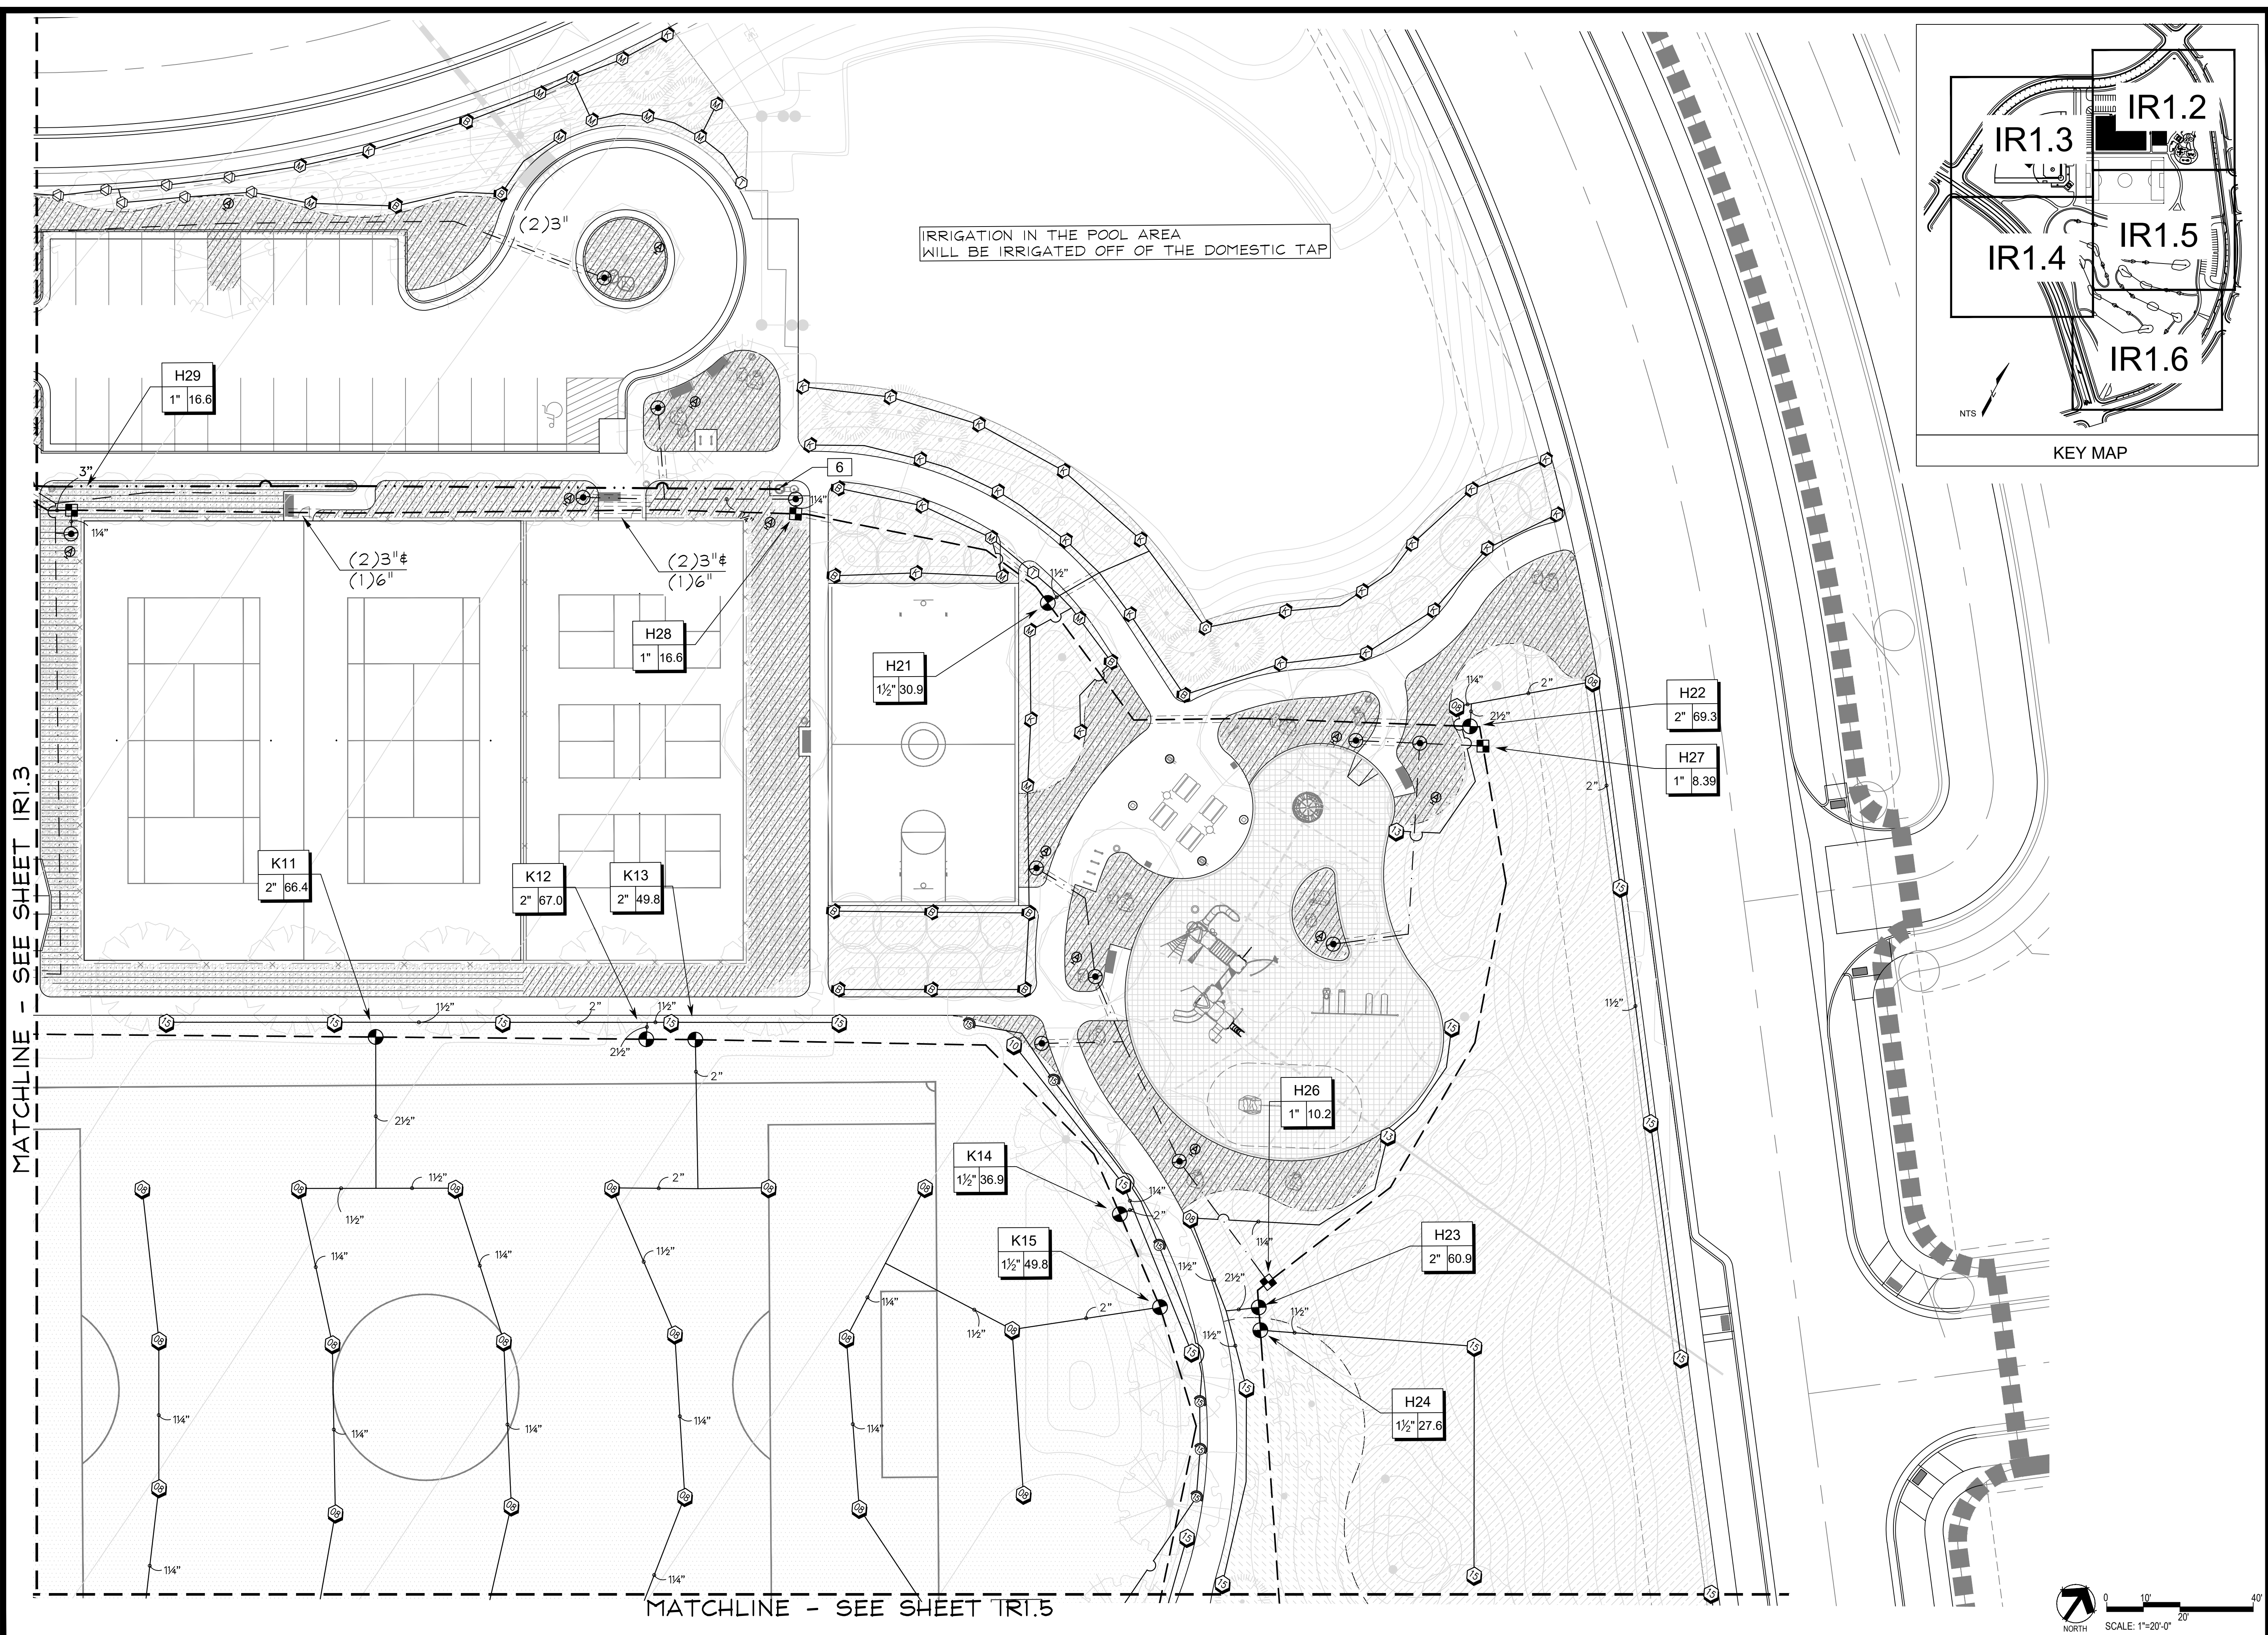
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Sheet Name

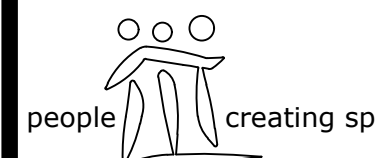IRRIGATION TAP WORKSHEETS


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MATCHLINE - SEE SHEET IR1.3

MATCHLINE - SEE SHEET TR1.5



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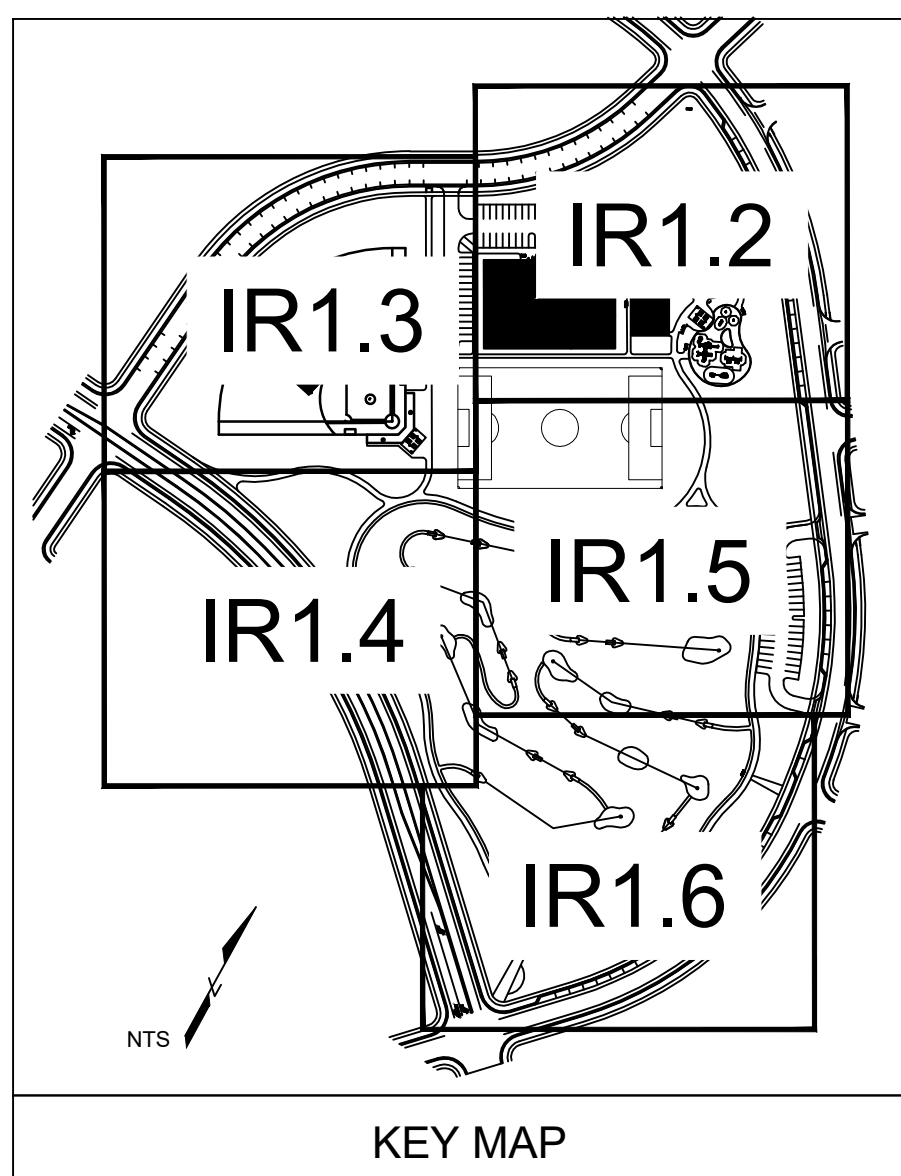
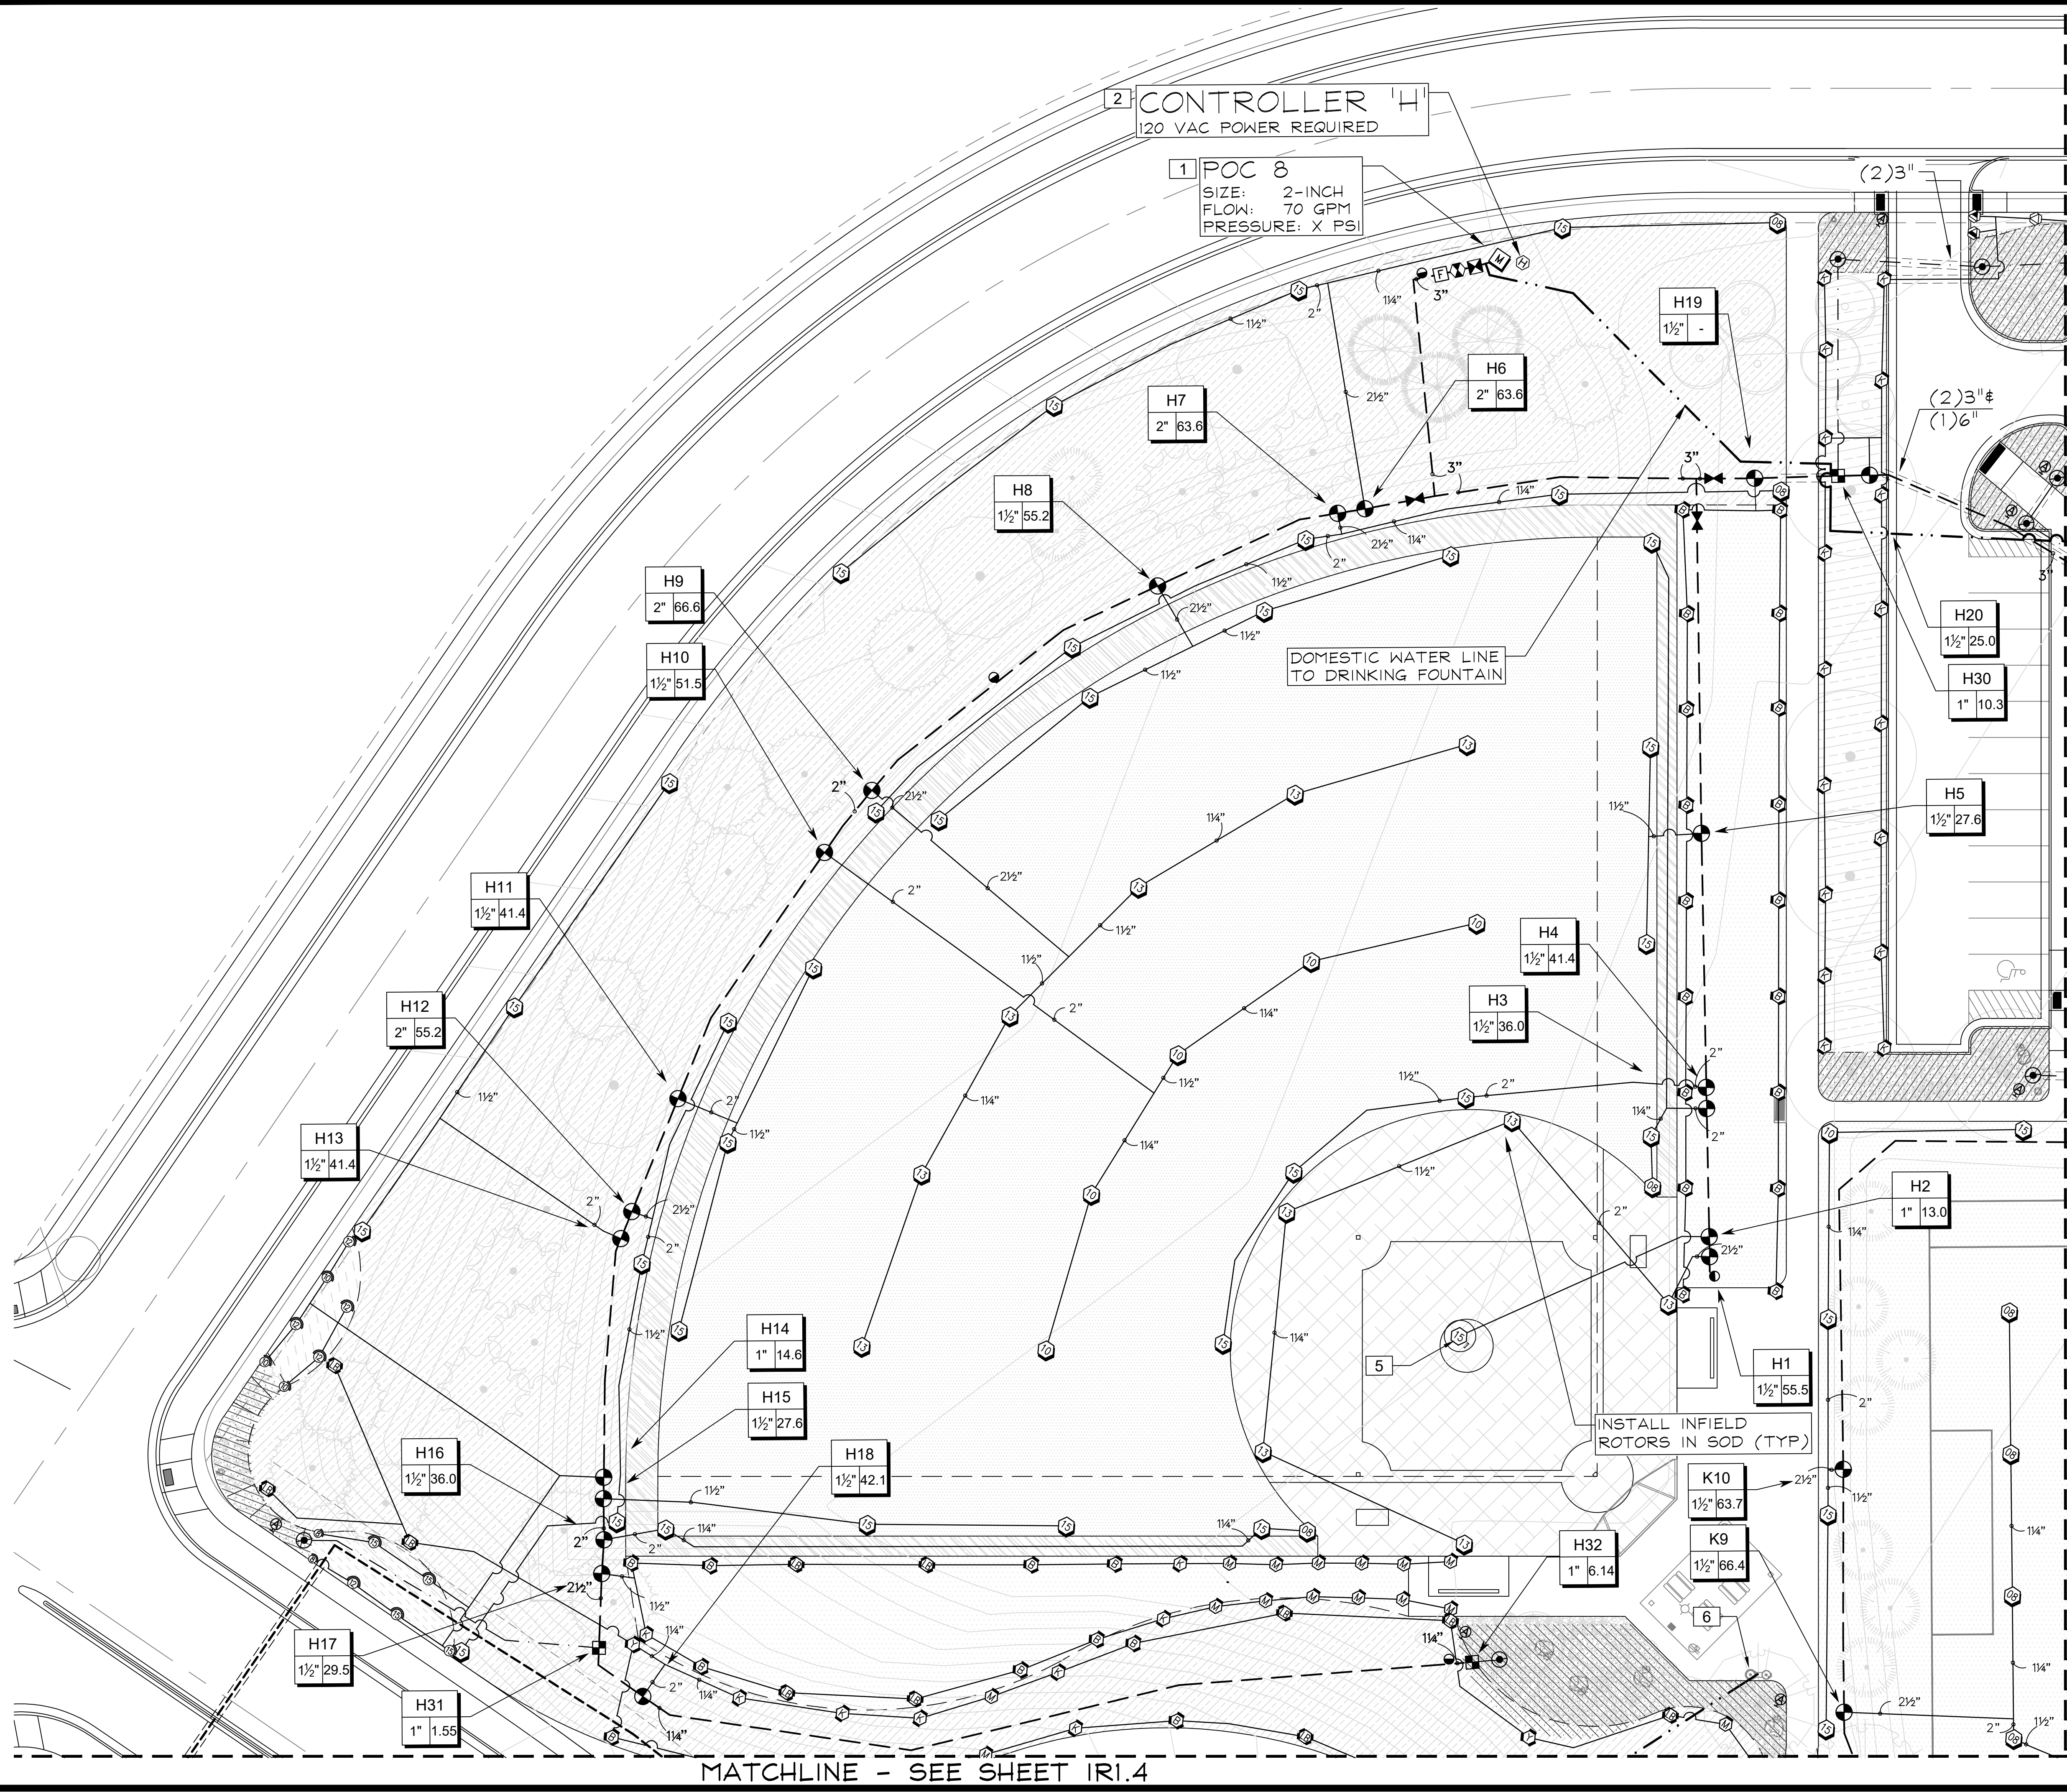
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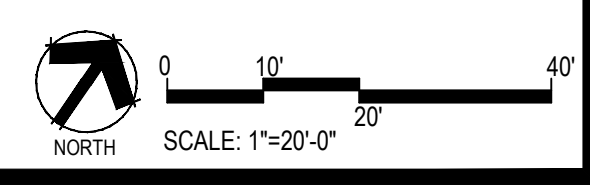
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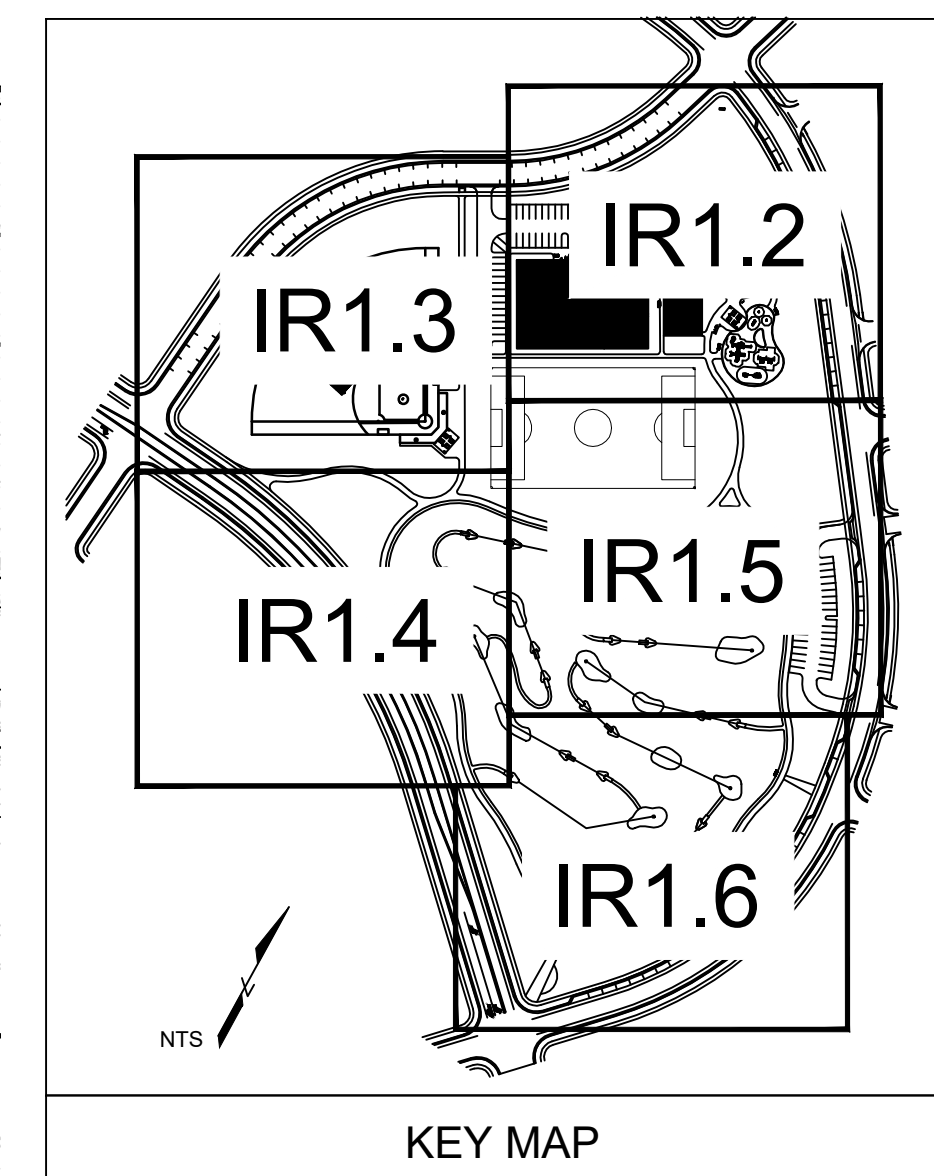
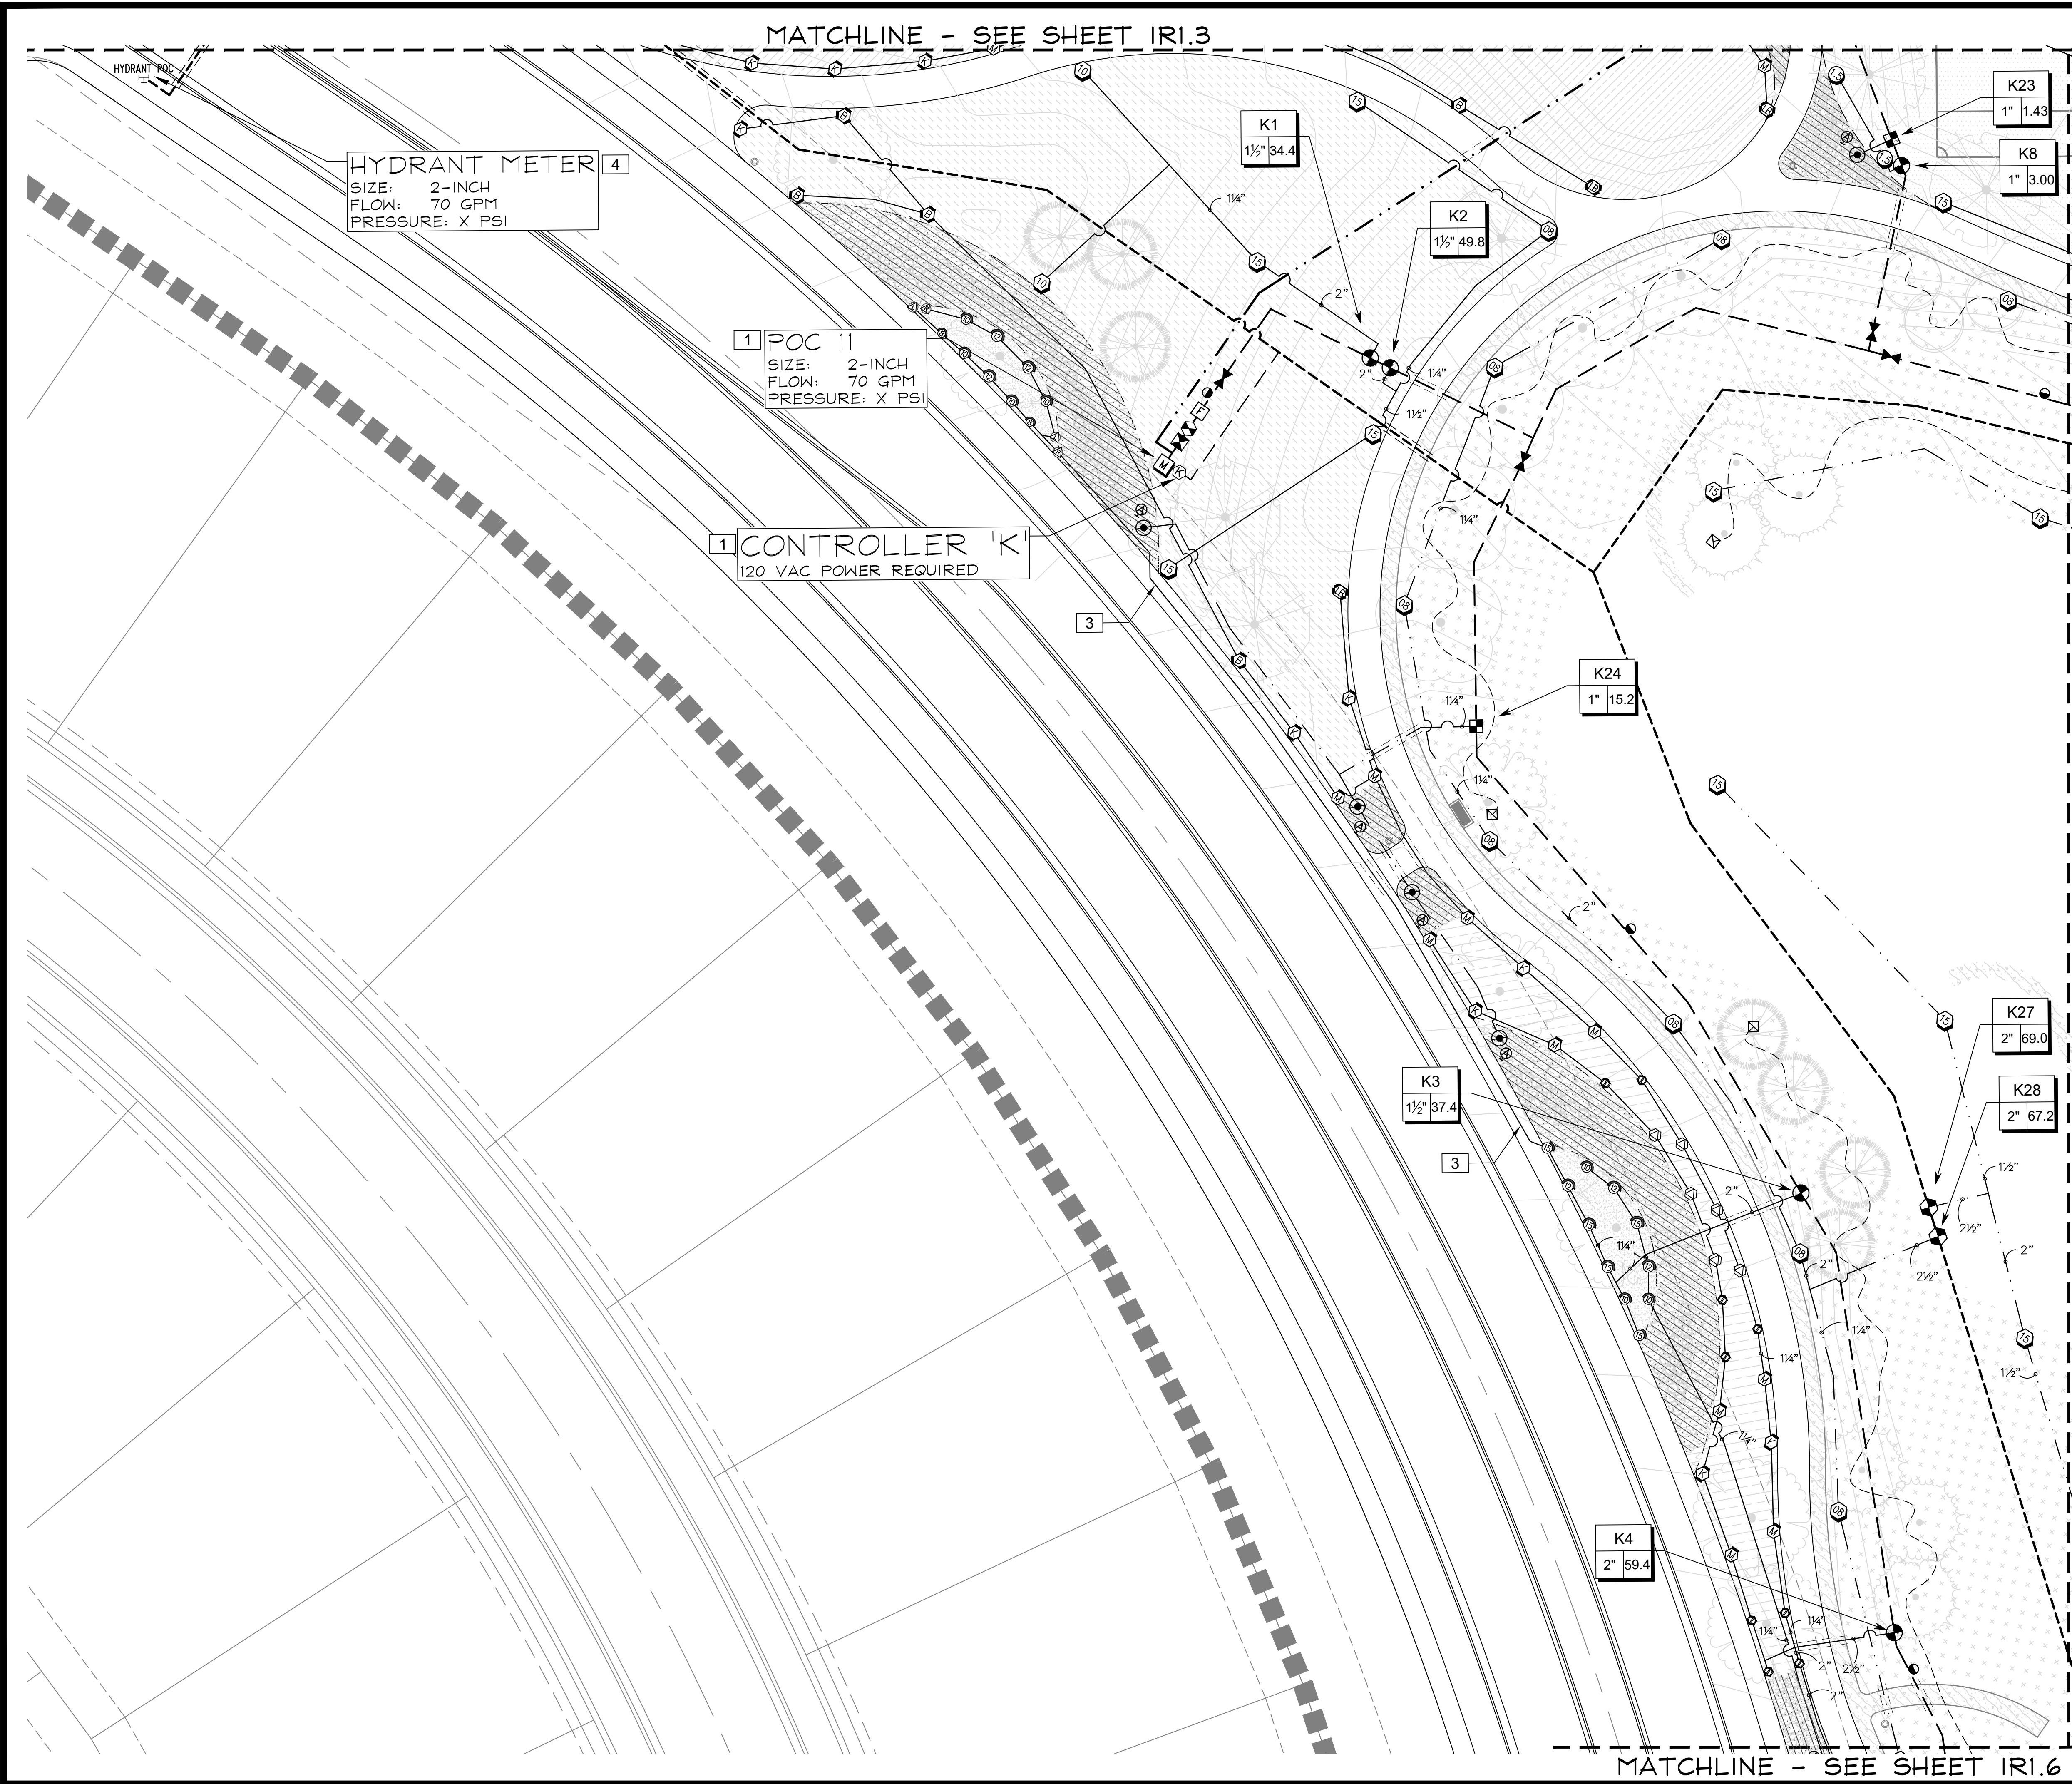
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IR1.3

MATCHLINE - SEE SHEET IR1.4

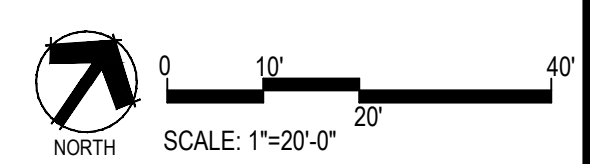MATCHLINE - SEE SHEET IR1.2





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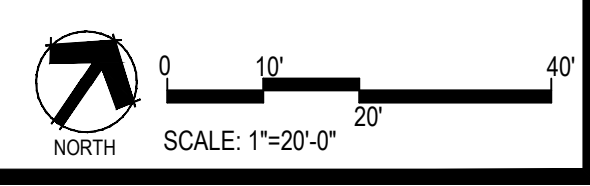
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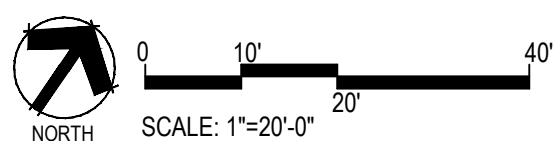
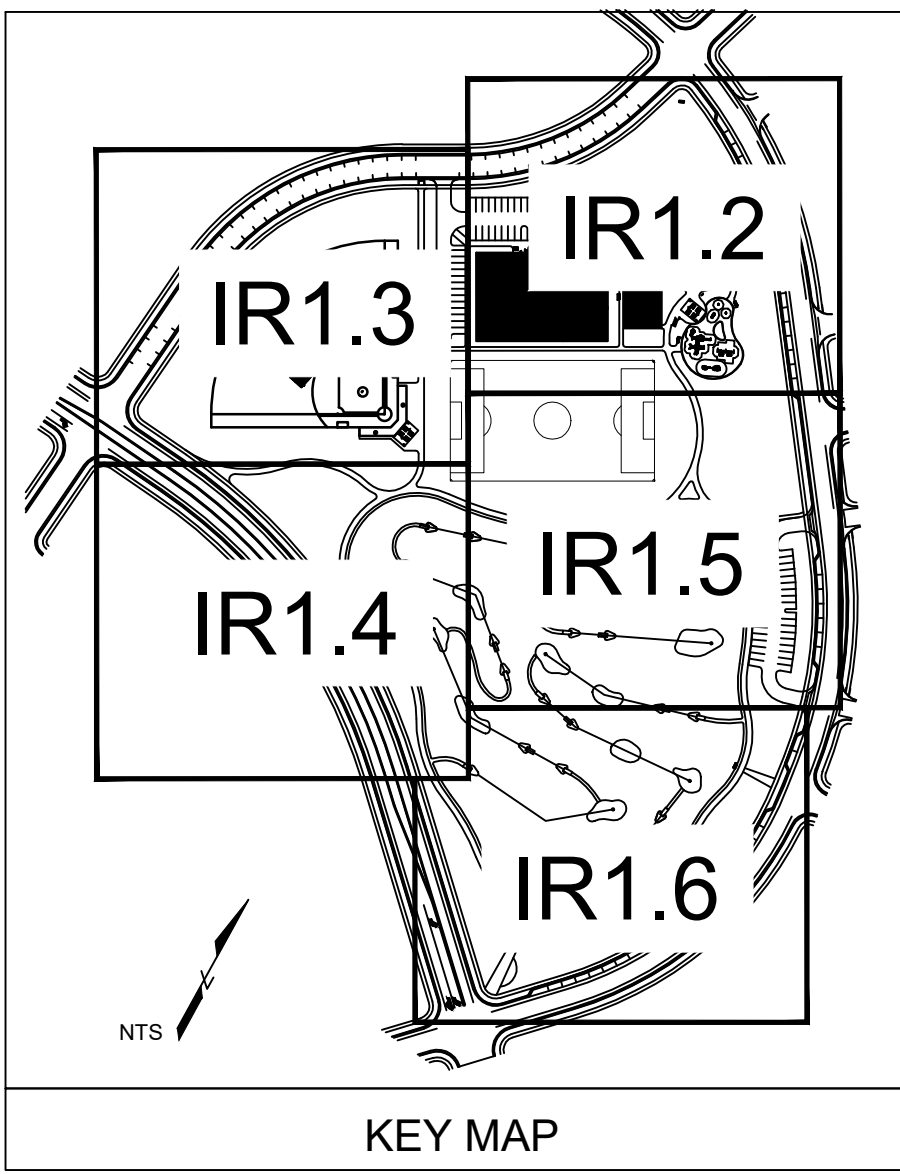
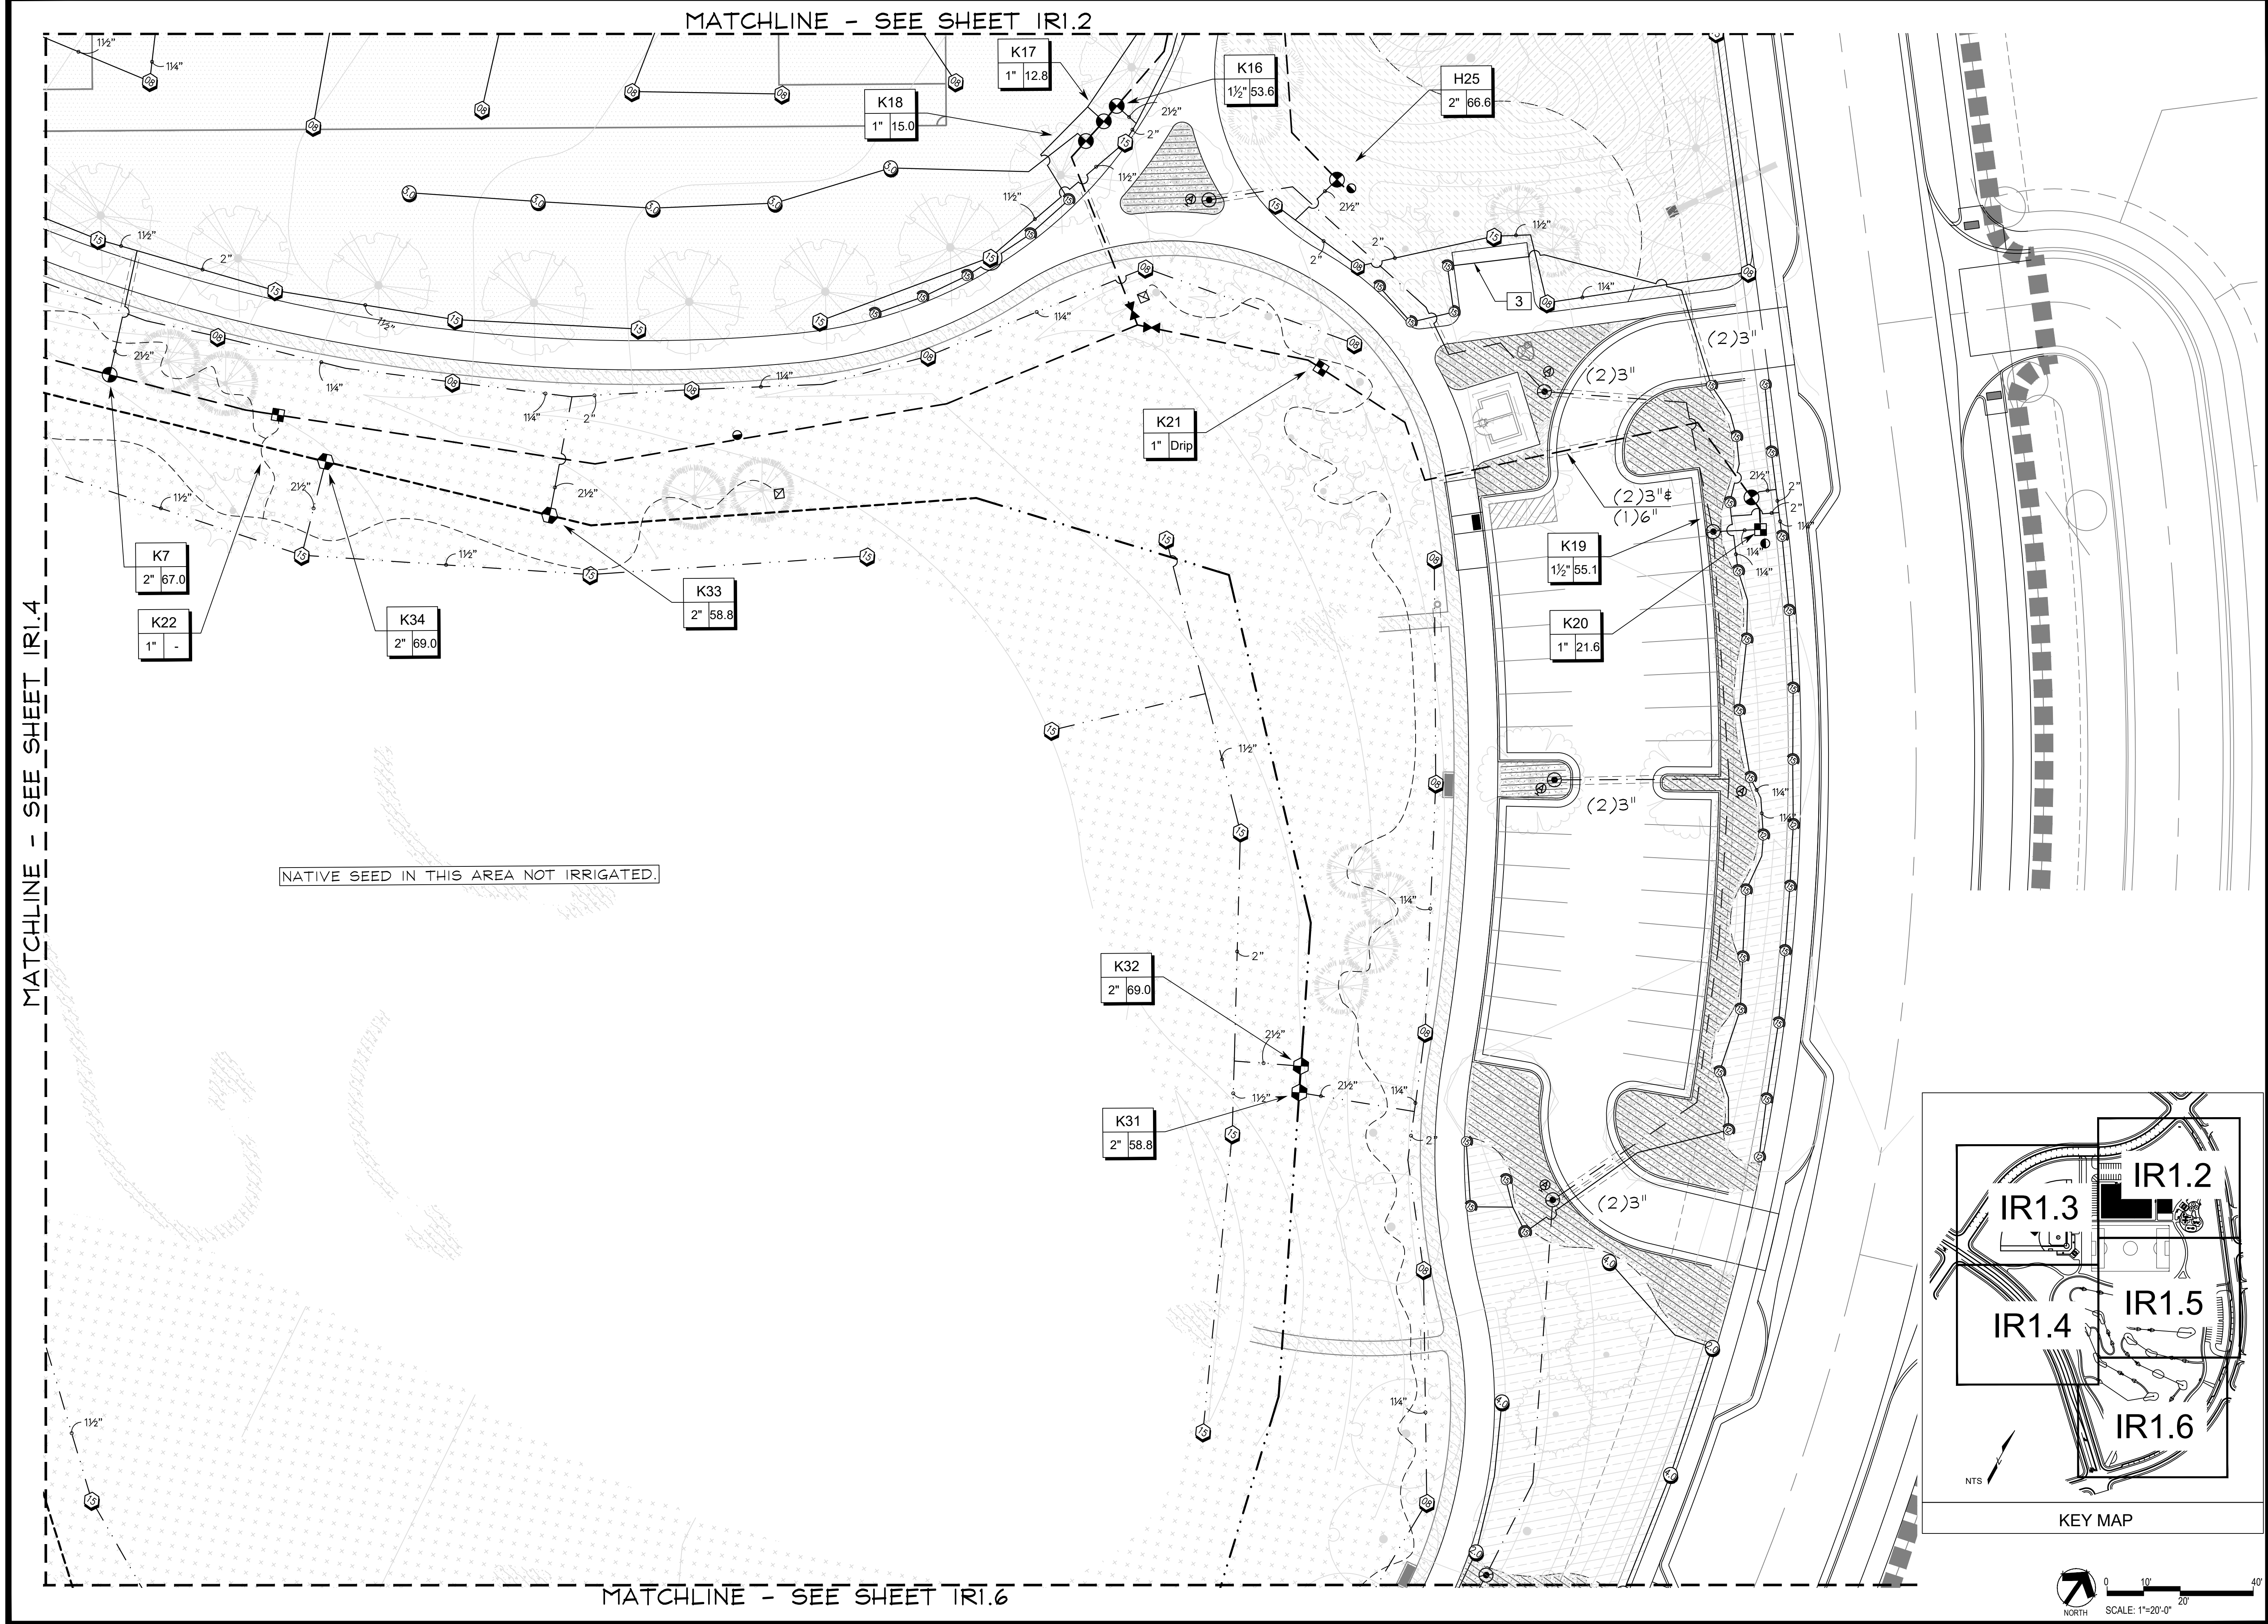
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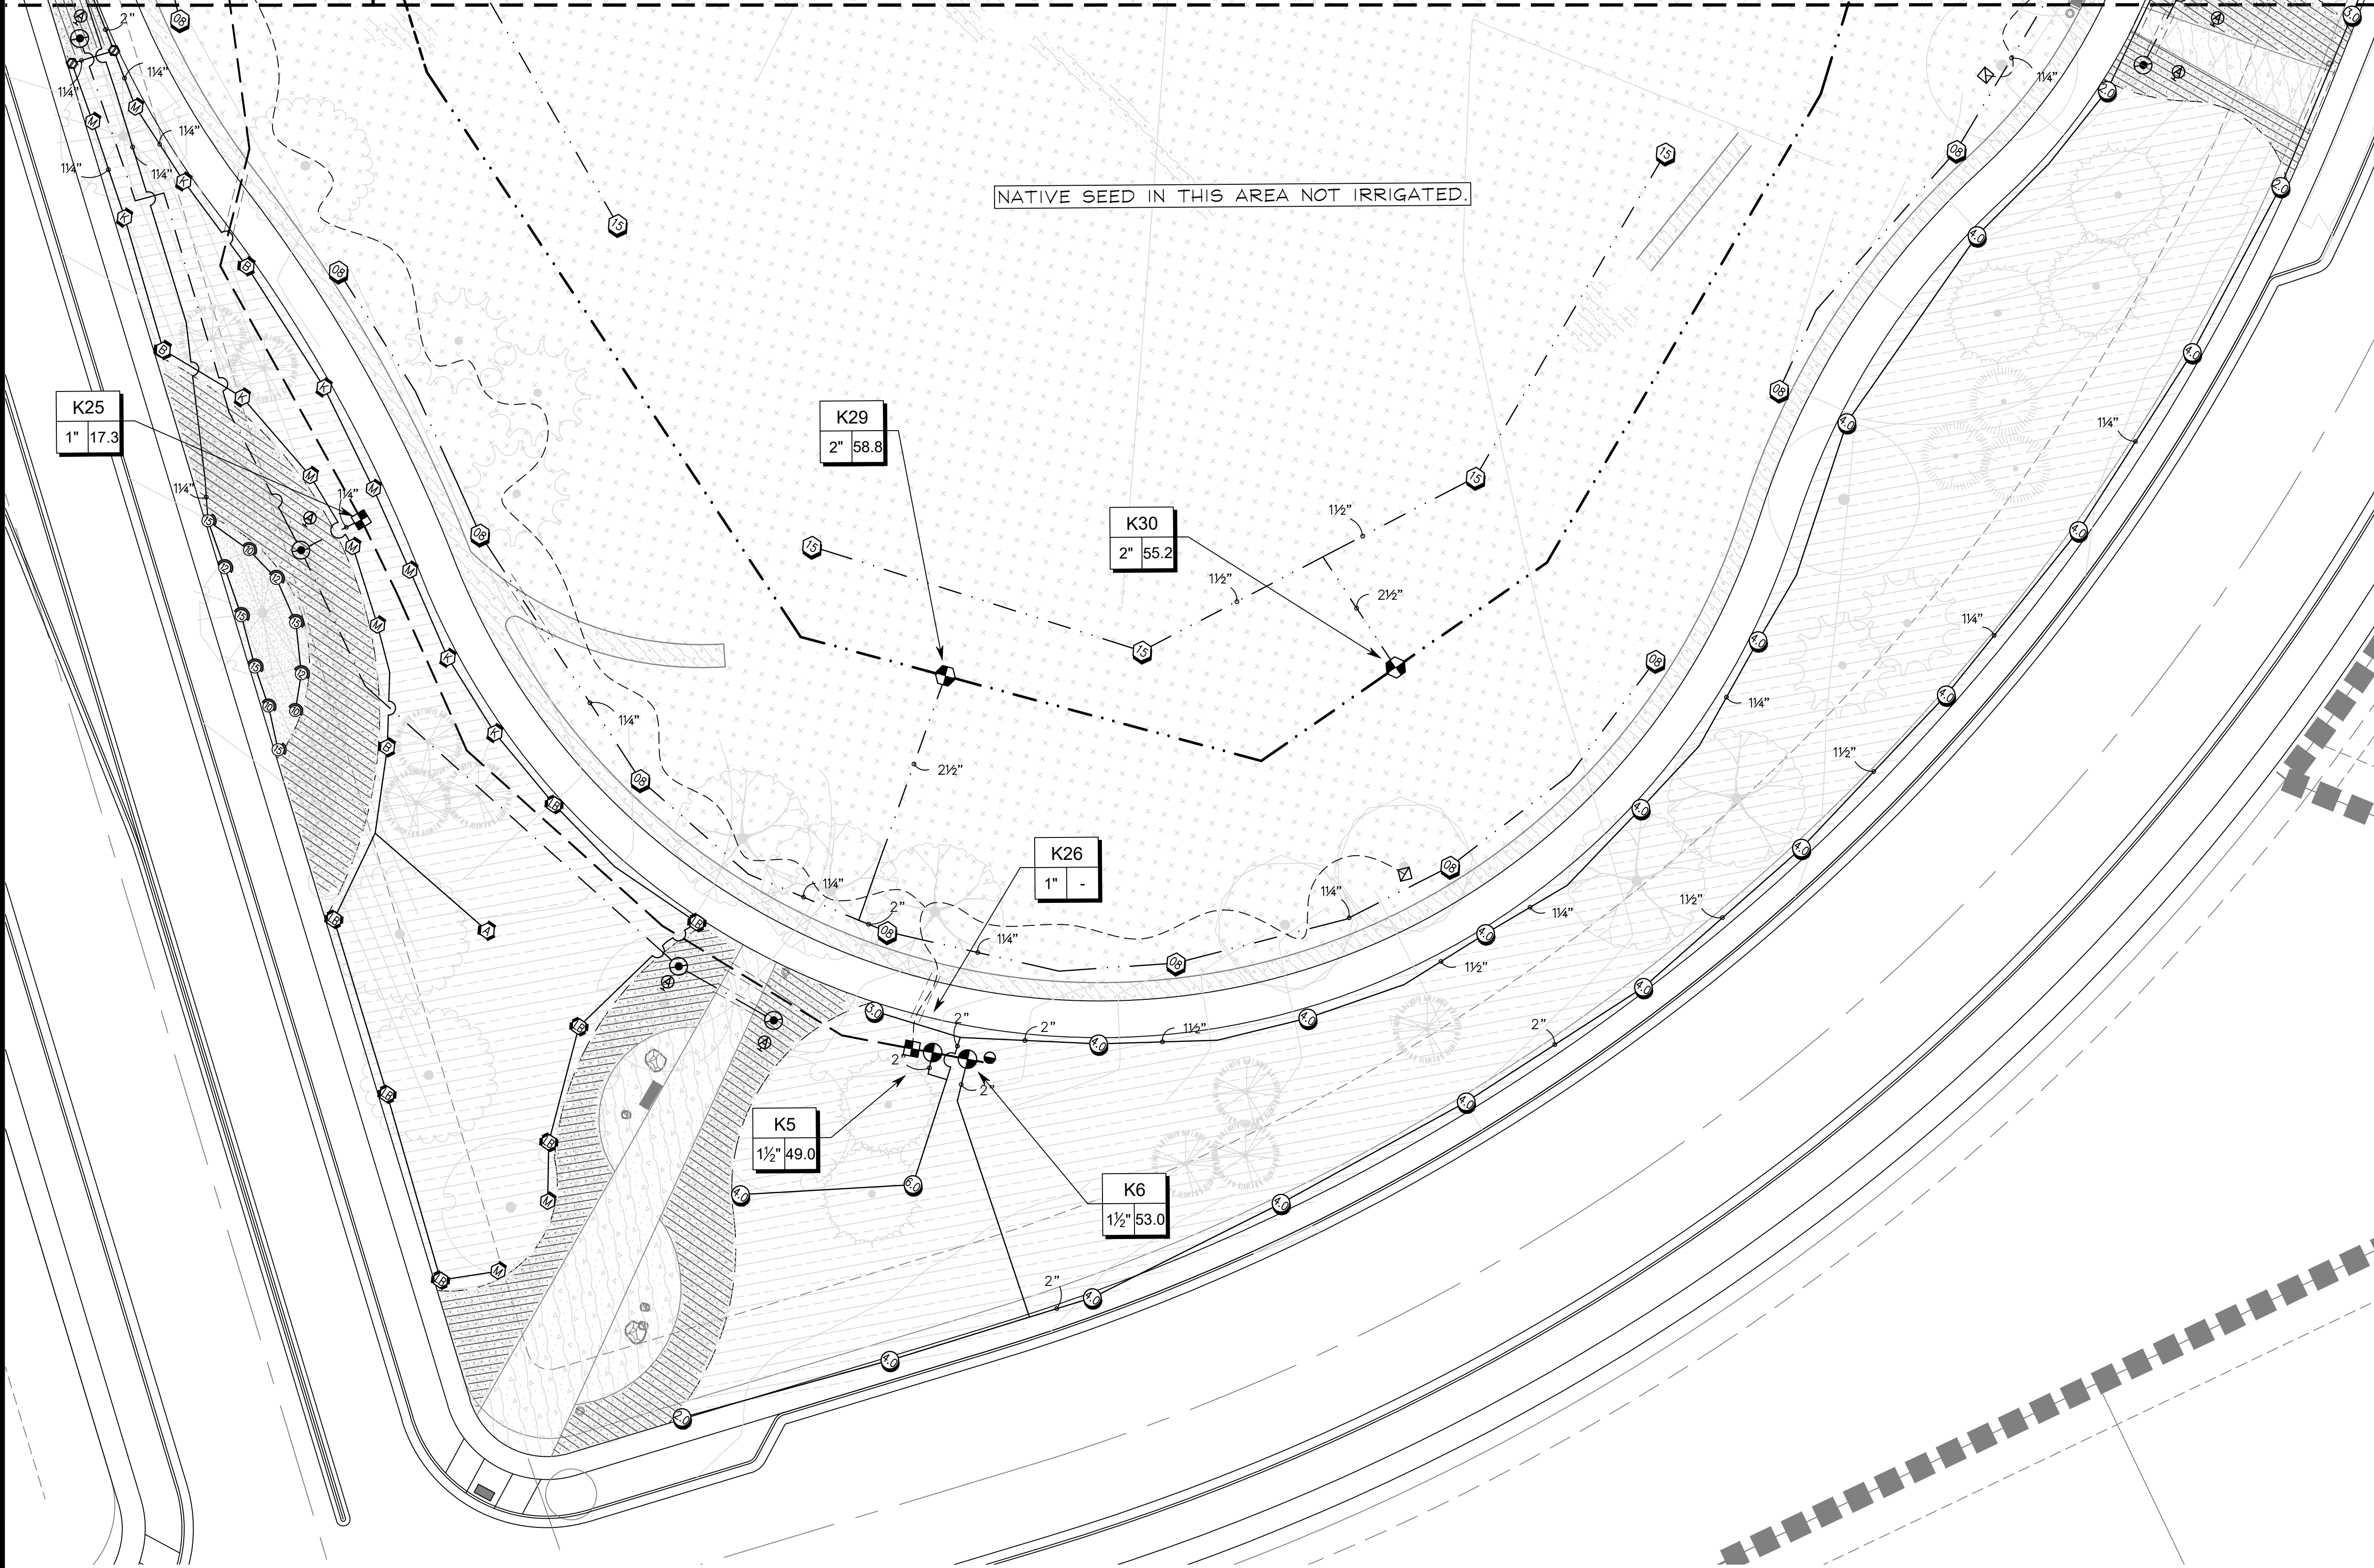
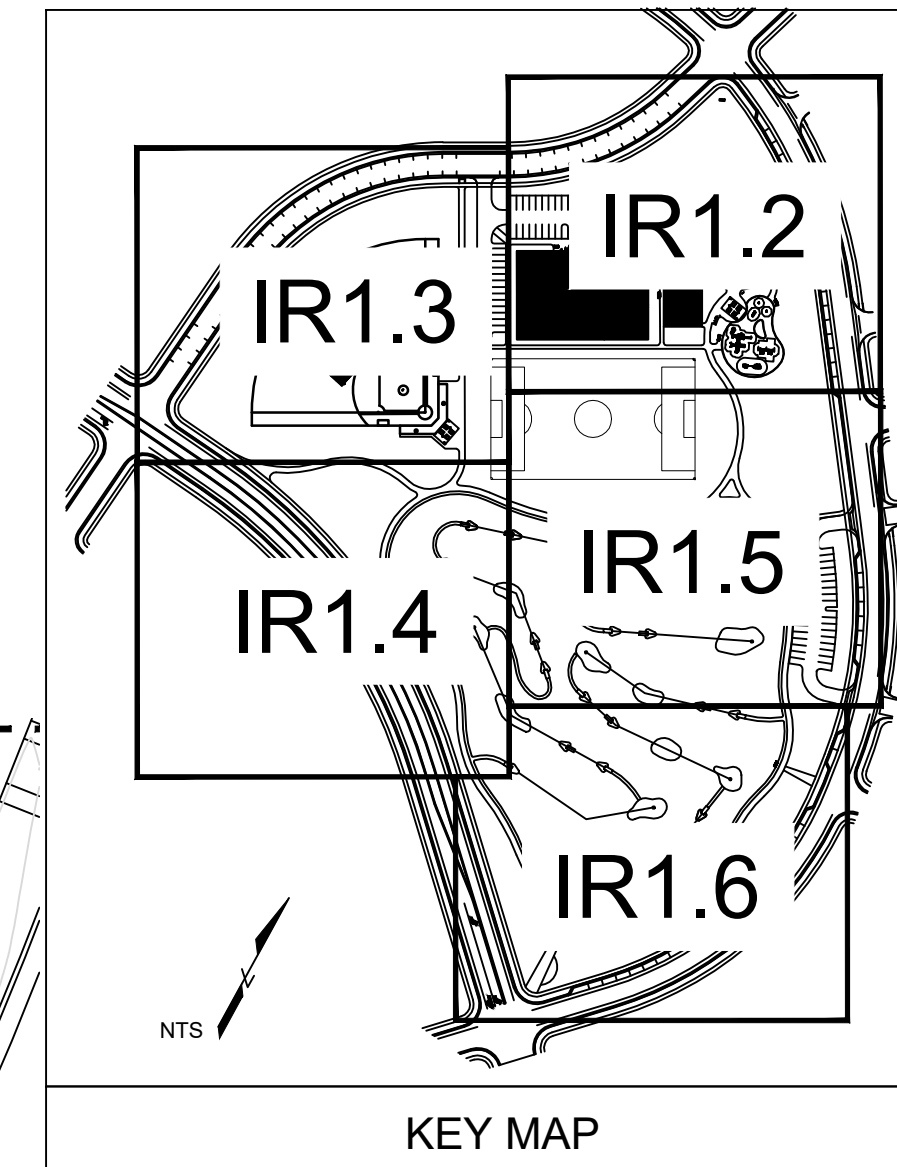
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MATCHLINE - SEE SHEET IR1.4

MATCHLINE - SEE SHEET IR1.5

NATIVE SEED IN THIS AREA NOT IRRIGATED.



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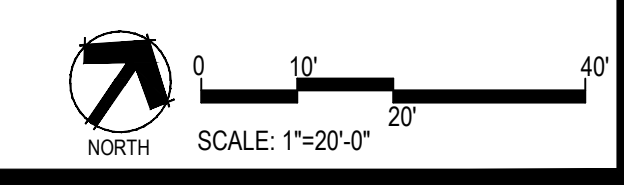
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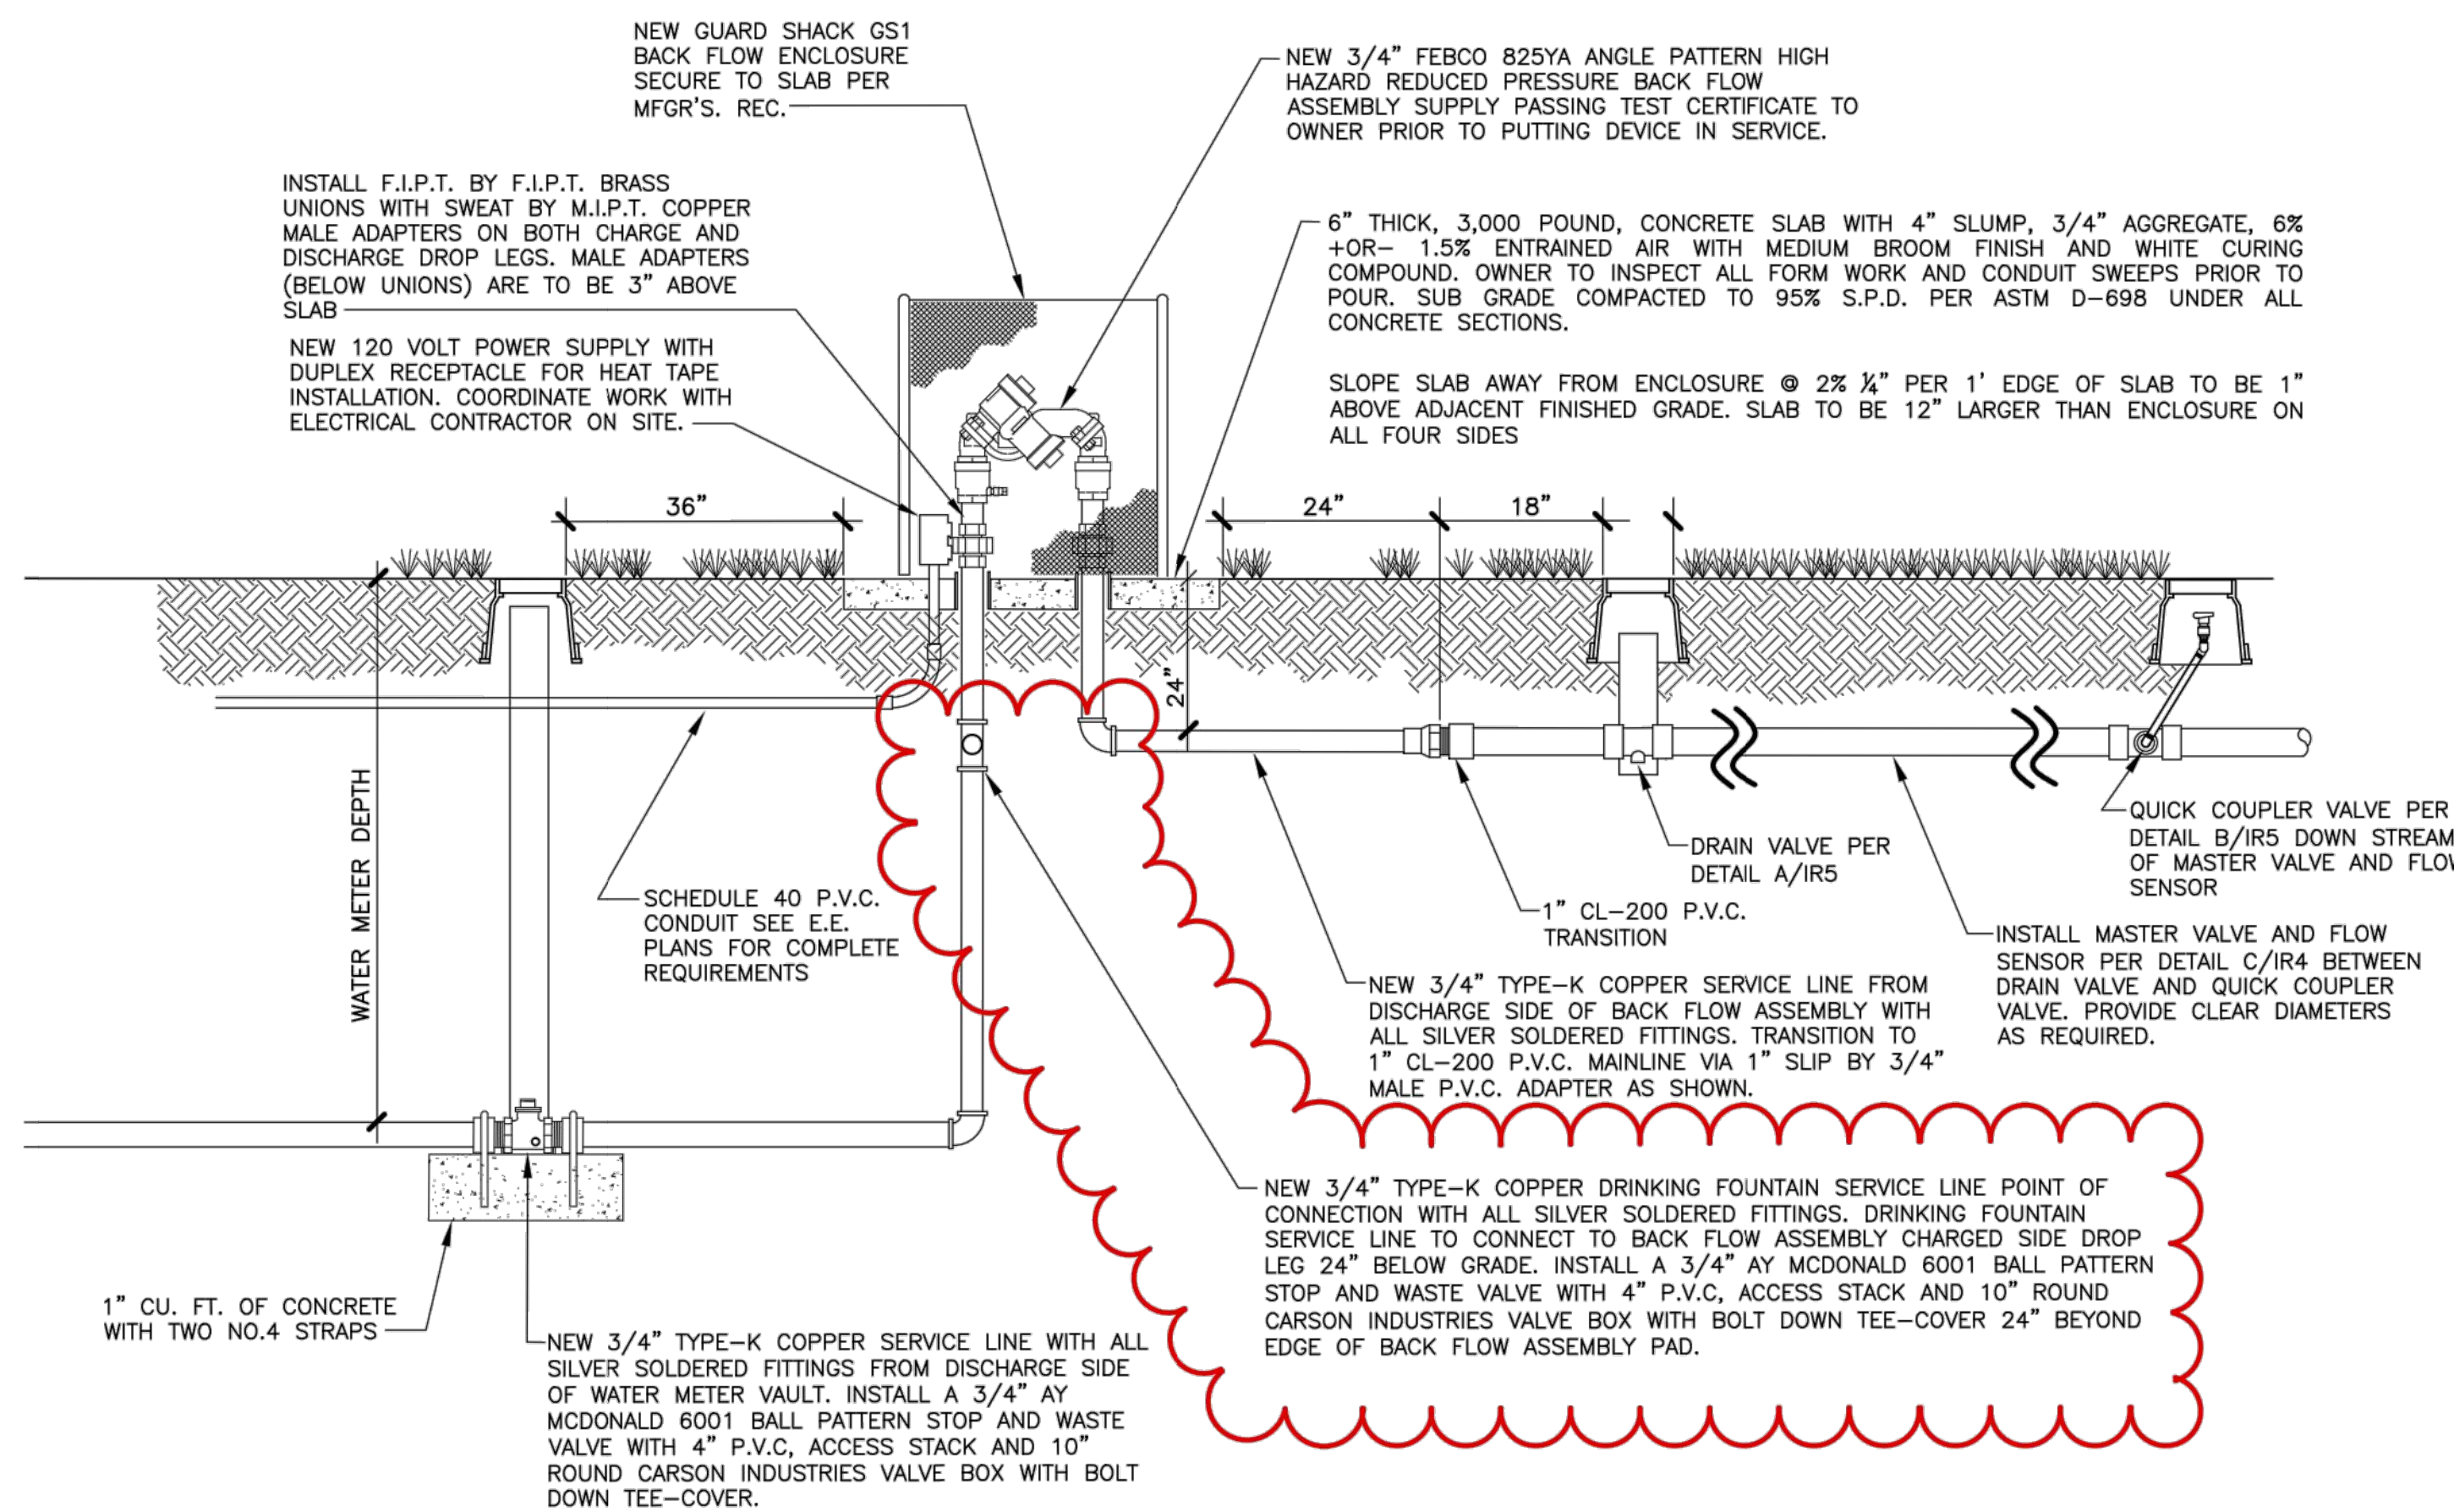
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IRRIGATION PLANS


Sheet Number

IR1.6





A IRRIGATION SYSTEM POINT OF CONNECTION AND BACK FLOW ASSEMBLY SECTION
IR4 NO SCALE

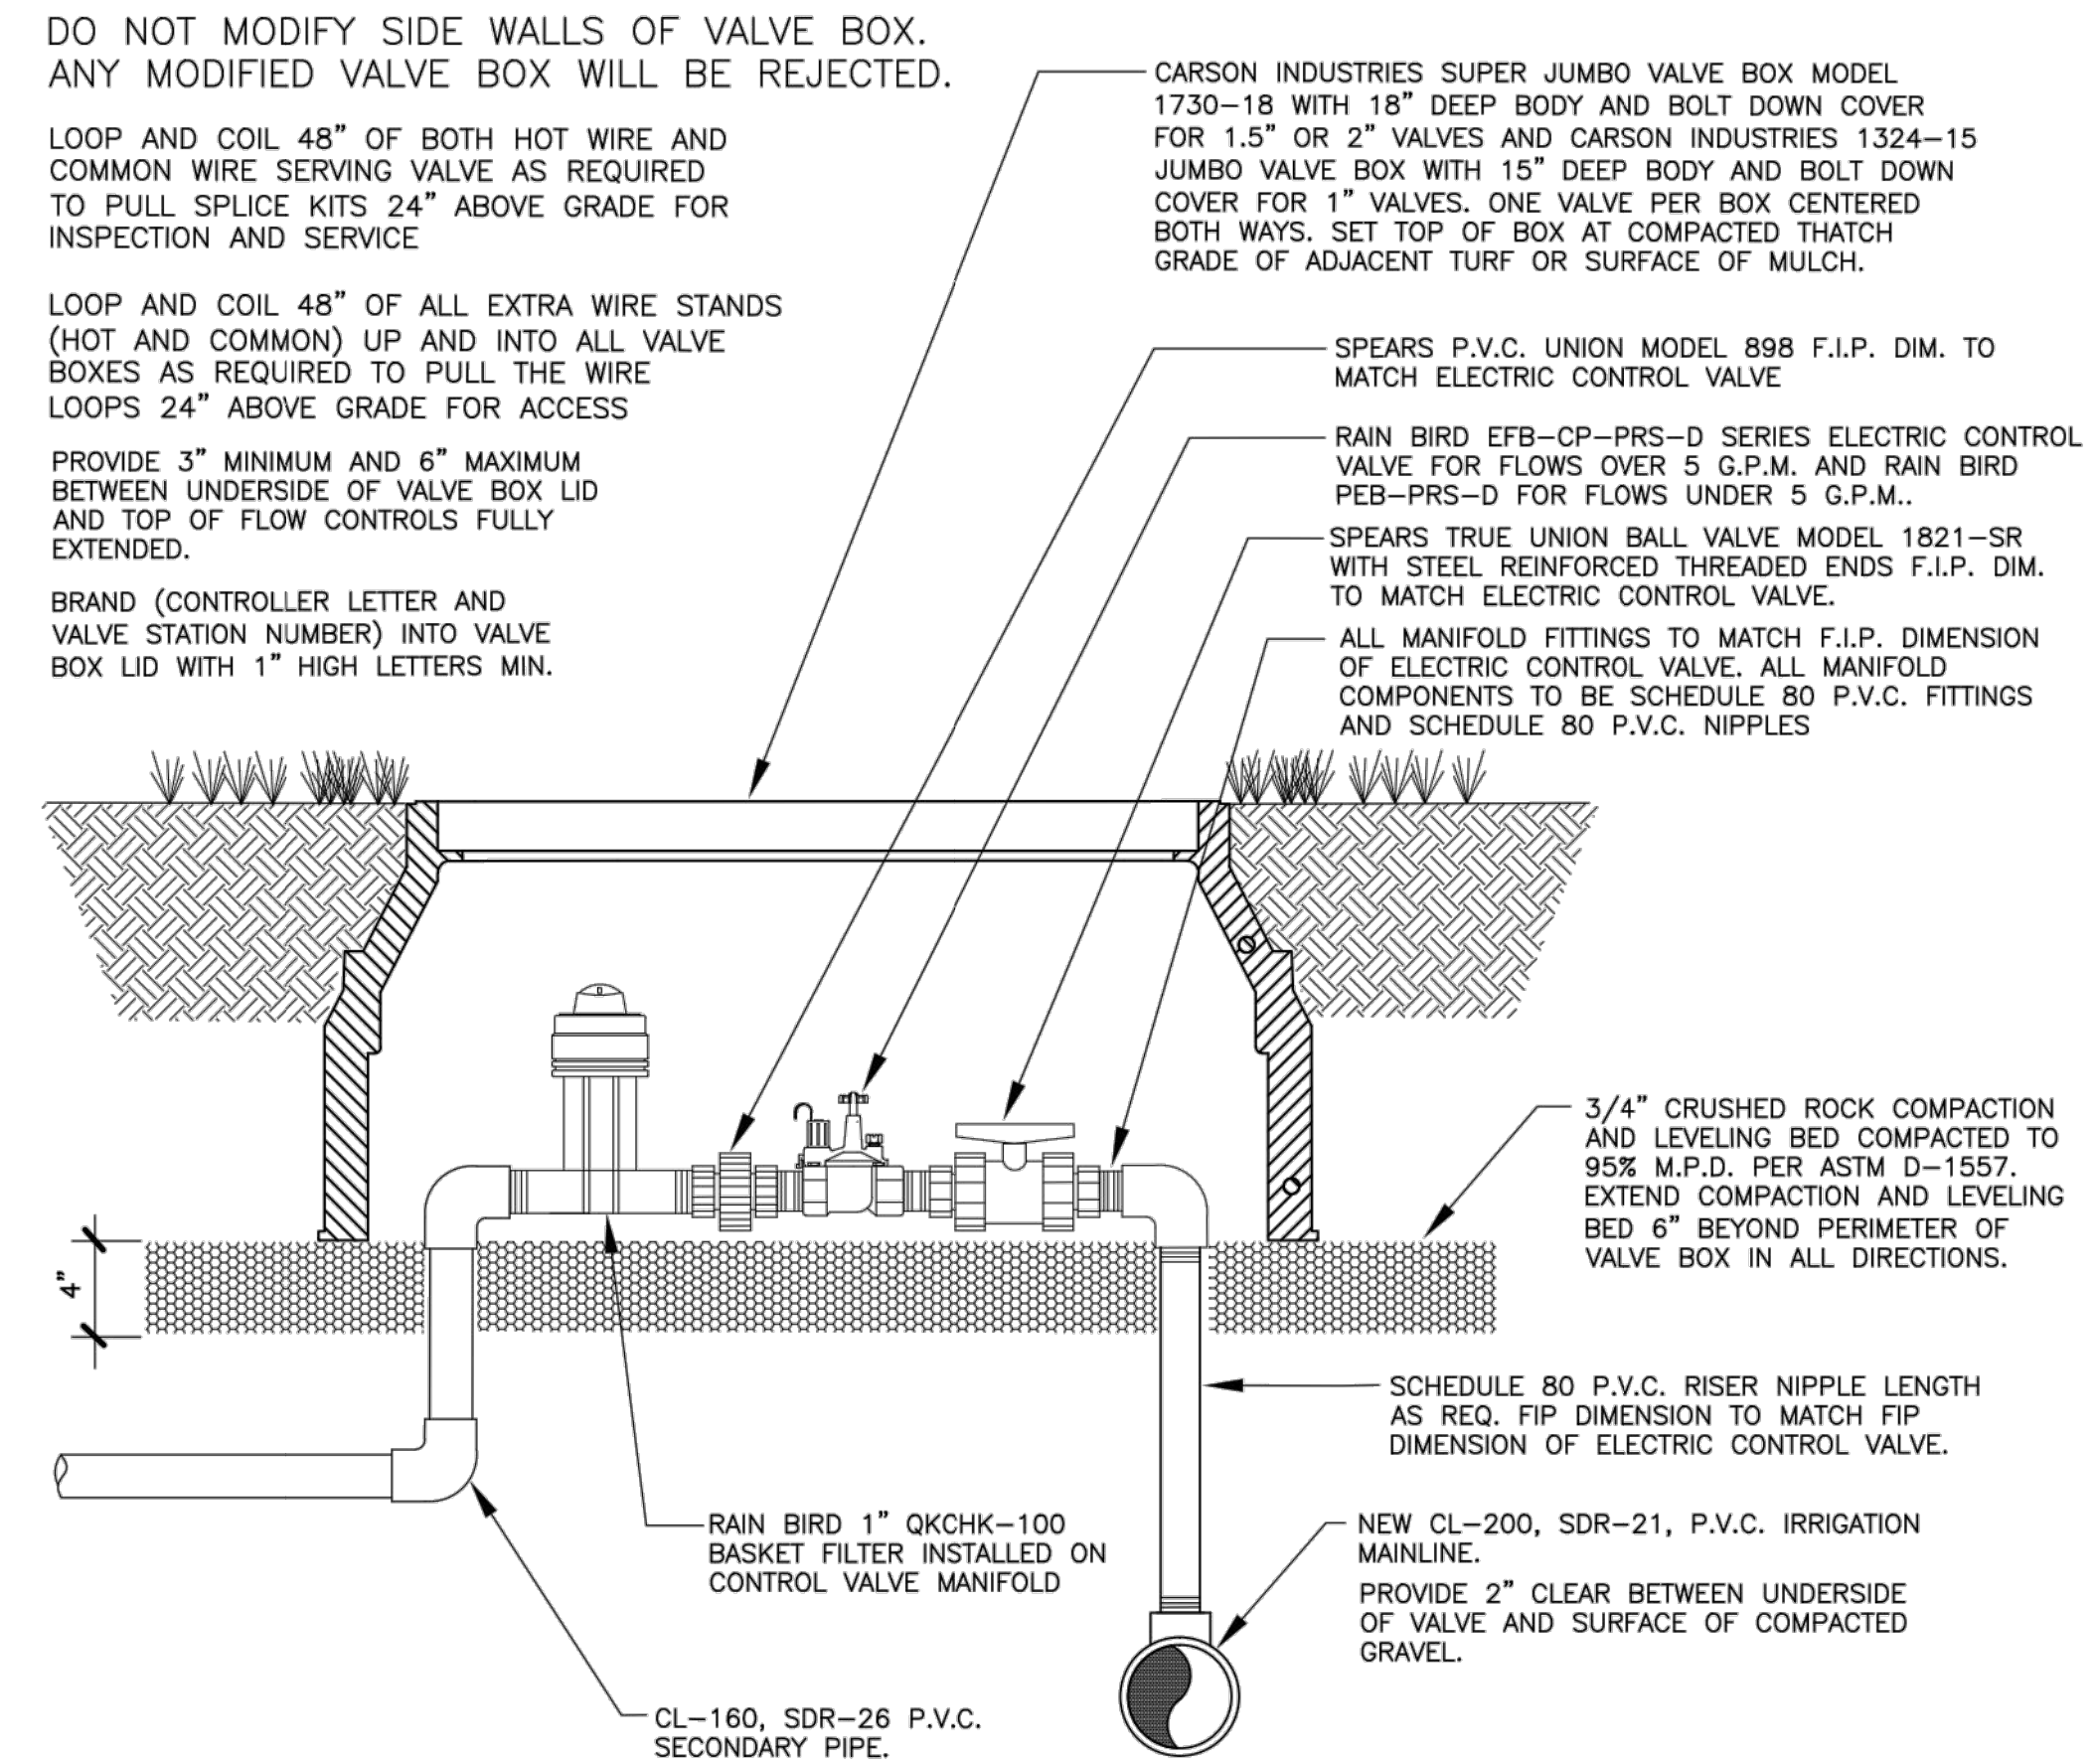


B ELECTRIC CONTROL VALVE FOR NETAFIM CV DRIPPER LINE ZONES
IR4 NO SCALE

Controller Specification Summary:


CONTROLLER (C) CONTRACTOR TO SUPPLY AND INSTALL ONE NEW TORO SENTINEL SERIES TWELVE (12) STATION CONTROLLER LESS KEY PAD MODEL SBW[X]PS1U OR SBW[X]PS1-WORM

CONTRACTOR TO ARRANGE AND PAY FOR C.P.S. DISTRIBUTORS TO CONDUCT A SITE SURVEY ANTENNA SET UP TO MAXIMIZE SIGNAL QUALITY FOR EACH TORO SENTINEL CONTROLLER INSTALLED. COORDINATE SET UP AS REQUIRED WITH MANUFACTURER'S REPRESENTATIVE. CONTACT BRANDON GULLY AT C.P.S. DISTRIBUTORS AT (303)-961-6959.

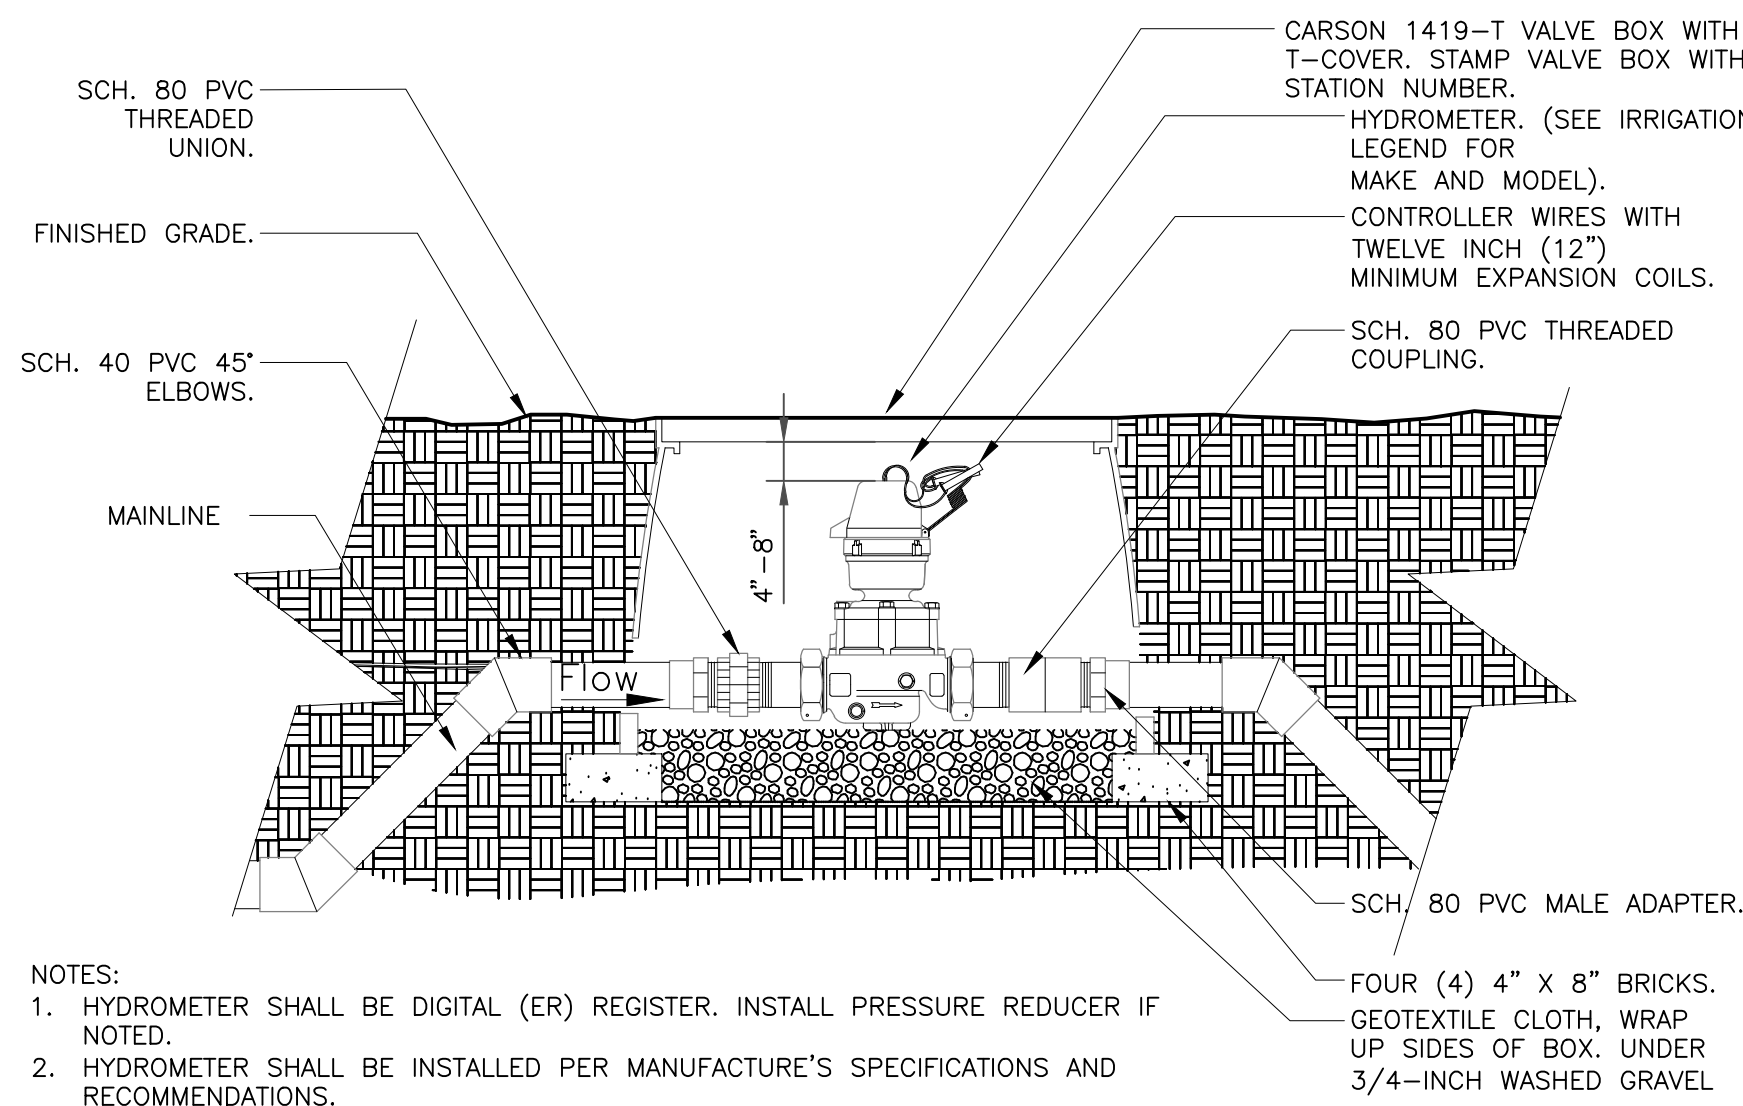


- NOTES:
- HYDROMETER SHALL BE DIGITAL (ER) REGISTER. INSTALL PRESSURE REDUCER IF NOTED.
 - HYDROMETER SHALL BE INSTALLED PER MANUFACTURER'S SPECIFICATIONS AND RECOMMENDATIONS.
 - HYDROMETER WIRE SHALL BE PER THE IRRIGATION CONTROLLER MANUFACTURER'S SPECIFICATIONS.
 - ALL WIRE RUNS SHALL BE CONTINUOUS WITHOUT ANY SPLICES. WIRE CONNECTIONS SHALL BE MADE USING DBR-Y/6 OR APPROVED EQUAL.
 - DIRECT WIRE TO CONTROLLER. DO NOT UTILIZE DECODERS.

E HYDROMETER
1 1/2" = 1'-0" FX-IR-FX-AUXEQ-04

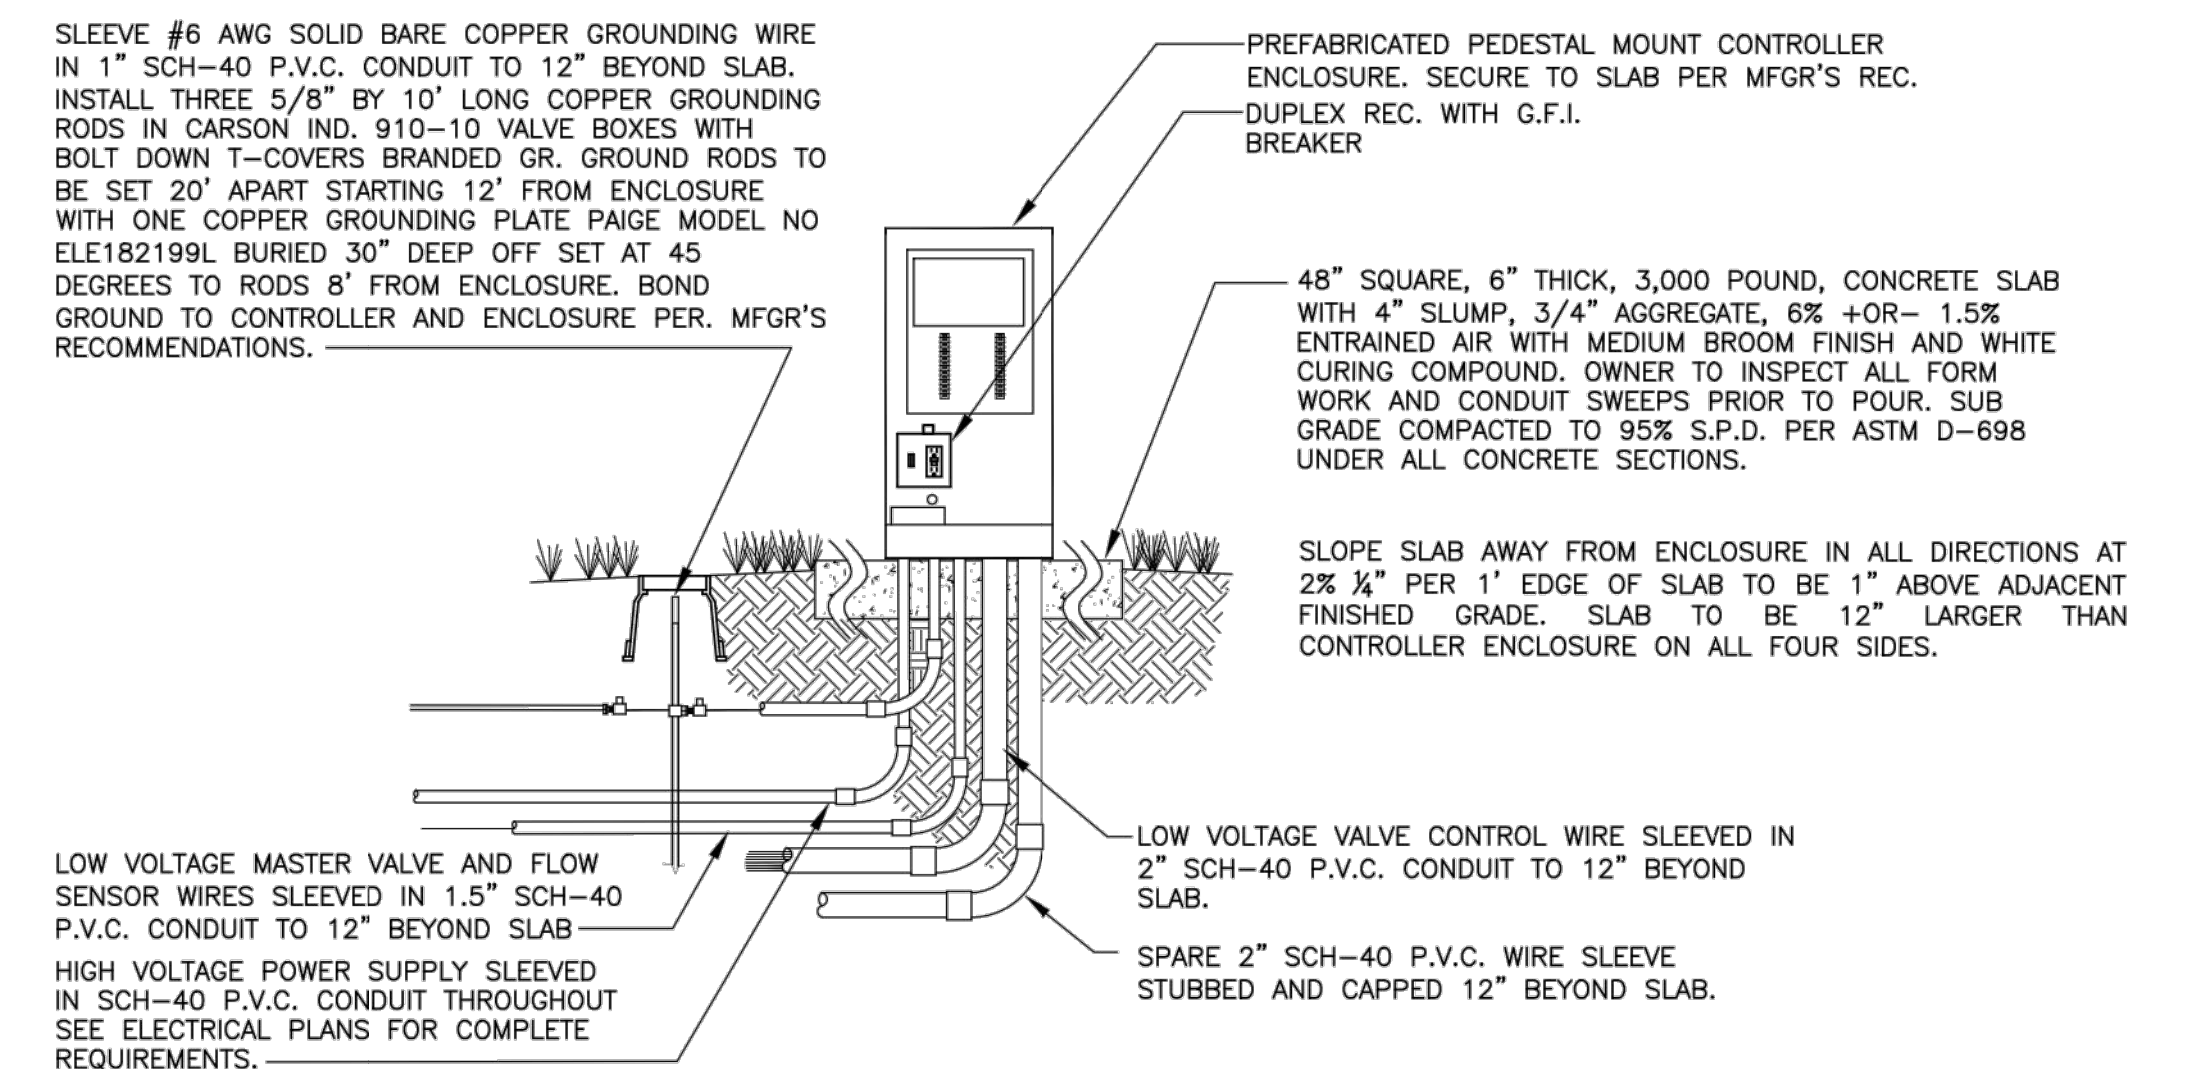

D CONTROLLER AND ENCLOSURE ELEVATION
IR4 NO SCALE

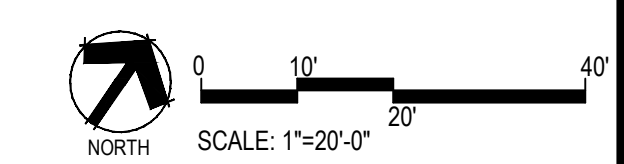

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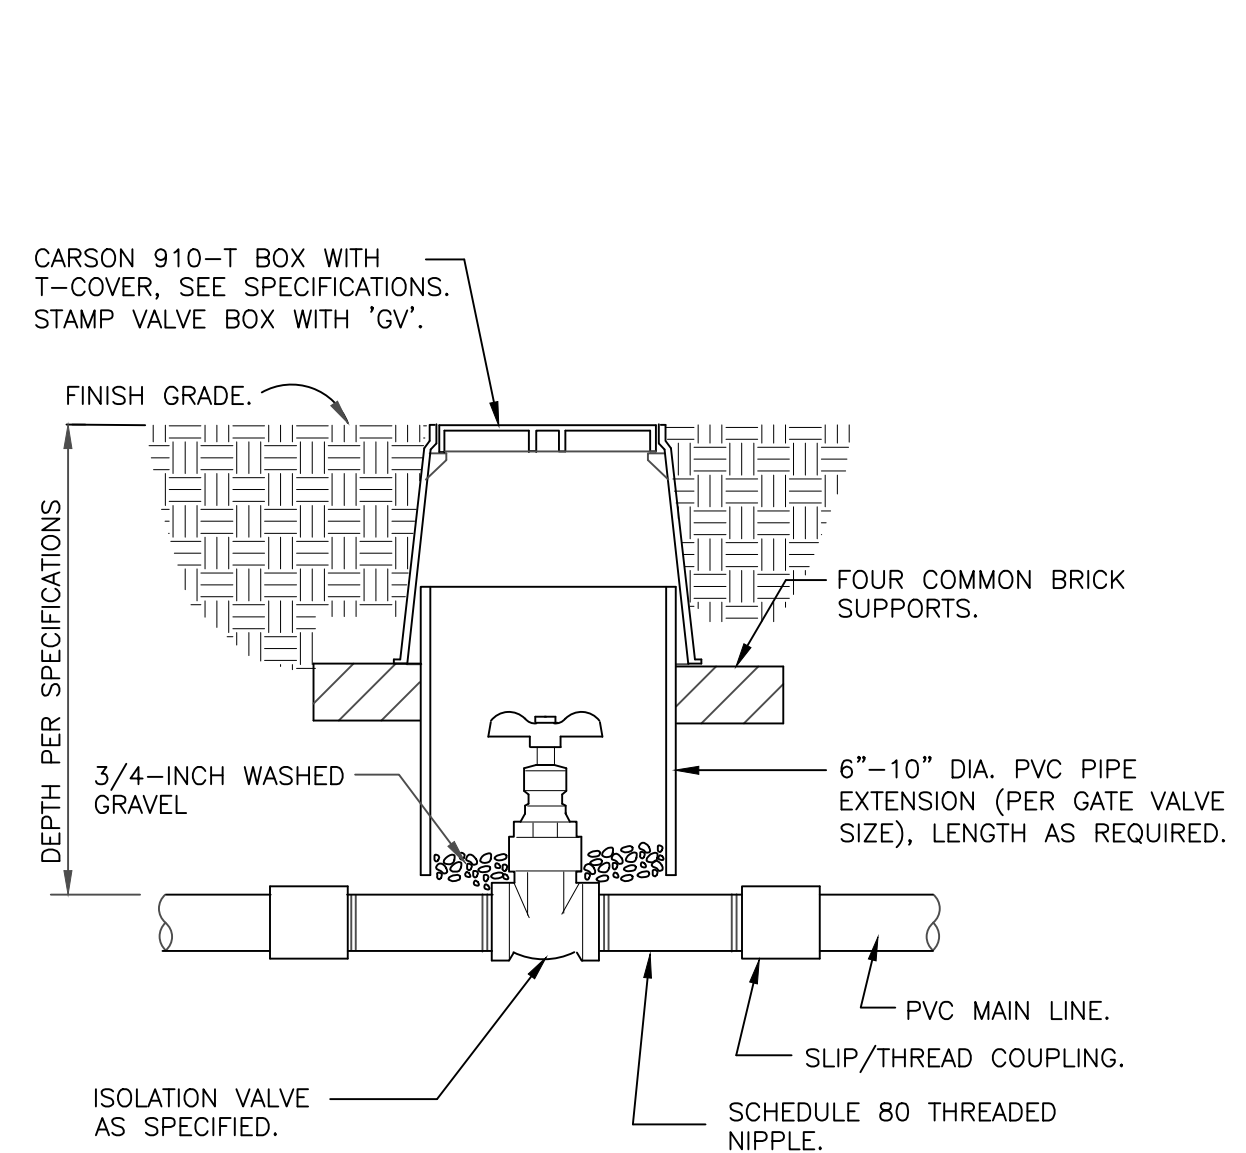
TRAILS AT CROWFOOT
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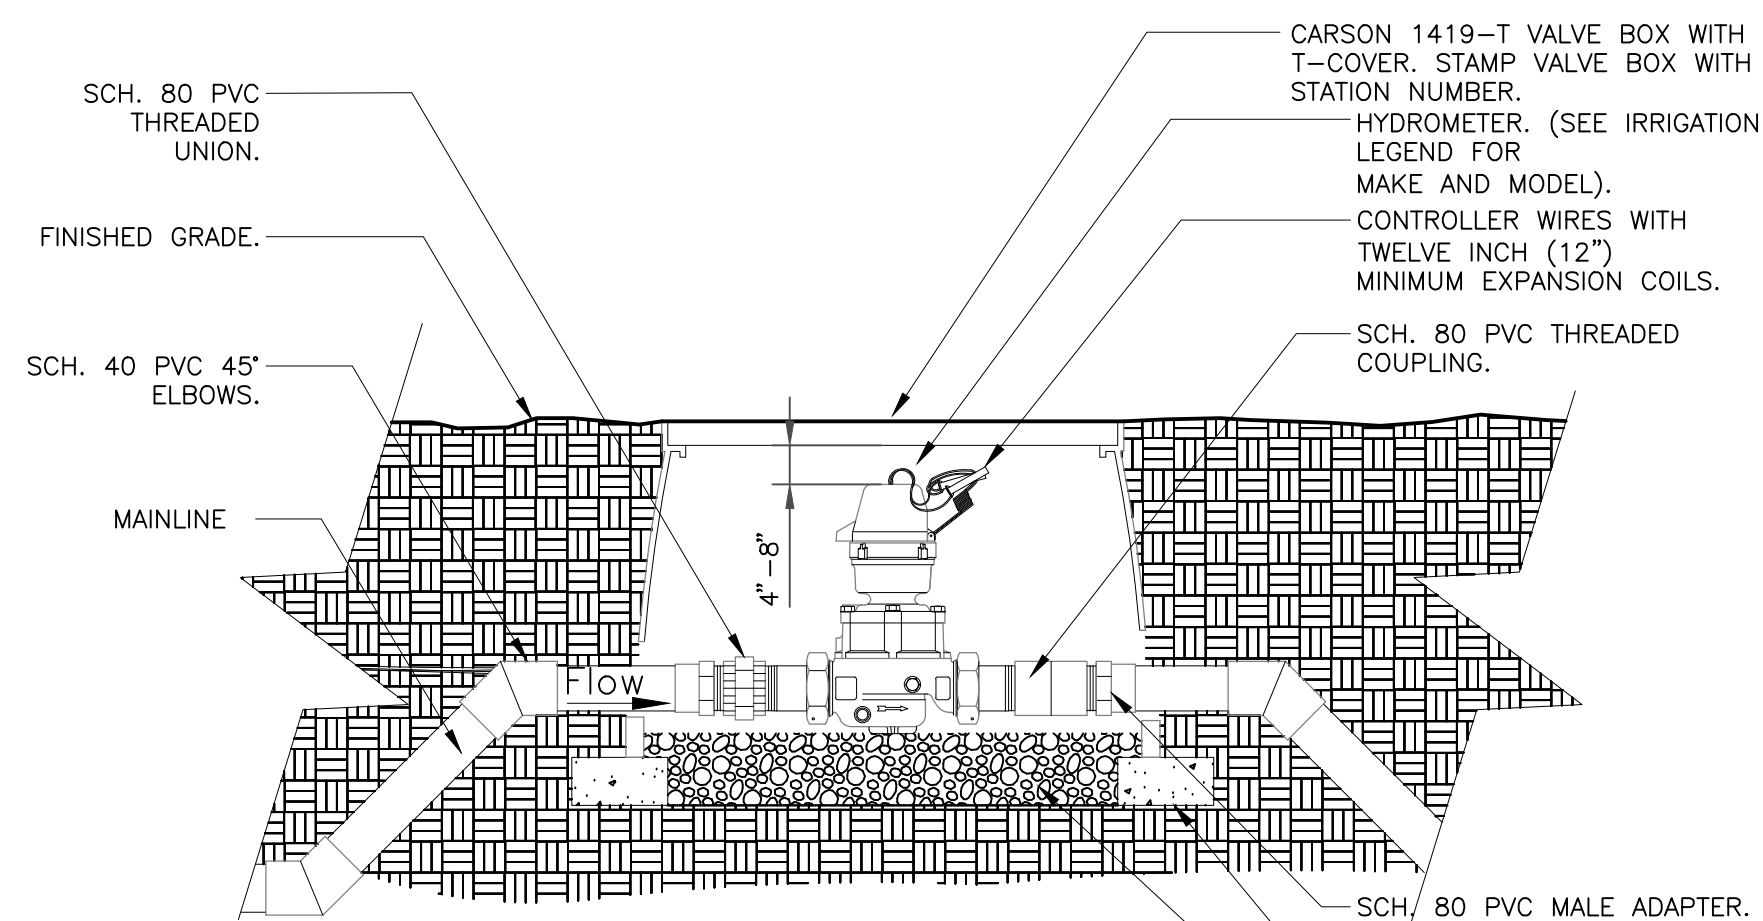
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Sheet Name
IRRIGATION DETAILS

Sheet Number
IR2.1




ISOLATION GATE VALVE
 1 1/2" = 1'-0"
 328406.33-01




HYDROMETER
 1 1/2" = 1'-0"
 FX-IR-FX-AUXEQ-04

NOTES:
 1. HYDROMETER SHALL BE DIGITAL (ER) REGISTER. INSTALL PRESSURE REDUCER IF NOTED.
 2. HYDROMETER SHALL BE INSTALLED PER MANUFACTURE'S SPECIFICATIONS AND RECOMMENDATIONS.
 3. HYDROMETER WIRE SHALL BE PER THE IRRIGATION CONTROLLER MANUFACTURER'S SPECIFICATIONS.
 4. ALL WIRE RUNS SHALL BE CONTINUOUS WITHOUT ANY SPLICES. WIRE CONNECTIONS SHALL BE MADE USING DBR-Y/6 OR APPROVED EQUAL.
 5. DIRECT WIRE TO CONTROLLER, DO NOT UTILIZE DECODERS.

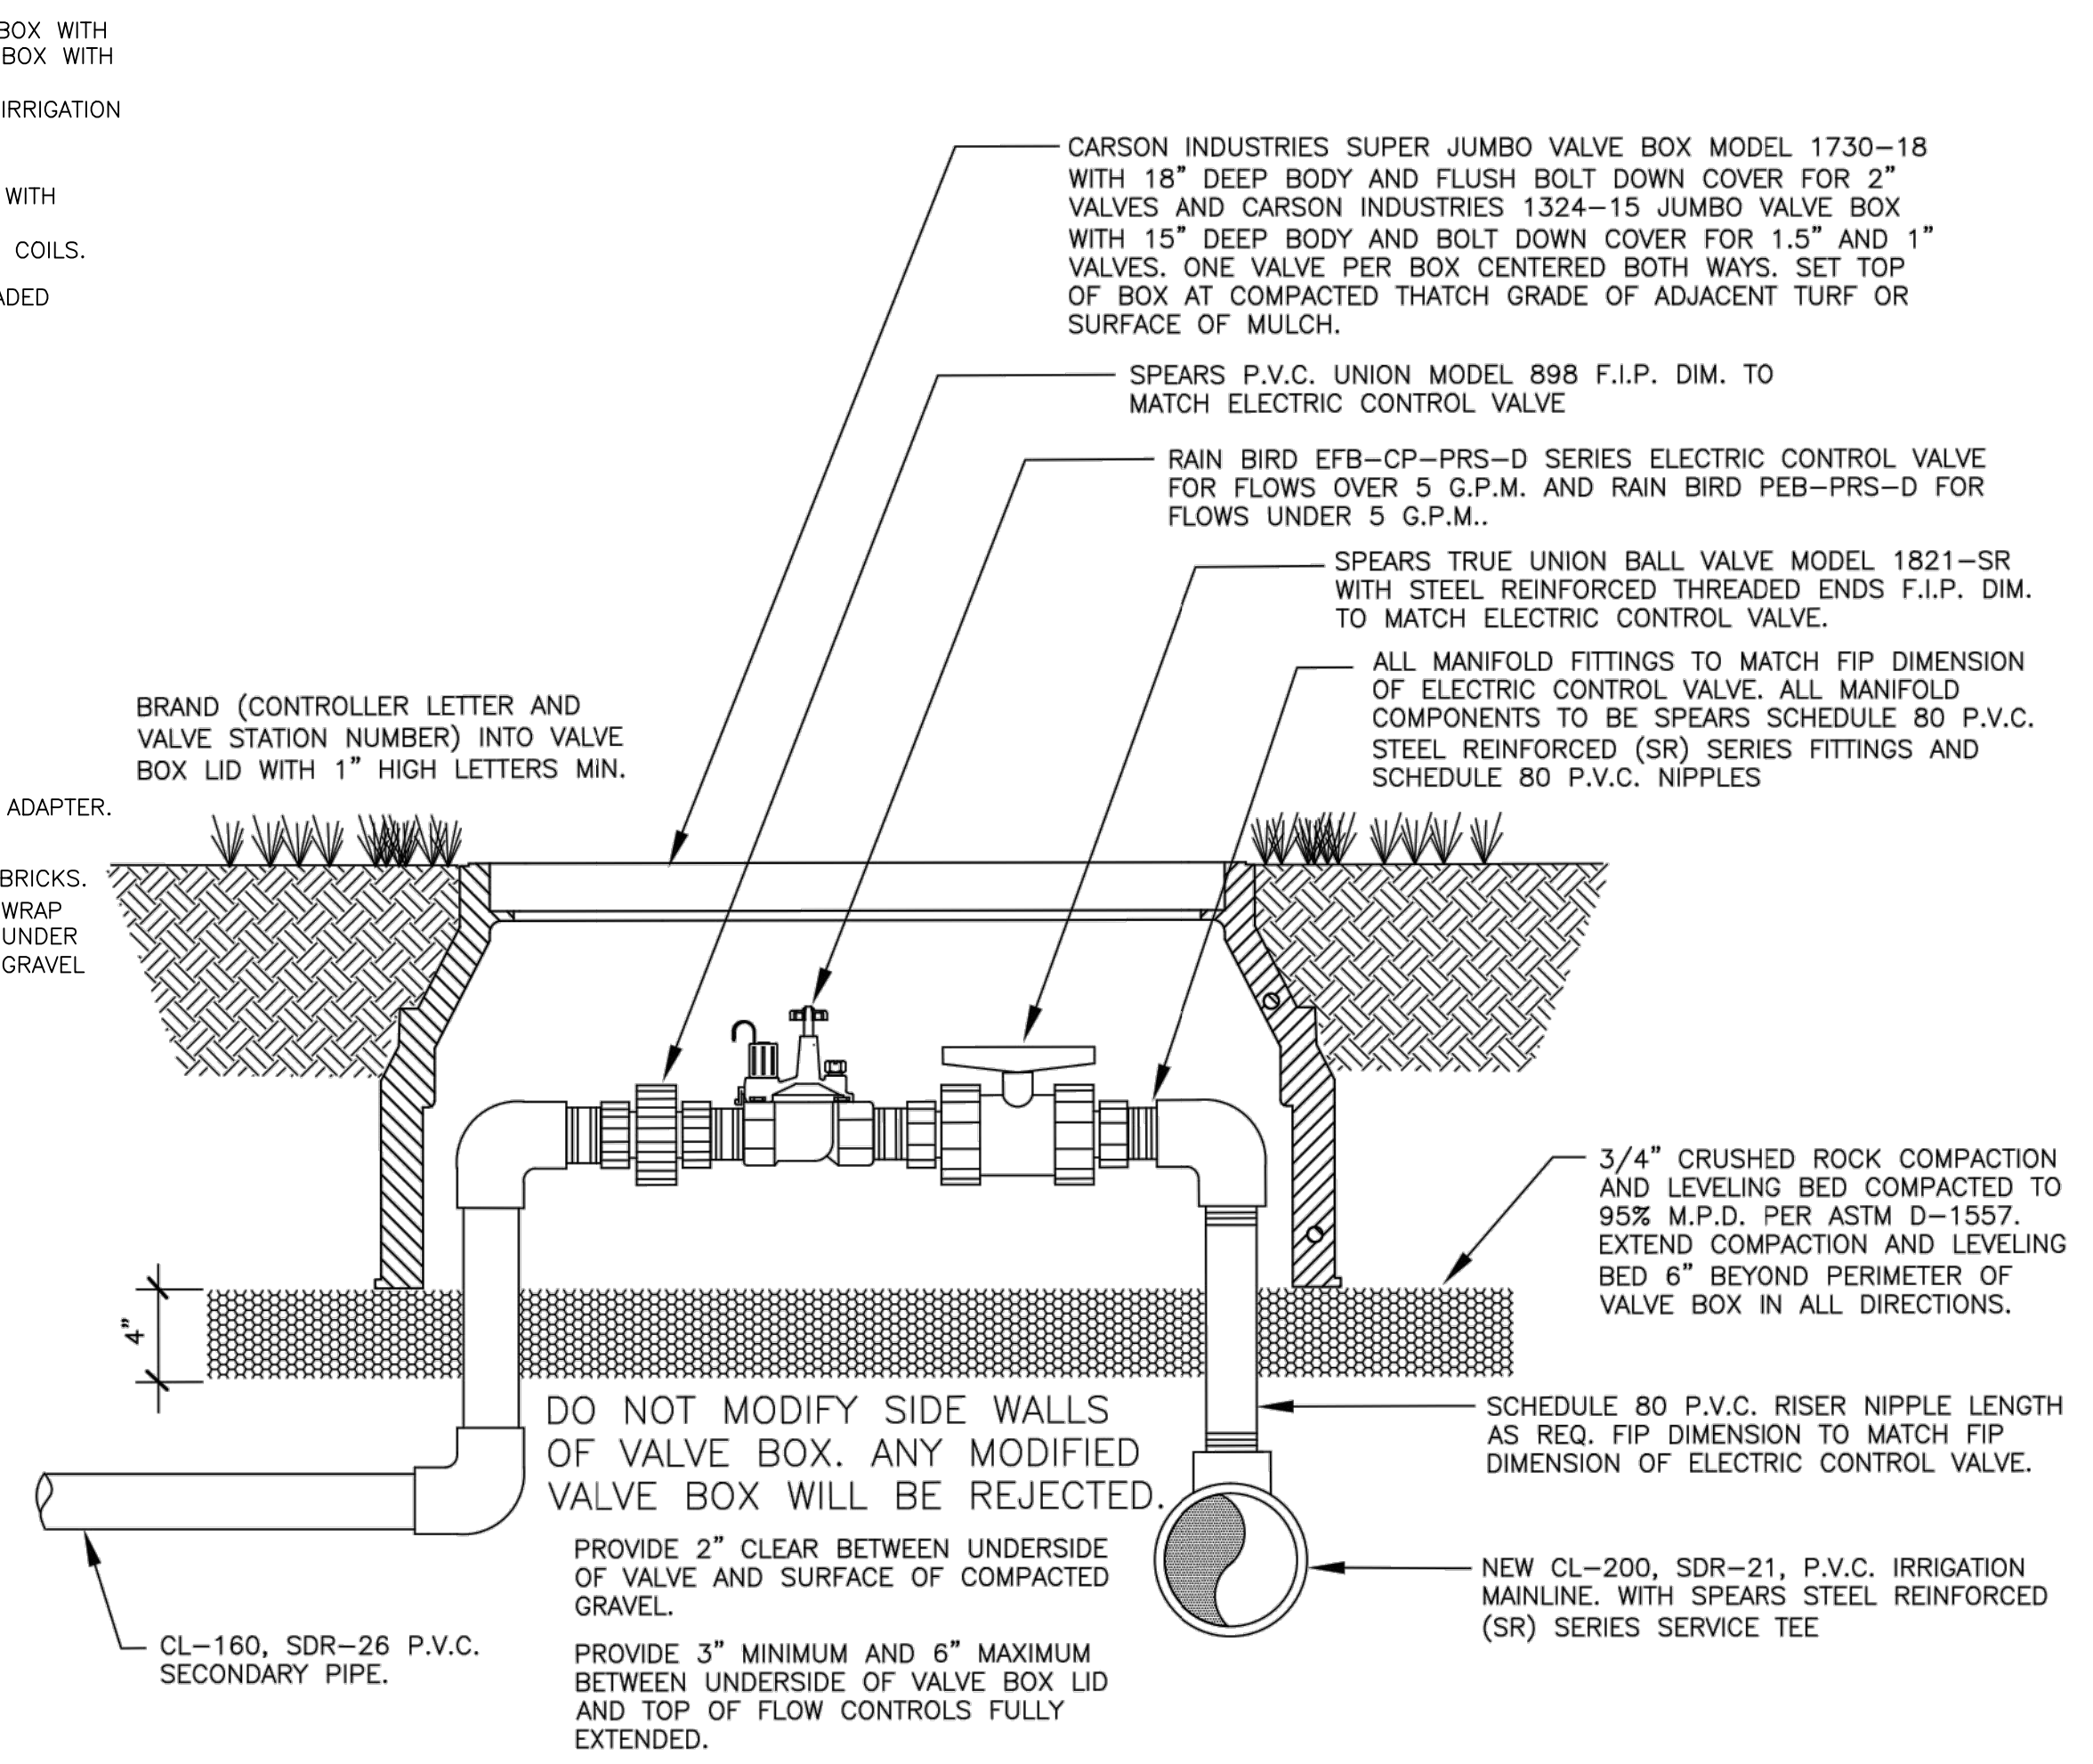


B ELECTRIC CONTROL VALVE FOR SPRAY ZONES
 1.3 NO SCALE

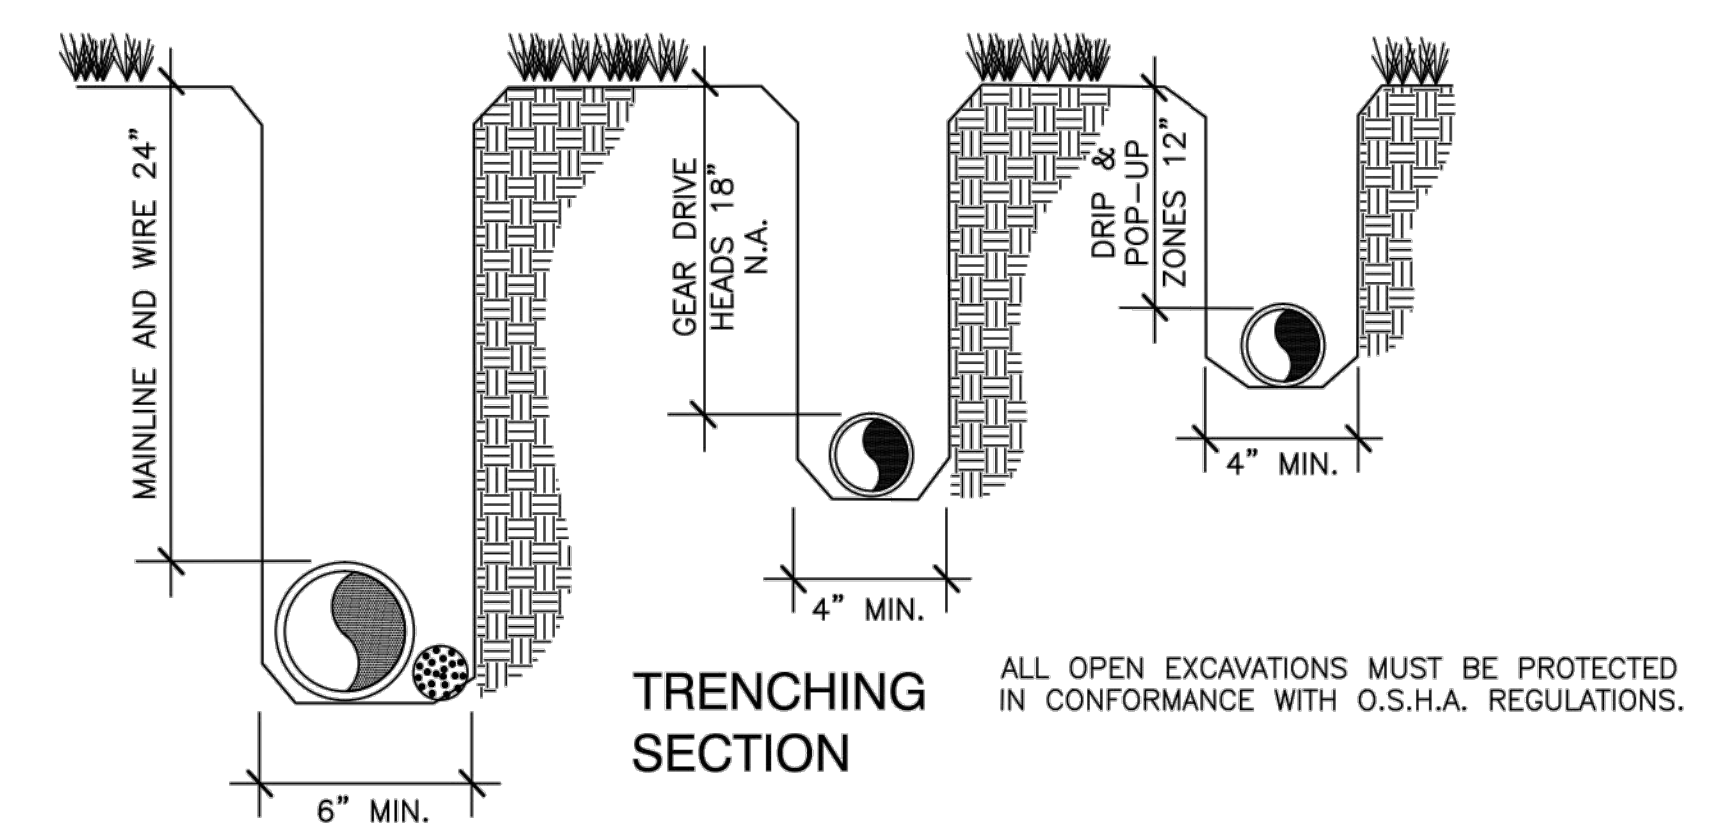


C IRRIGATION TRENCHING
 1.3 NO SCALE

TRENCH DEPTH ARE MINIMUMS WITH A MAXIMUM OVER EXCAVATION OF 2". ALL TRENCHES ARE TO BE CLEANED WITH "CRUMBER" ATTACHMENT OR BY HAND PRIOR TO INSTALLING PIPE PROVIDING A SMOOTH AND UNIFORM BEDDING SURFACE. REMOVE ANY EXPOSED ROCK OR DEBRIS FROM TRENCH BOTTOM OR WALLS PRIOR TO INSTALLING PIPE AND OR WIRE.
 ALL WIRE TRENCHES AND RELATED EXCAVATIONS SHALL BE MECHANICALLY COMPACTED IN 8" LIFTS MAXIMUM. TO 90% S.P.D. PER ASTM D-698 IN ALL LANDSCAPE AREAS.
 SECONDARY PIPING CAN BE MECHANICALLY OR HYDRAULICALLY COMPACTED TO MATCH THE DENSITY OF ADJACENT UNDISTURBED SOIL.
 BACKFILL, COMPACTION, FINE GRADE AND SURFACE RESTORATION INCLUDING FINE GRADE AND CLEAN UP MUST BE ONGOING THROUGHOUT CONSTRUCTION. NO MORE THAN THREE SECONDARY ZONES AND 200 LIN. FT. OF TRENCH CAN BE OPENED UP AT ONE TIME. NO ADDITIONAL SECONDARY OR WIRE TRENCHING WILL BE AUTHORIZED UNTIL THE BACKFILL, COMPACTION AND RESTORATION OF CURRENTLY OPEN TRENCHES AND RELATED EXCAVATIONS IS IN PROGRESS.

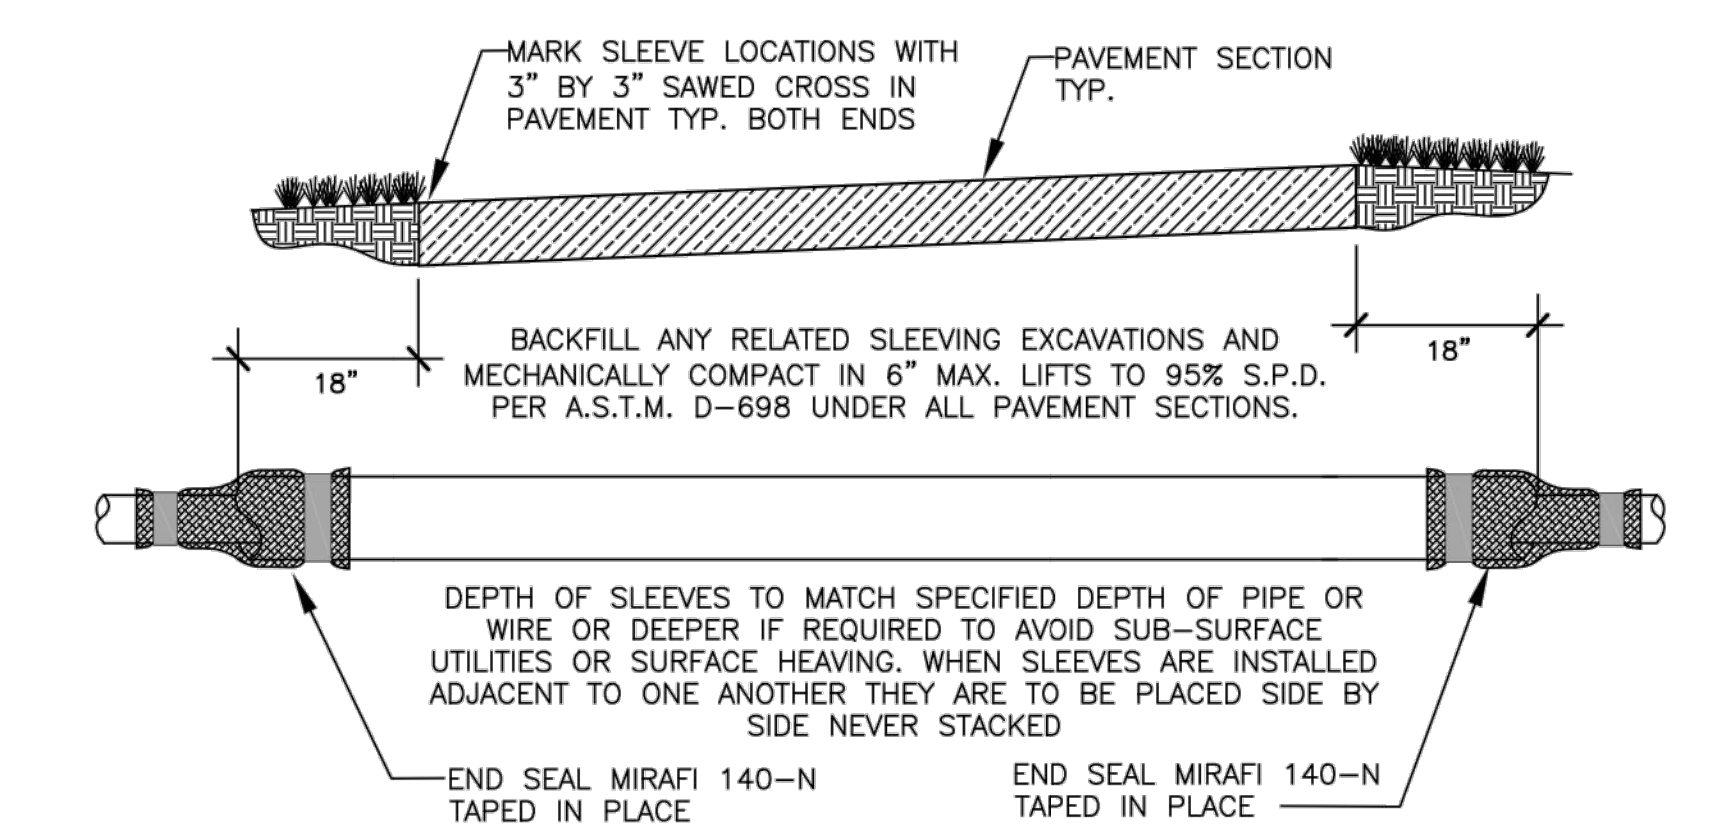

D IRRIGATION SLEEVING
 1.3 NO SCALE

SLEEVING SHALL BE S.I.D.R.-11.5 H.D.P.E. INSTALLED BY DIRECTIONAL BORING UNDER PIKES PEAK DRIVE AND CL-200 P.V.C. INSTALLED BY DIRECTIONAL BORING UNDER NEW CONCRETE TRAIL. ALL SLEEVES ARE 3".
 SLEEVING WILL BE MEASURED FROM THE POINT WHERE THE MAINLINE PIPE, SECONDARY PIPE OR WIRE ENTER THE SLEEVE (AT THE SPECIFIED DEPTH) TO THE POINT WHERE THE MAINLINE PIPE, SECONDARY PIPE OR WIRE EXIT THE SLEEVE (AT THE SPECIFIED DEPTH). ANY ADDITIONAL PIPE OR BORING REQUIRED TO ACHIEVE THE SPECIFIED PIPE AND OR WIRE DEPTH AND ANY ADDITIONAL PIPE OR BORING REQUIRED TO RETURN TO THE SURFACE INCLUDING ANY AND ALL PULL PIPE WILL BE CONSIDERED AS A SUBSIDIARY OBLIGATION OF THE CONTRACTOR UNDER THE CONTRACT UNIT PRICE FOR SLEEVING AND WILL NOT BE PAID FOR SEPARATELY.
 ALL SURFACE RESTORATION (REQUIRED BY BORING AND SLEEVING OPERATIONS) INCLUDING BACKFILL, COMPACTION, FINE GRADE AND SOD PATCH OR NATIVE SEEDING WILL BE CONSIDERED AS A SUBSIDIARY OBLIGATION OF THE CONTRACTOR UNDER THE CONTRACT UNIT PRICE FOR SLEEVING AND WILL NOT BE PAID FOR SEPARATELY.
 ADJUST SLEEVING DEPTH AS REQUIRED TO AVOID SUBSURFACE UTILITIES AND OR TO AVOID SURFACE HEAVING. ANY ADDITIONAL PIPE OR BORING REQUIRED TO CARRY SLEEVING DEEPER WILL BE CONSIDERED AS A SUBSIDIARY OBLIGATION OF THE CONTRACTOR UNDER THE CONTRACT UNIT PRICE FOR SLEEVING AND WILL NOT BE PAID FOR SEPARATELY.

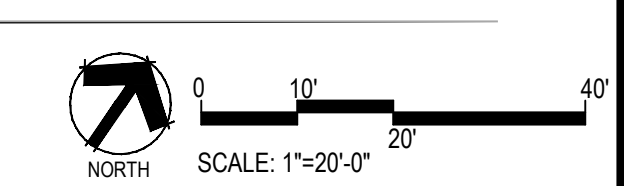

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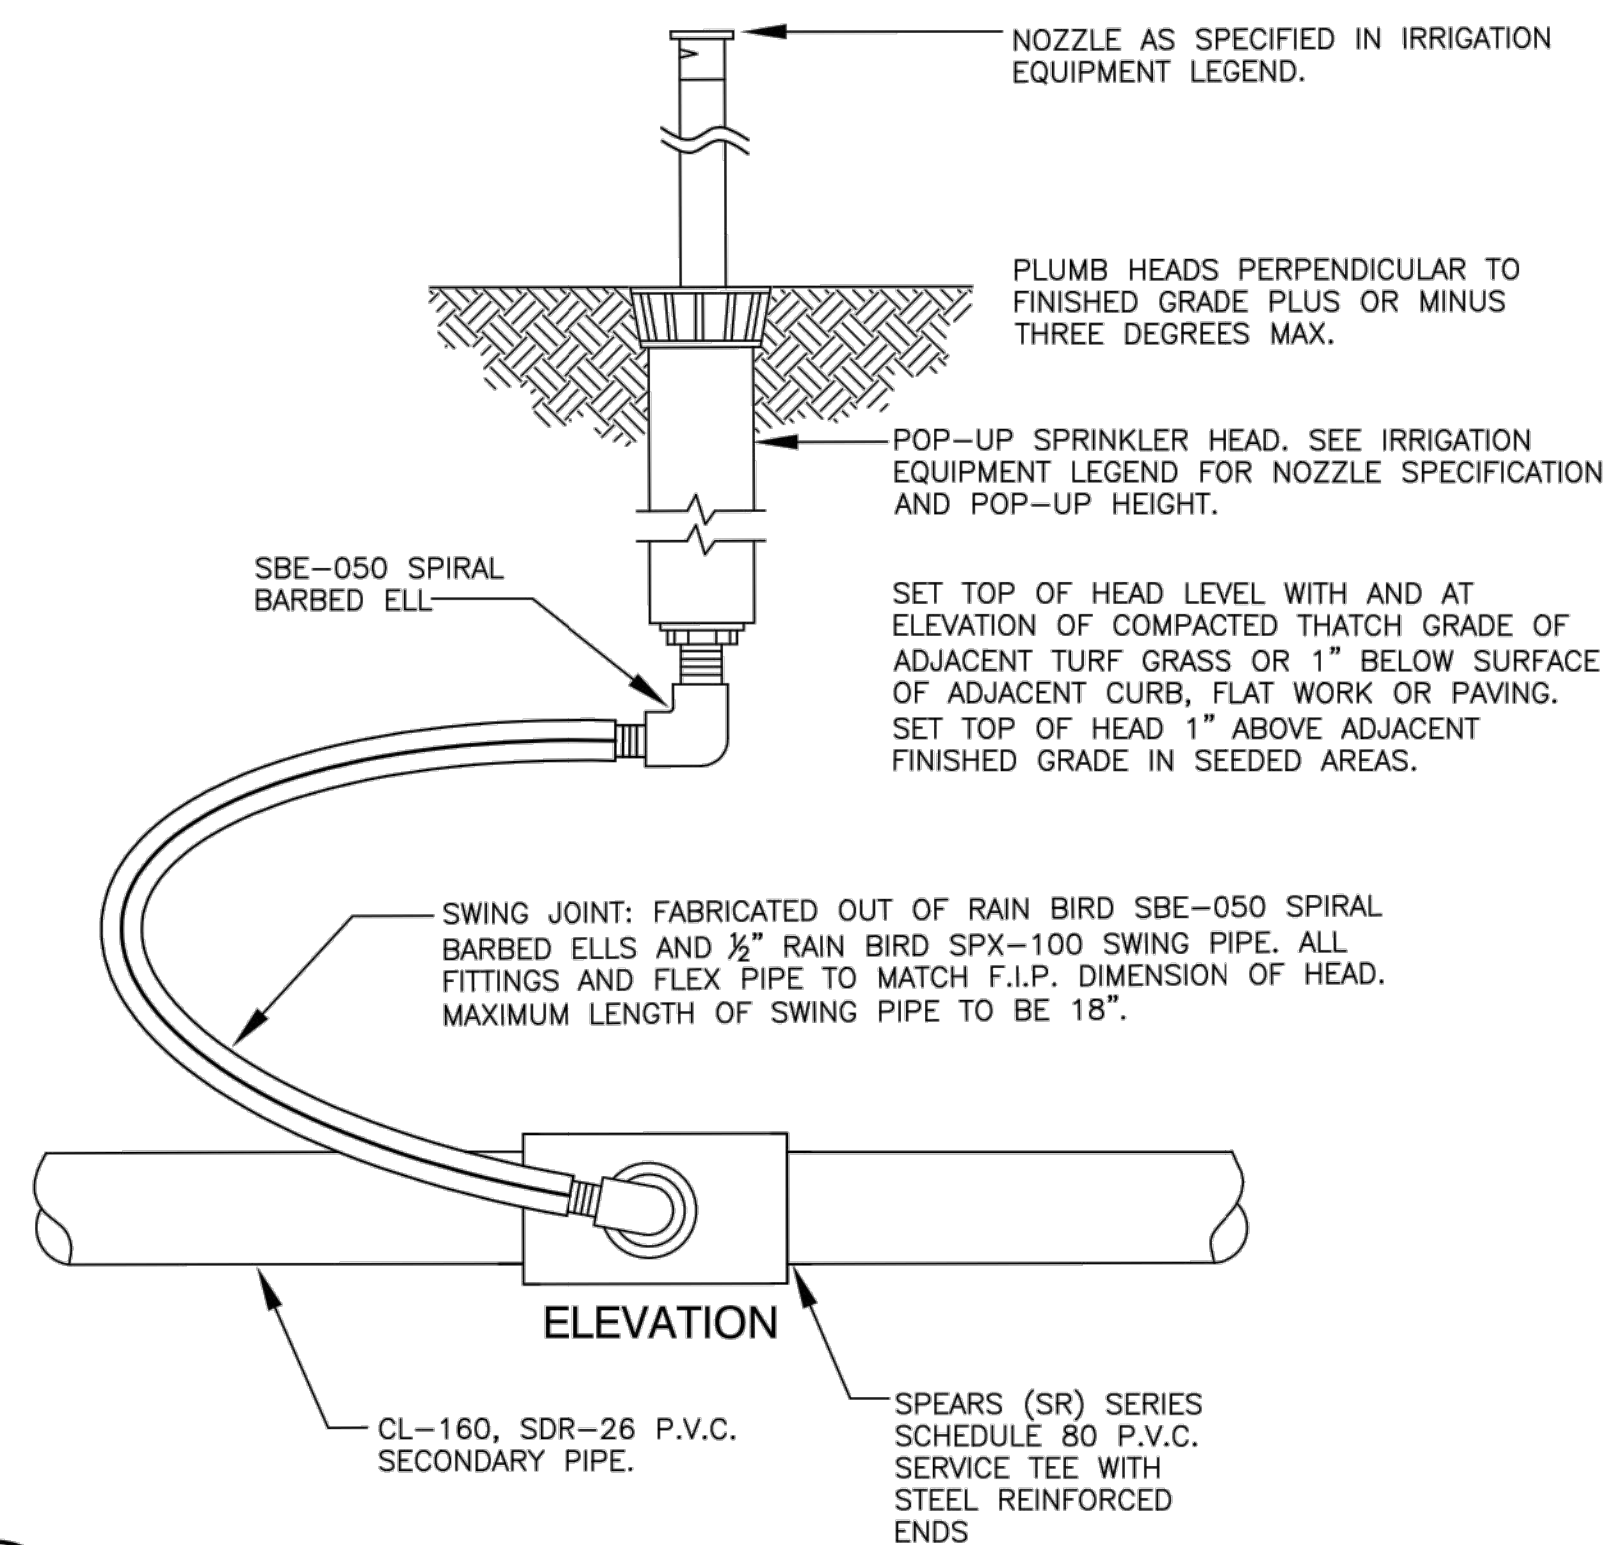
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 PARKER, COLORADO
 IRRIGATION PLANS

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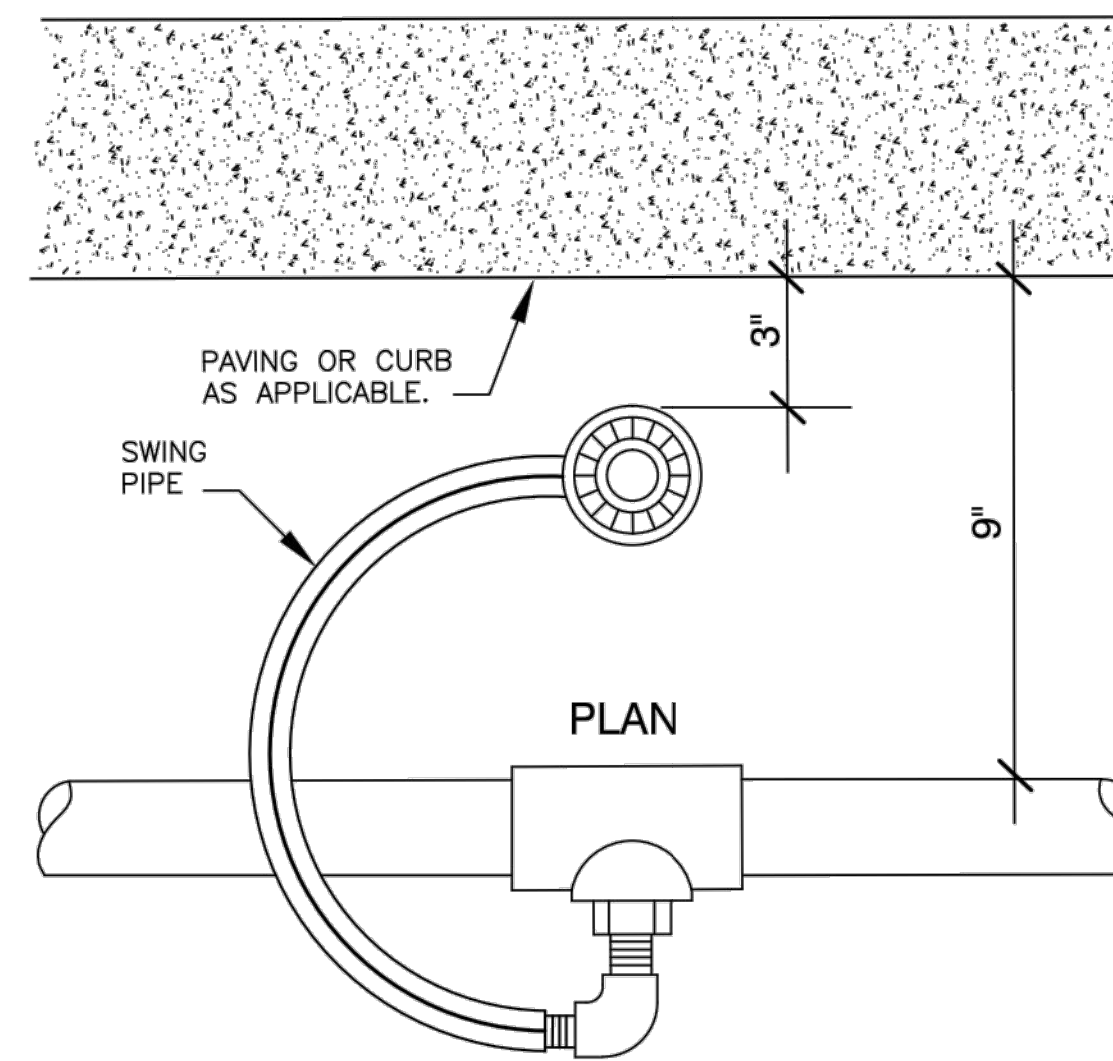
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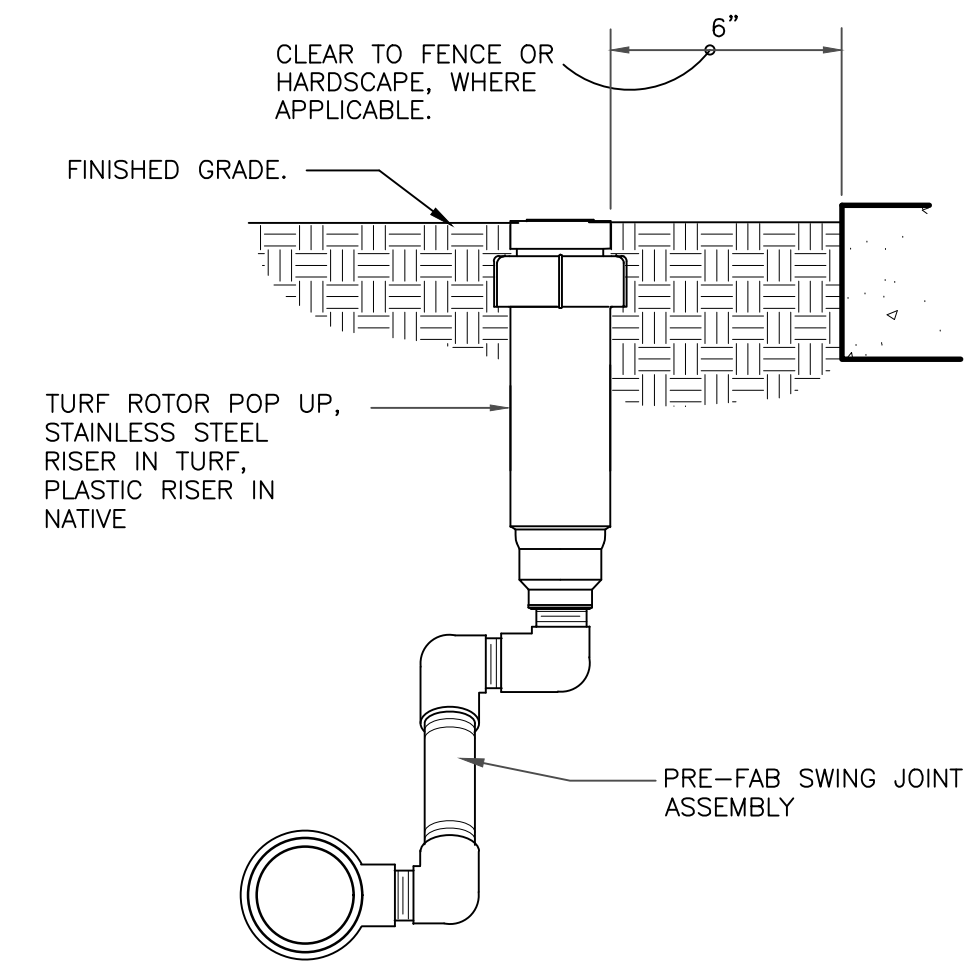
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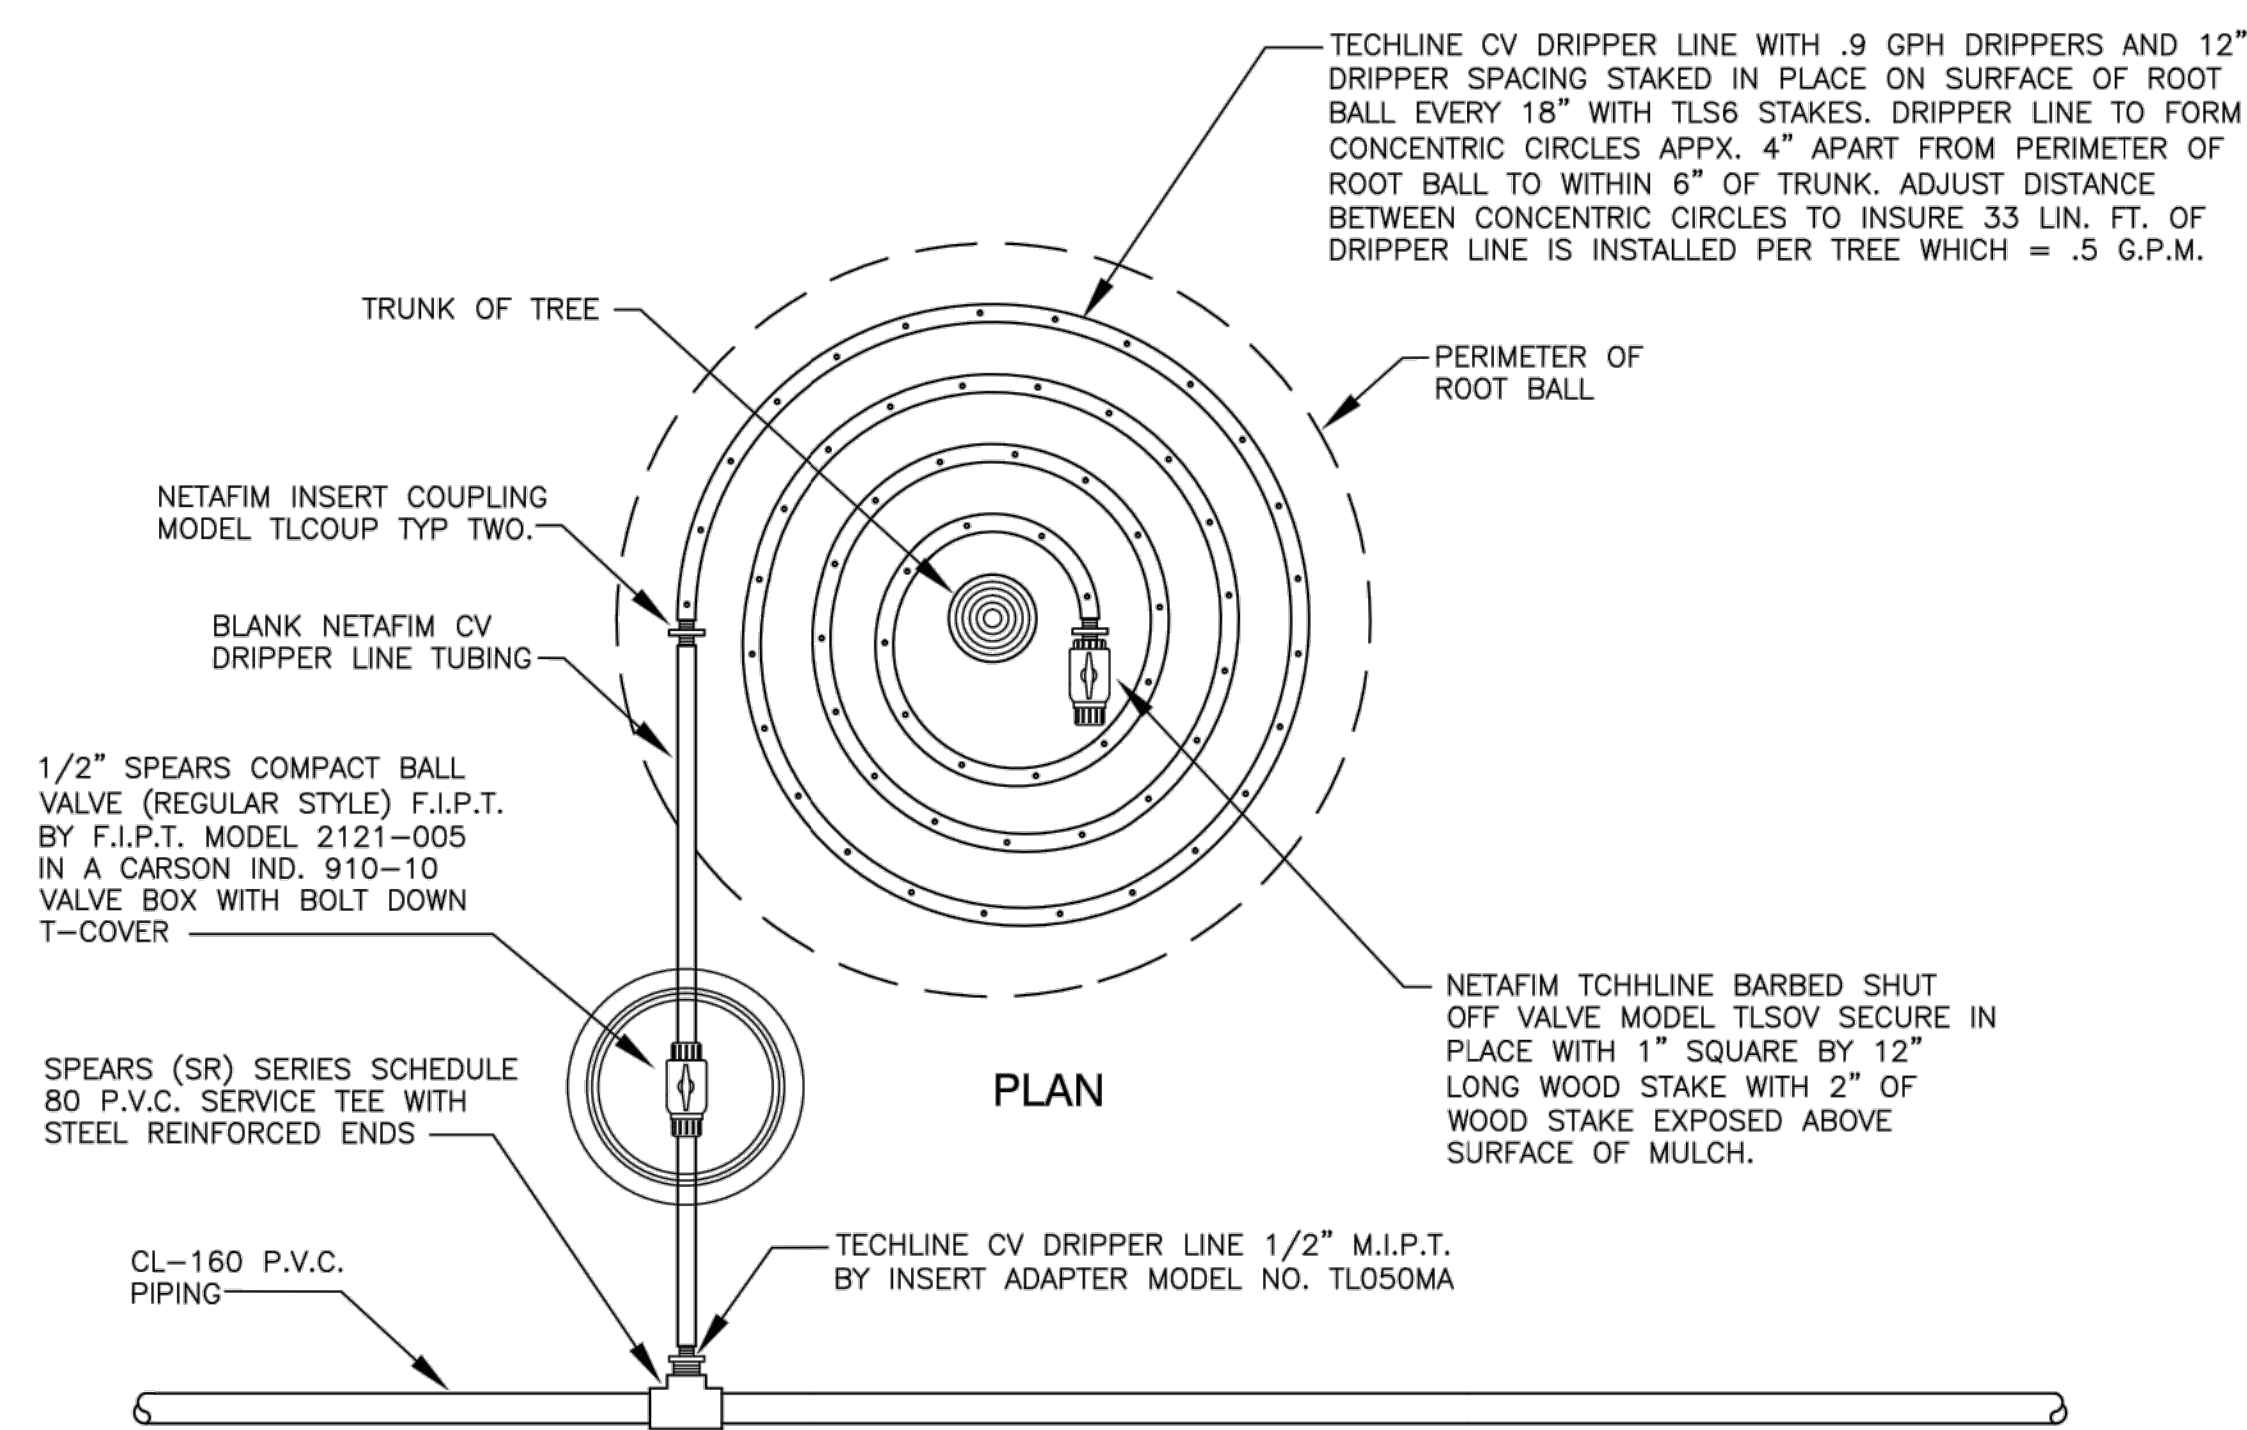
A
1.4 POP-UP SPRINKLER HEAD
NO SCALE




B
3" = 1'-0" GEAR-DRIVEN ROTOR ASSEMBLY




328403.16-01



B
1.4 CV DRIPPER LINE WITH FLUSH VALVE INSTALLATION FOR TREE IRRIGATION IN NATIVE AND MULCH AREAS
NO SCALE

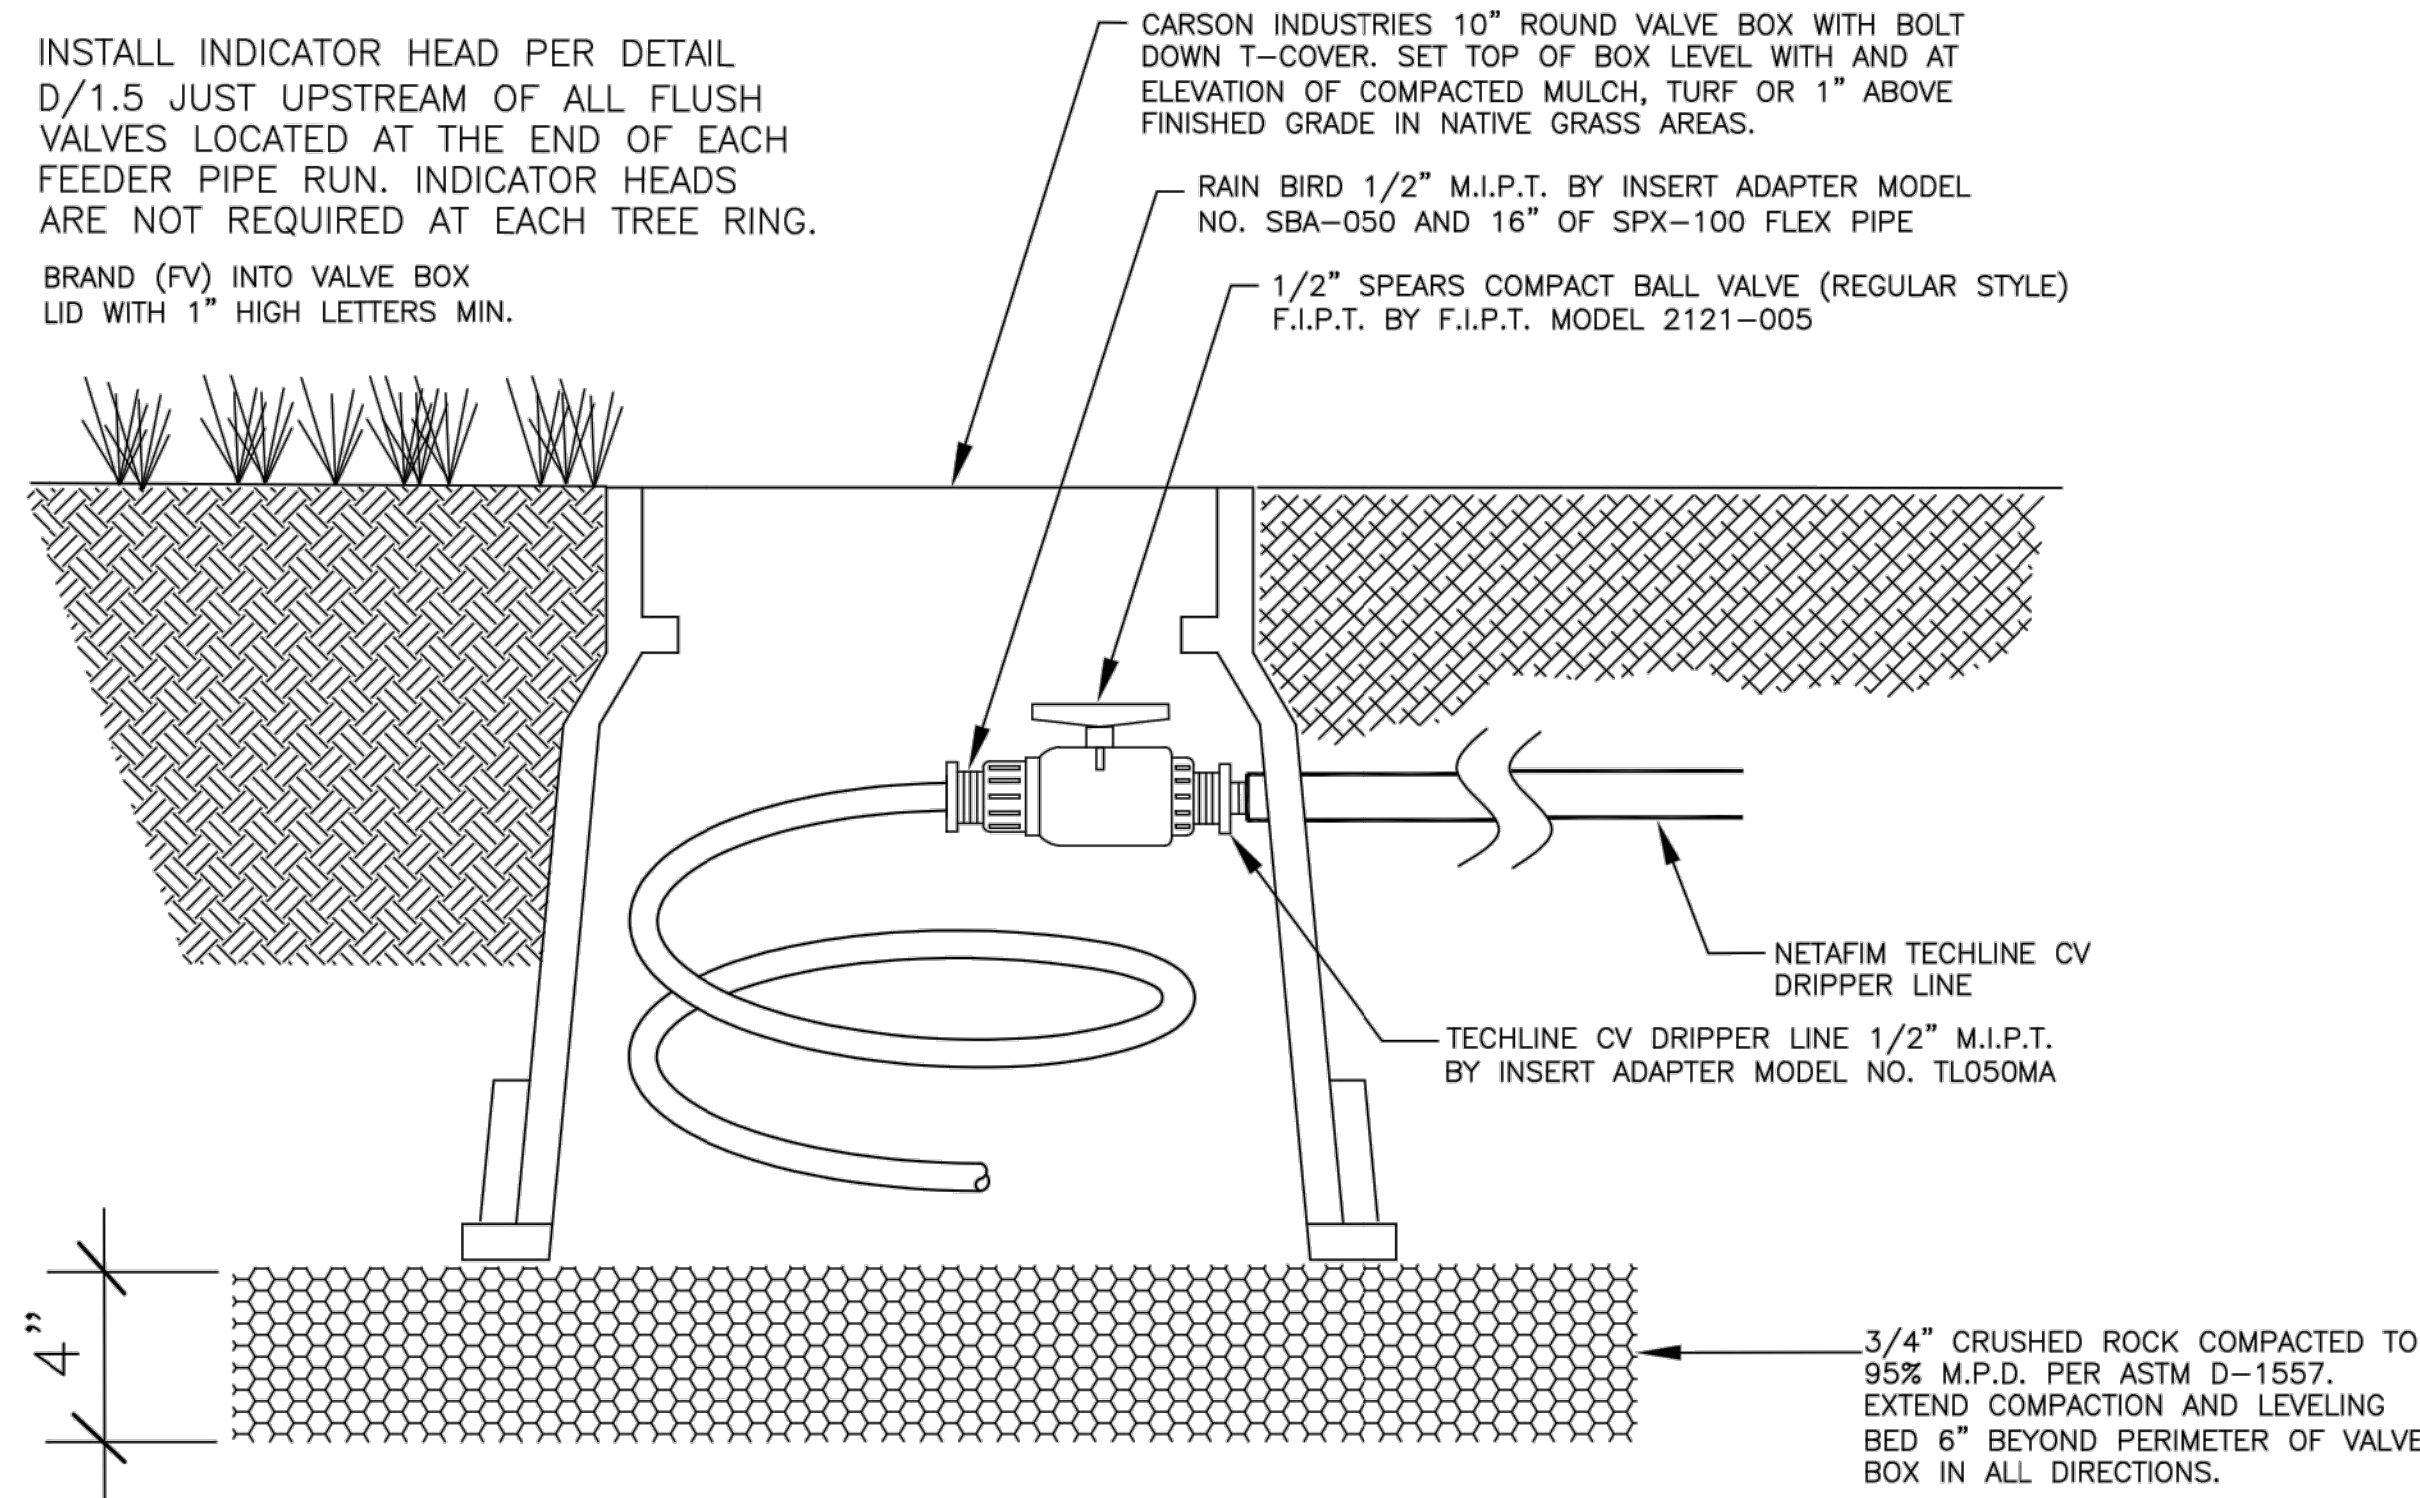

C
1.4 CV DRIPPER LINE AND FLUSH VALVE INSTALLATION FOR SINGLE DRIPPER LINE LOOP
NO SCALE

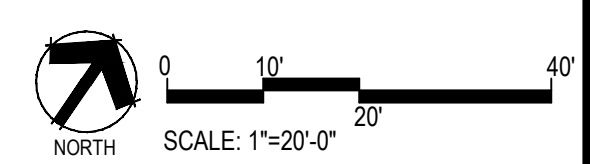

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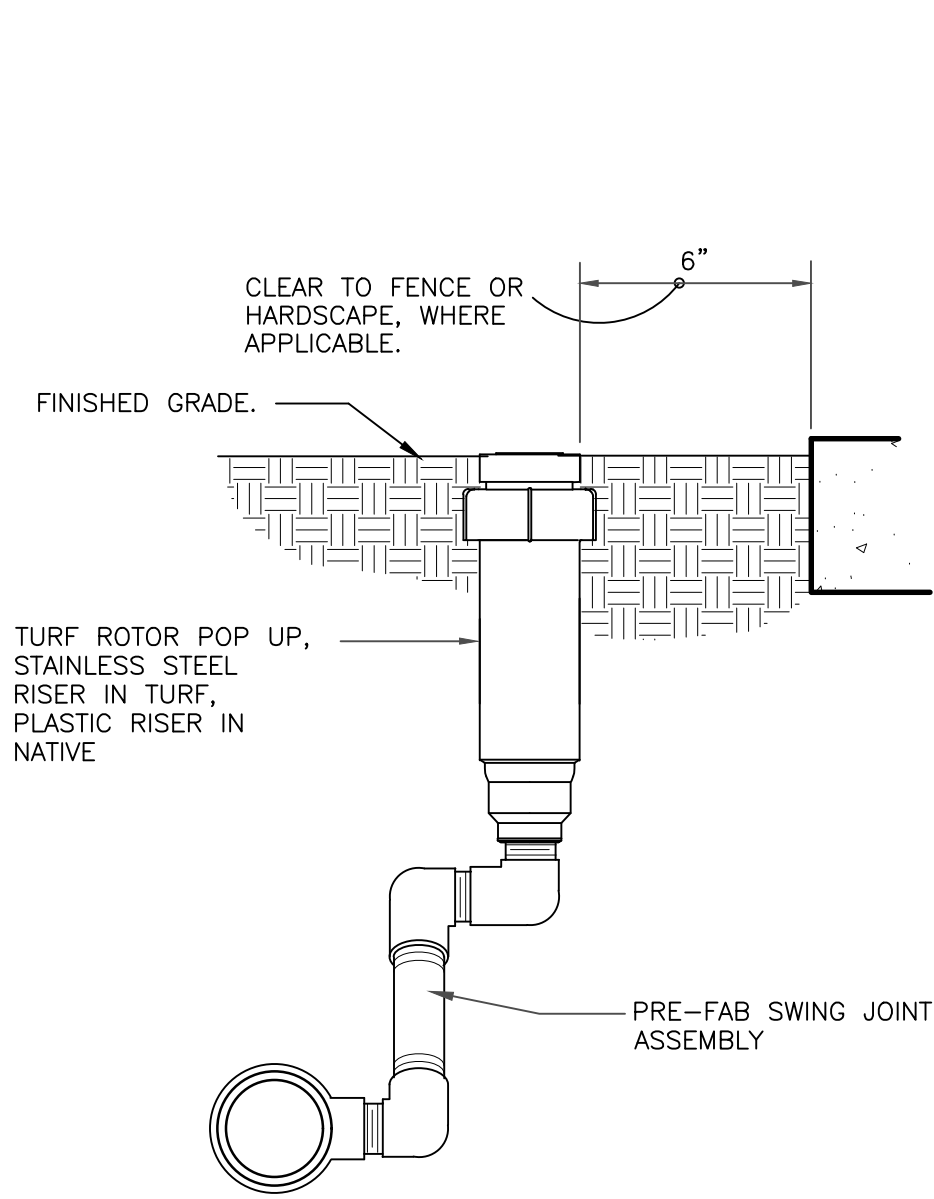
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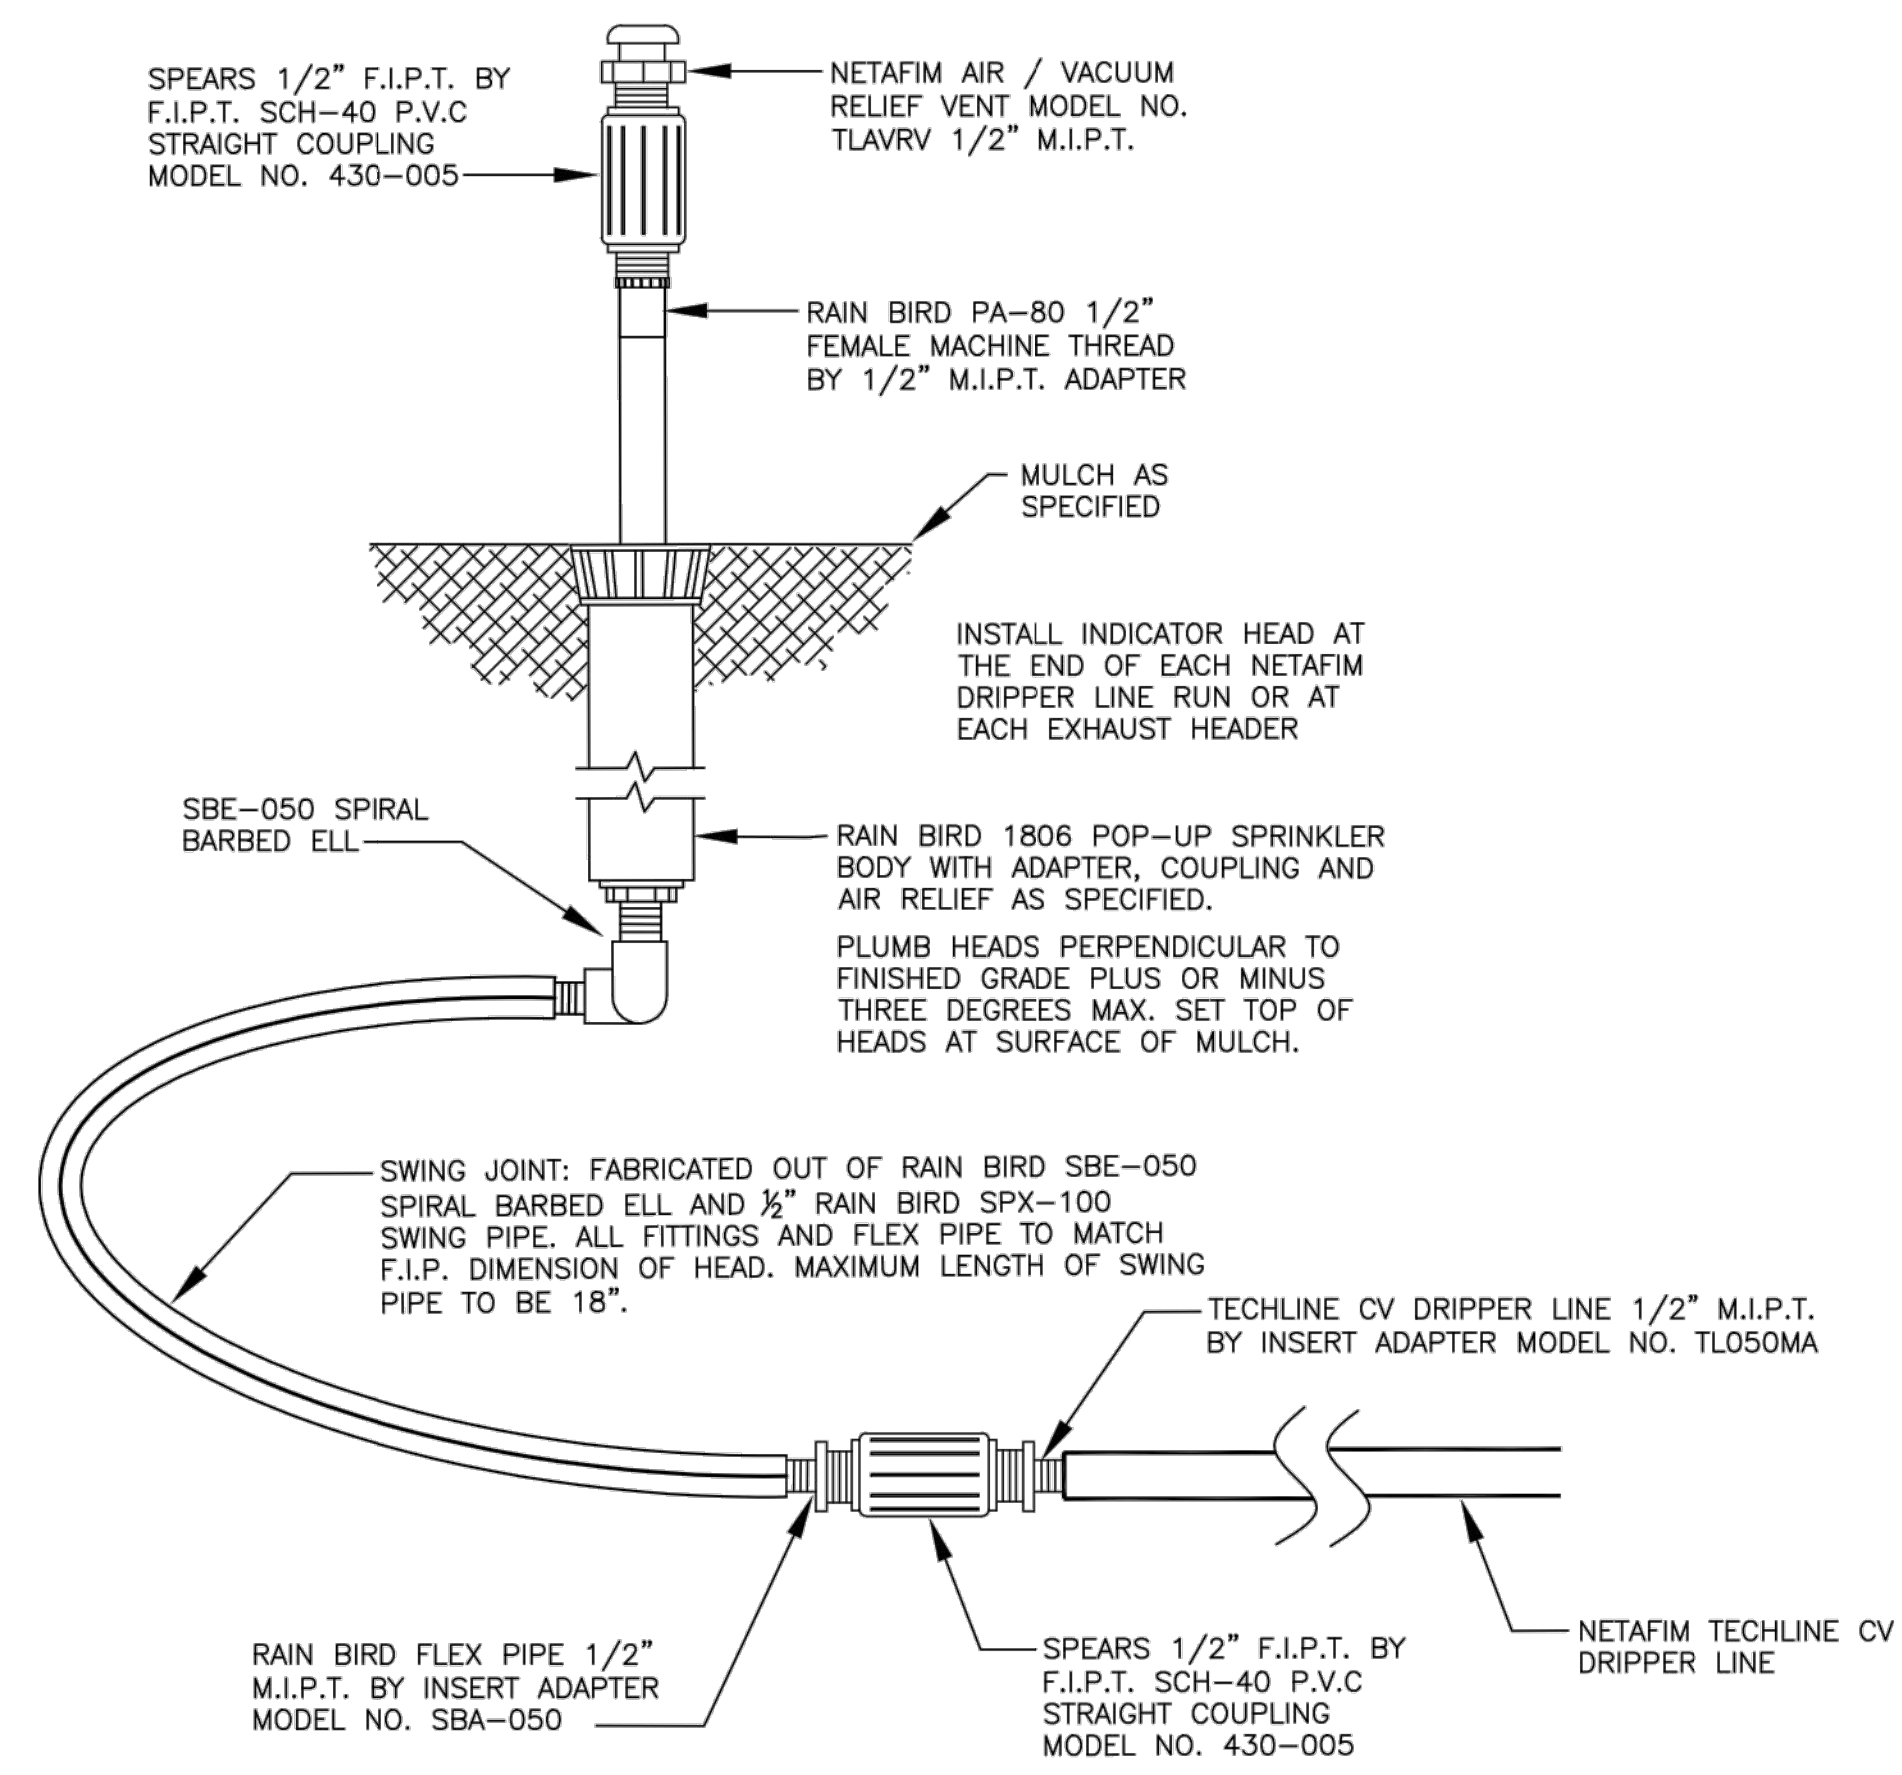
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TRAILS AT CROWFOOT
 PARK PLANS
 PARKER, COLORADO
 IRRIGATION PLANS


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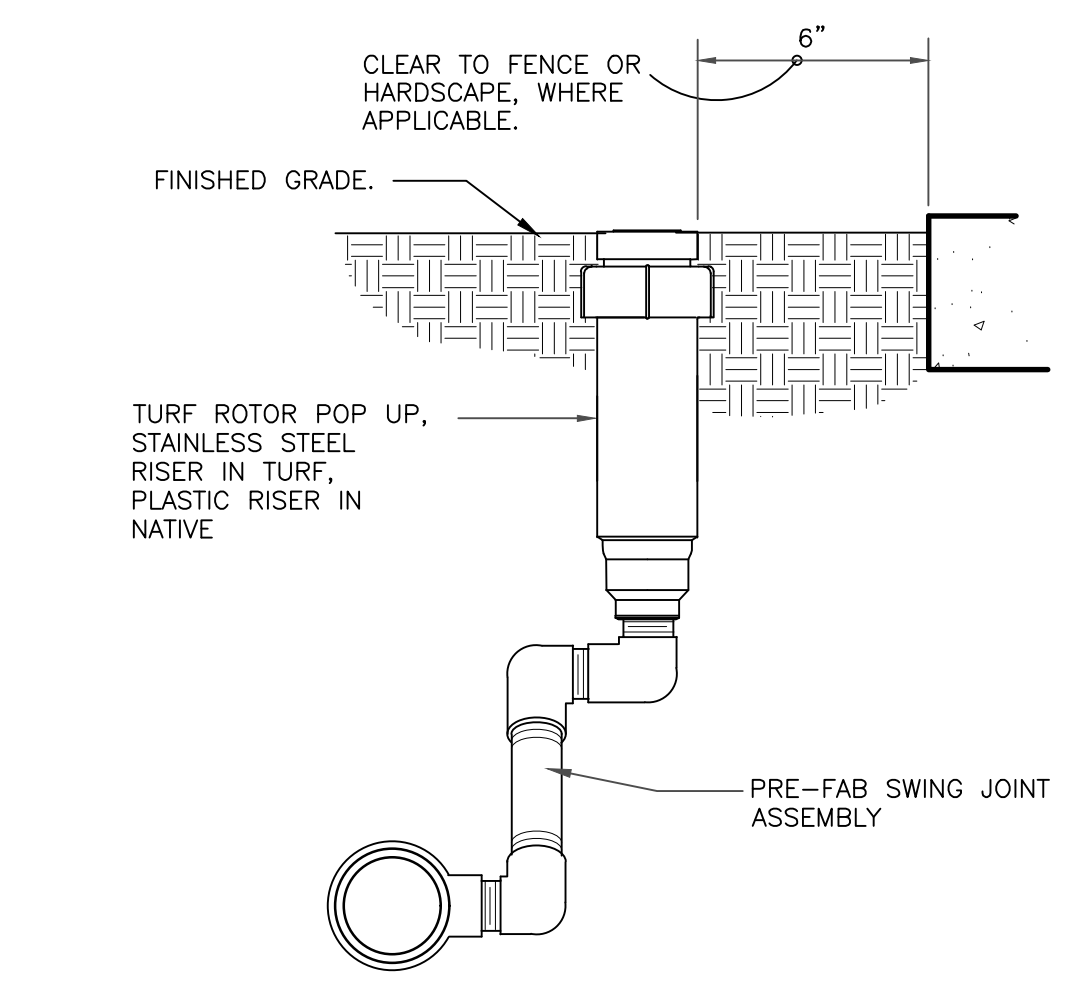
9 GEAR-DRIVEN ROTOR ASSEMBLY
 3" = 1'-0" 328403.16-01




A INDICATOR HEAD FOR NETAFIM CV DRIPPER LINE ZONES
 1.5 NO SCALE



B WIRE SPLICE ACCESS LOOP
 1.5 NO SCALE

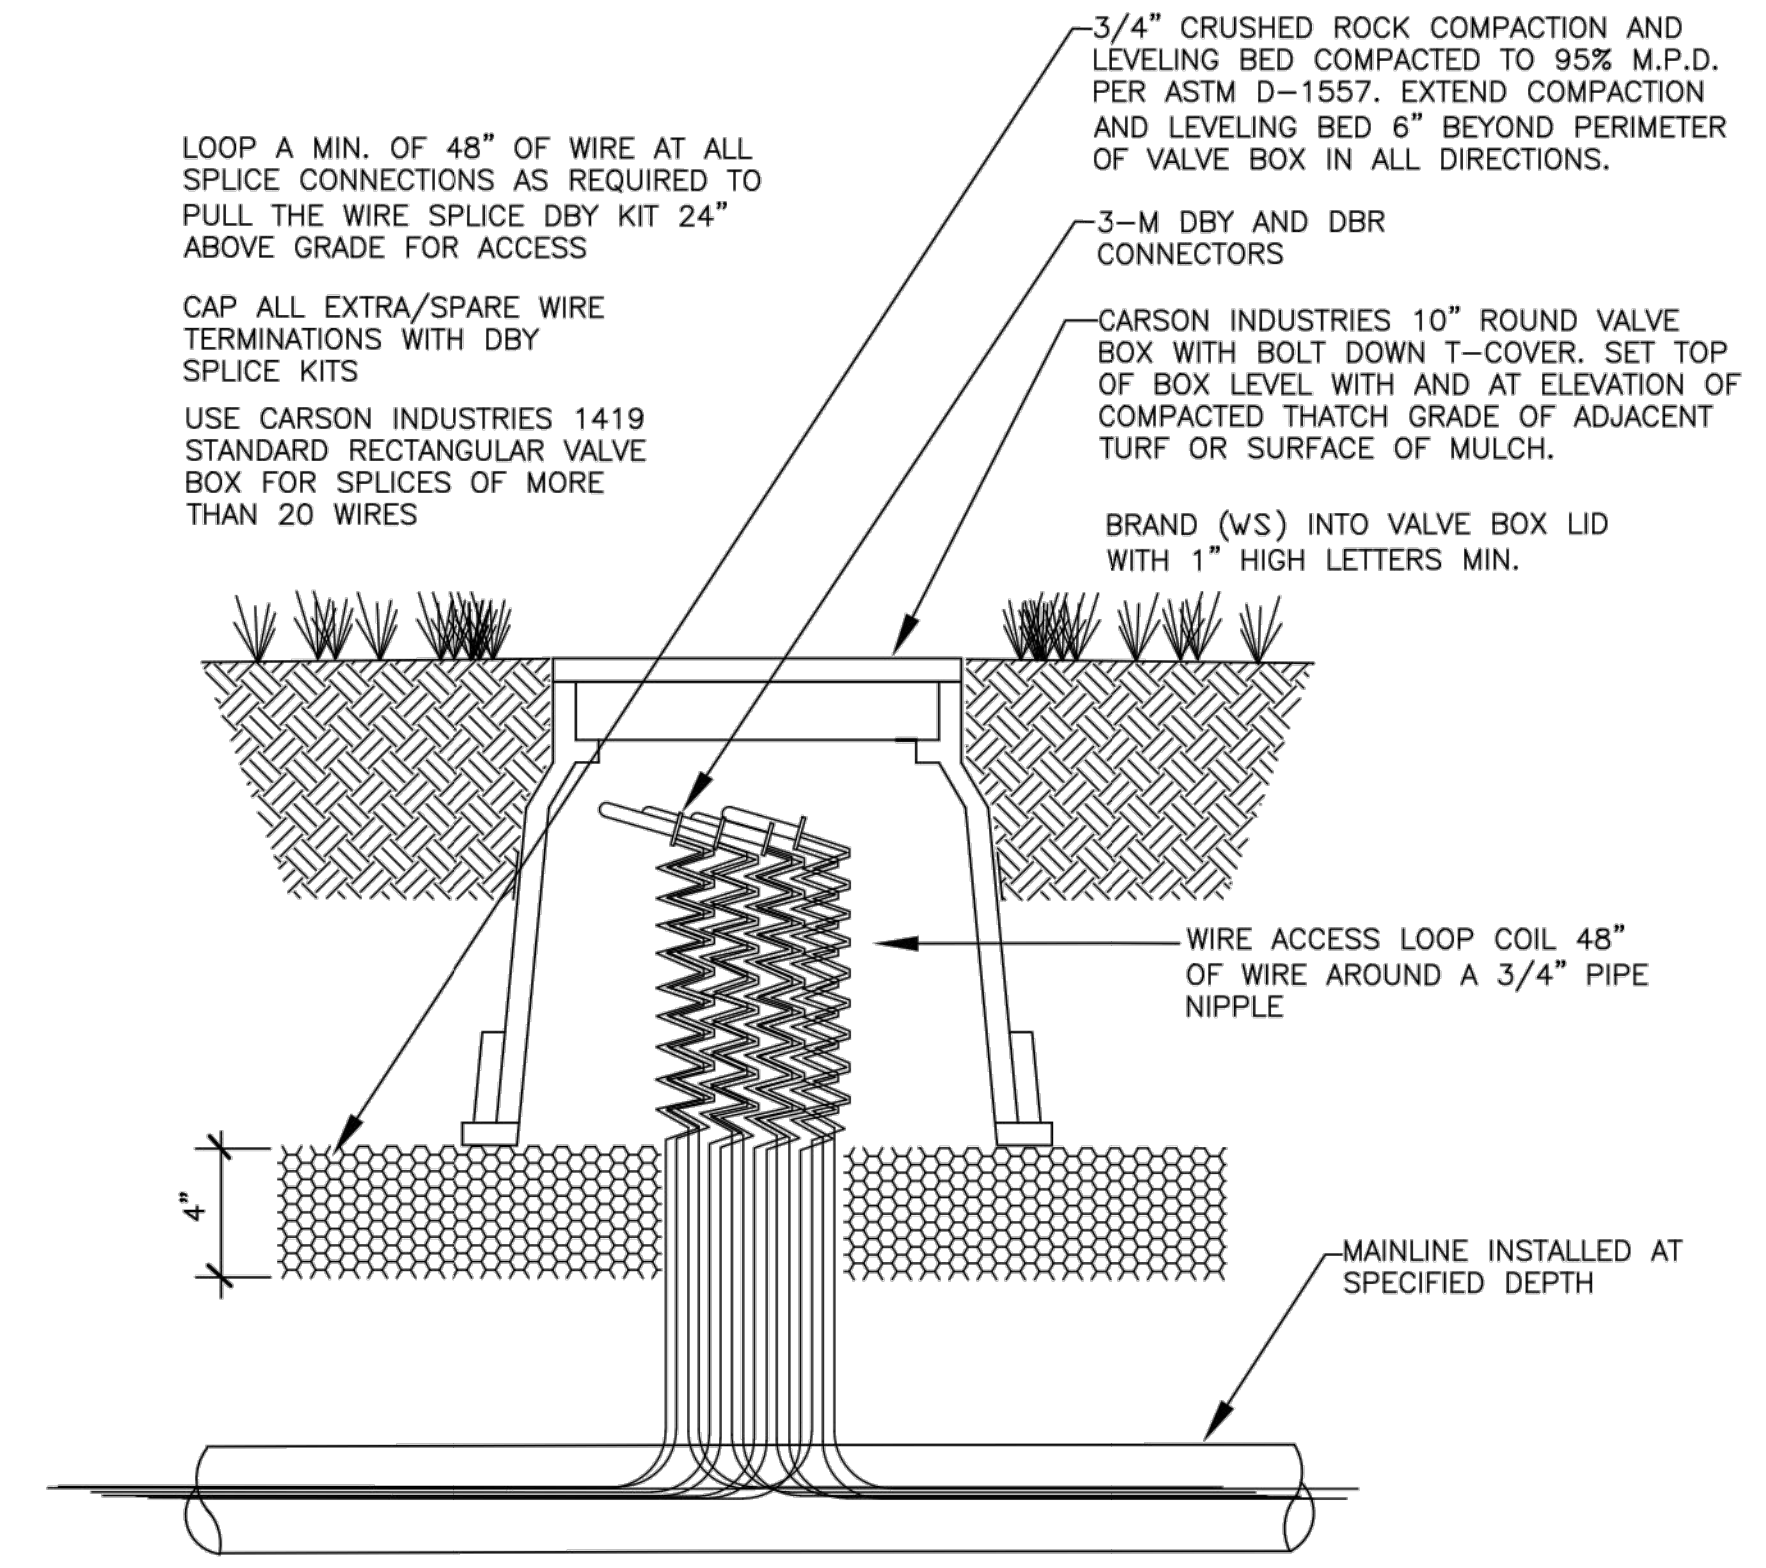

10 GEAR-DRIVEN ROTOR ASSEMBLY
 3" = 1'-0" 328403.16-01

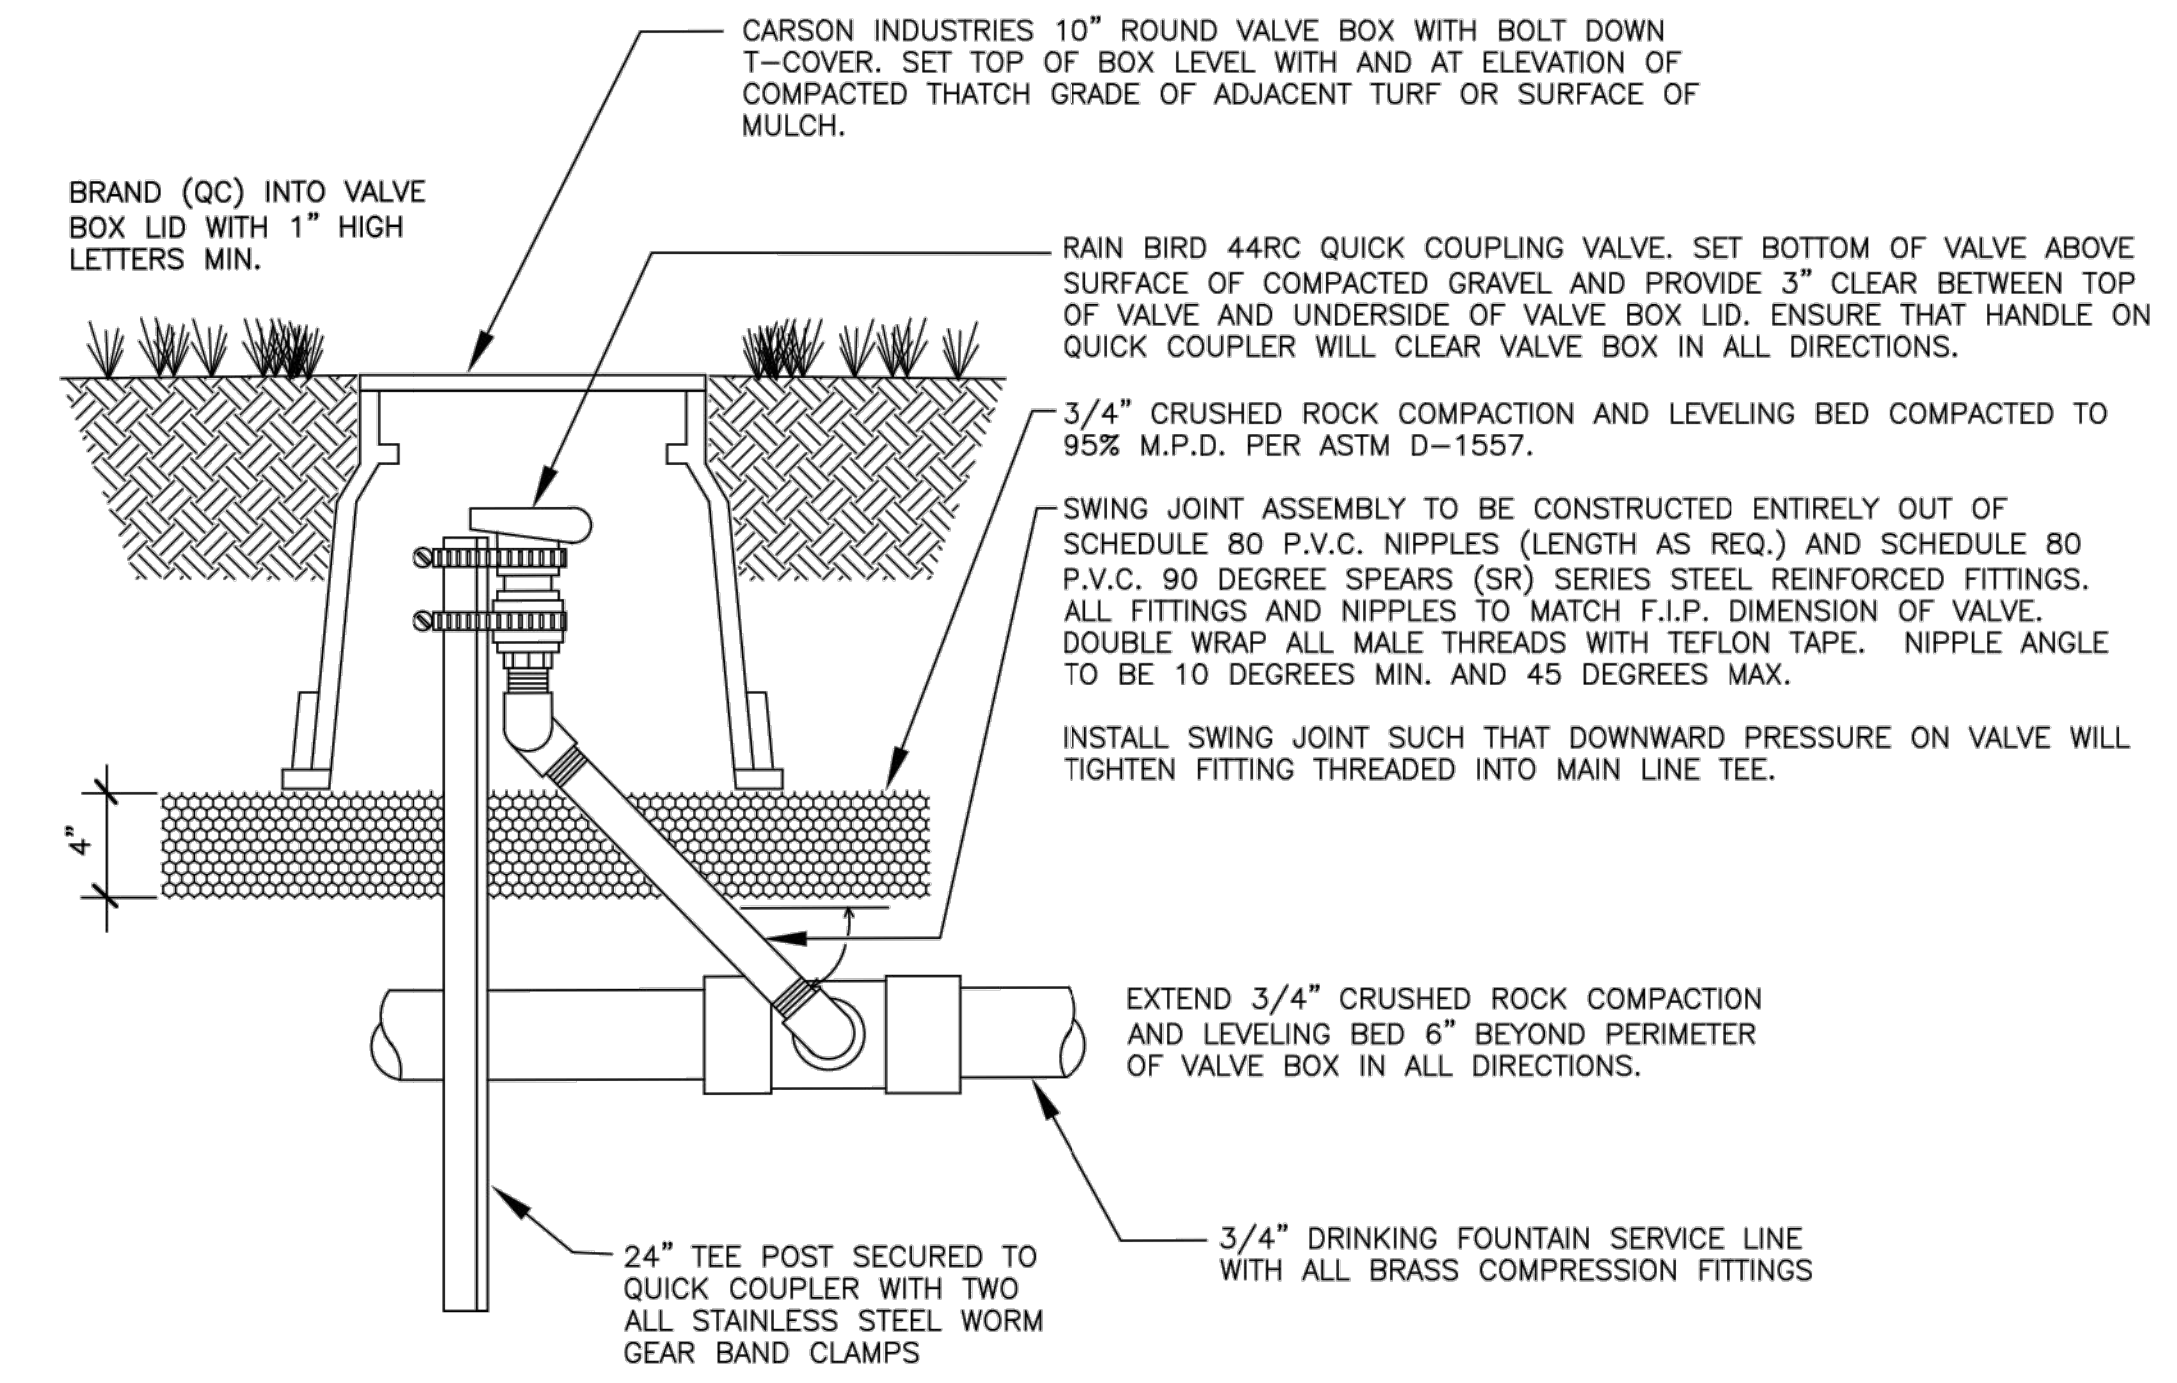

C QUICK COUPLER VALVE
 1.5 NO SCALE

